



SECTION A-A
N.T.S.

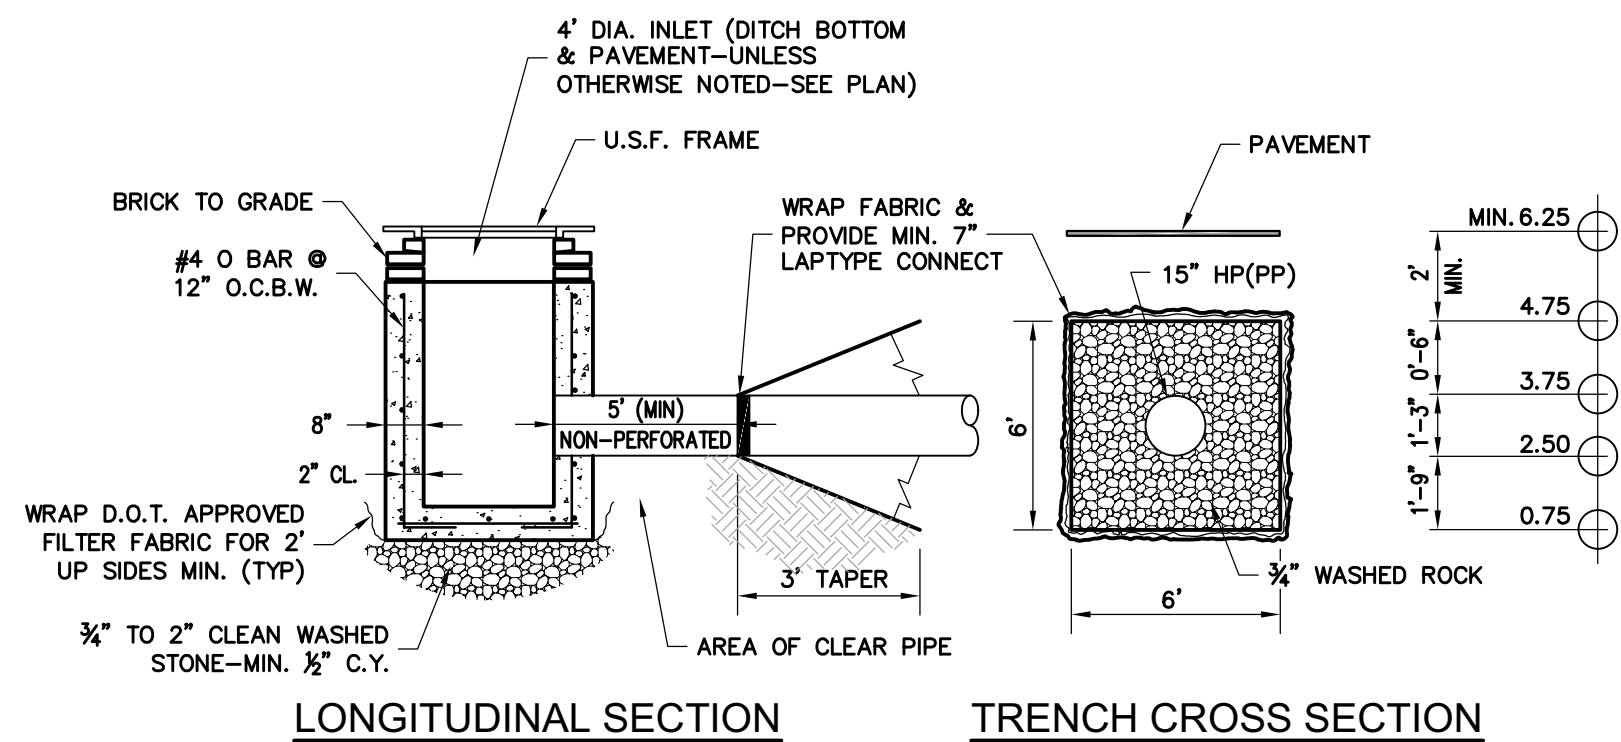


NOTE:
COMPACT TRENCH BACKFILL AND SOIL WITHIN MIN.
5' OFF TRENCH TO MIN. 95% OF MAX. DRY DENSITY PER
ASTM D-1557.


6" WIDE EXFILTRATION TRENCH DETAIL

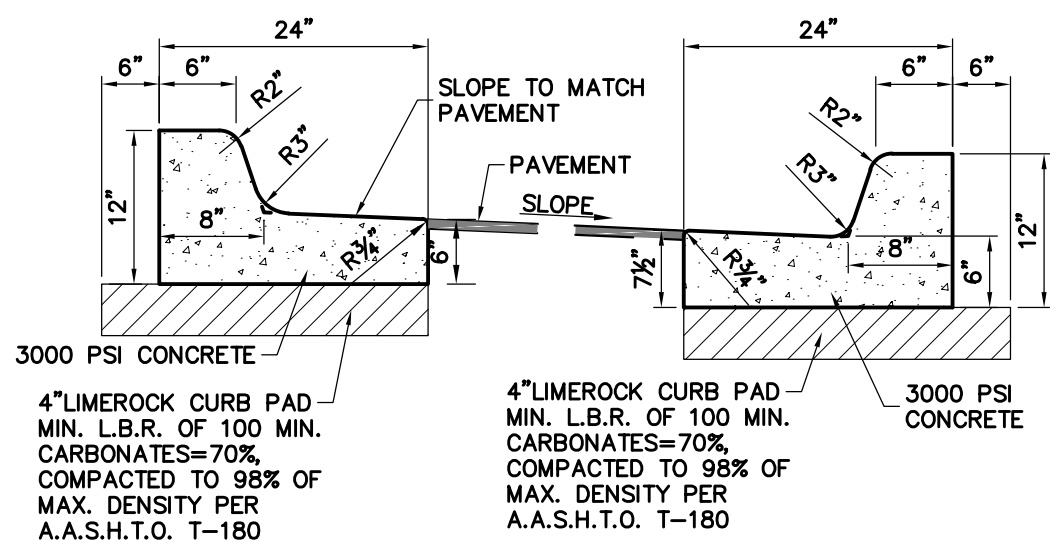


TYPE "F" CURB AND GUTTER
N.T.S.

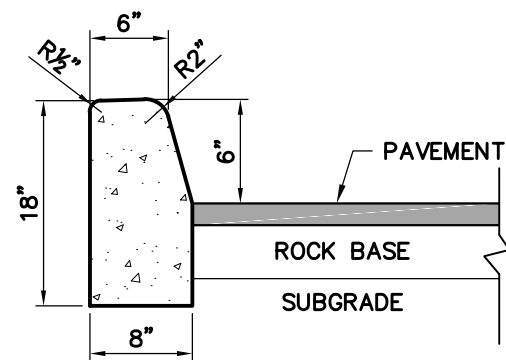

TYPE "D" CURB
N.T.S.

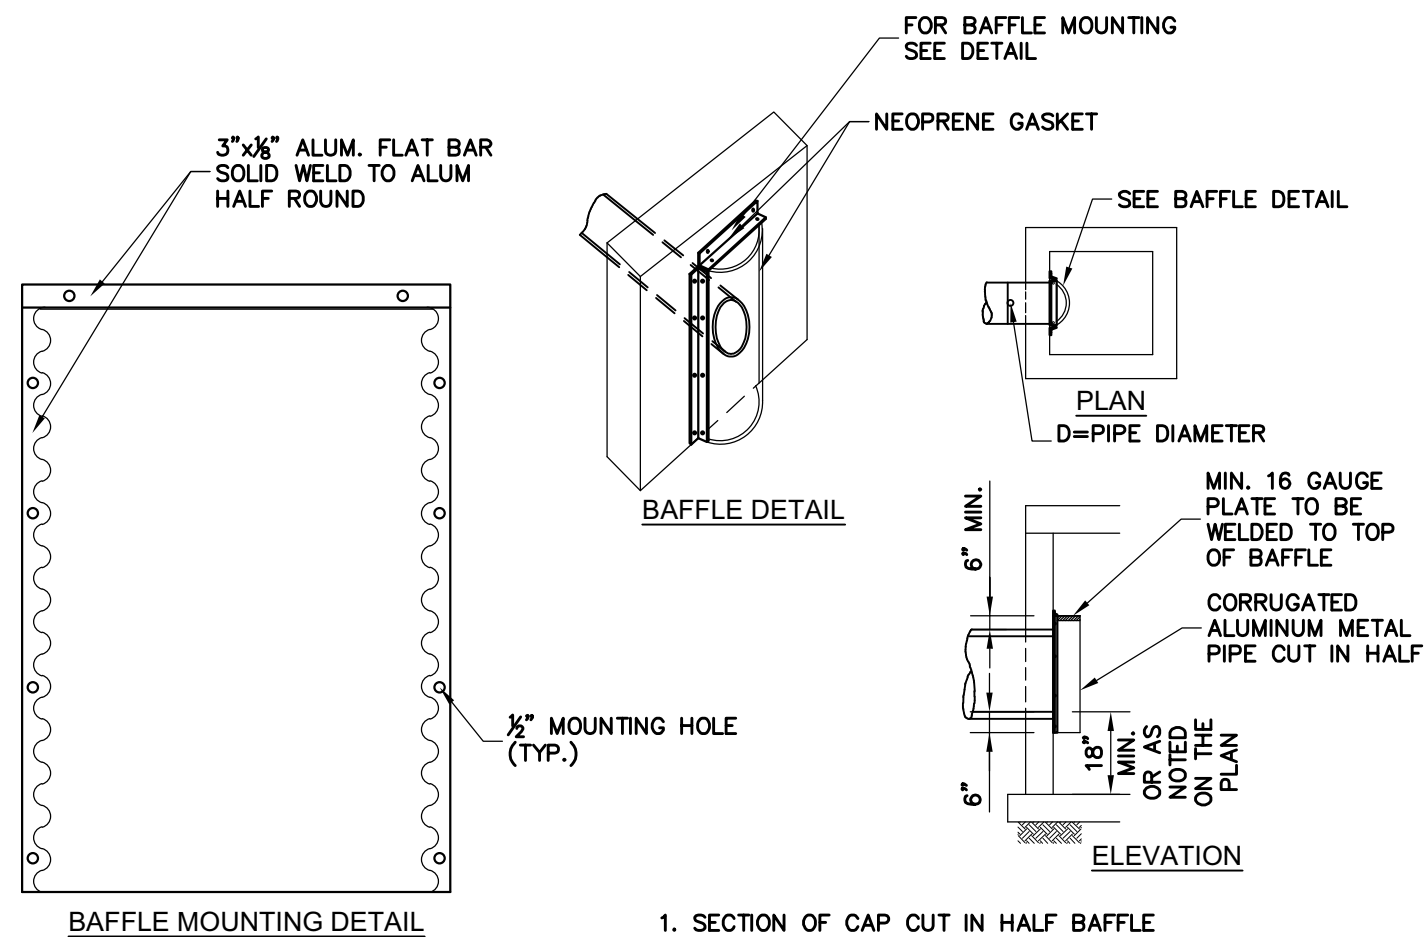


POLLUTION RETARDANT BASIN
(ALL STRUCTURES SEE PLAN FOR BAFFLE LOCATION)

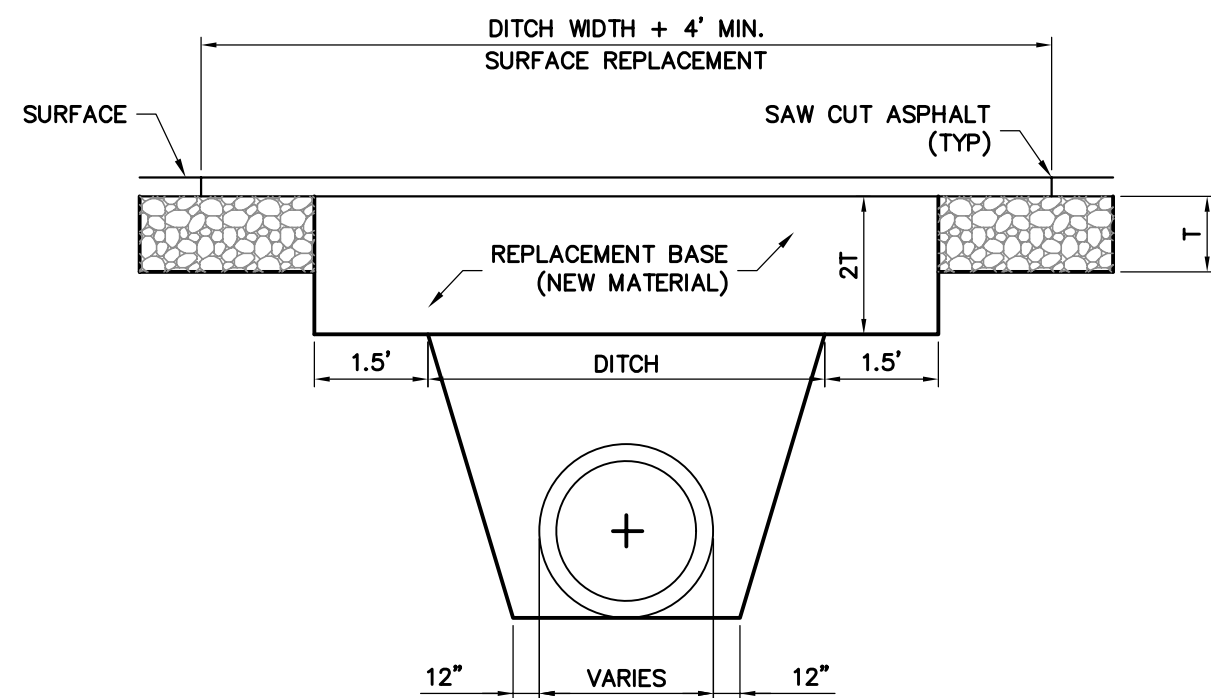

- GENERAL NOTES:
1. REPLACED BASE MATERIAL OVER DITCH SHALL BE TWICE THE THICKNESS OF THE ORIGINAL BASE, MINIMUM 8", MAXIMUM 18".
 2. BASE MATERIAL SHALL BE PLACED IN 6" MAXIMUM (LOOSE MEASUREMENT) LAYERS AND EACH LAYER THOROUGHLY ROLLED OR TAMPED TO 98% OF MAXIMUM DENSITY, PER AASHTO T-180.
 3. ASPHALT CONCRETE PAVEMENT JOINTS SHALL BE MECHANICALLY SAWED.
 4. SURFACE MATERIAL SHALL BE CONSISTENT WITH THE SURROUNDING SURFACE MATERIAL.
 5. BASE MATERIAL SHALL HAVE A MINIMUM LBR OF 100 AND A MINIMUM CARBONATE CONTENT OF 70% (60% FOR LOCAL STREETS).
 6. IF THE DITCH IS FILLED TEMPORARILY, IT SHALL COVERED WITH A 2" THICK ASPHALTIC CONCRETE PATCH TO KEEP THE FILL MATERIAL FROM RAVELING, UNTIL REPLACED WITH A PAVEMENT PATCH.

PAVEMENT RESTORATION DETAIL

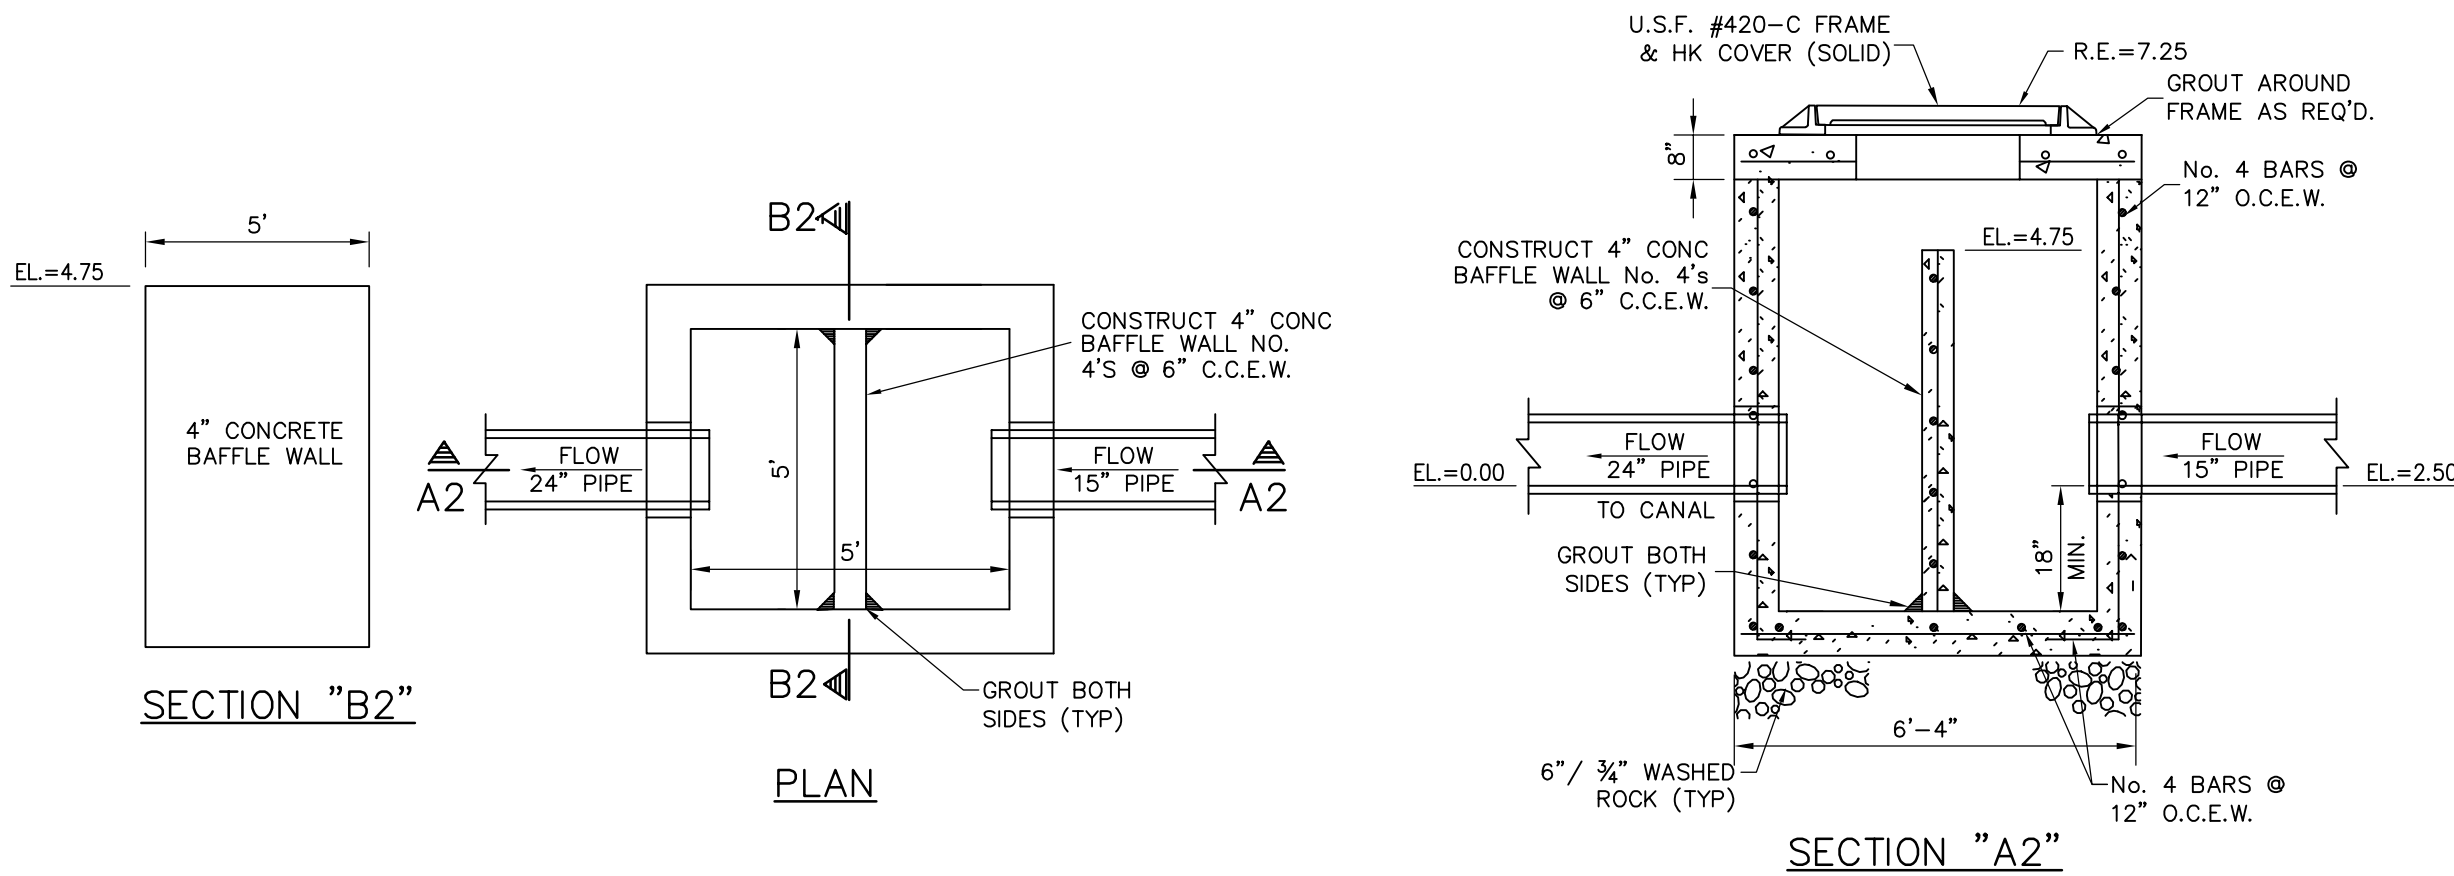

WATER QUALITY CONTROL STRUCTURE #D3 DETAIL
N.T.S.

4577 Nob Hill Road, Suite 102
Sunrise, FL 33351
www.suntecheng.com
Certificate of Auth. #7057LB 7019
Phone (954) 777-3123
Fax (954) 777-3114

Sun-Tech
Engineering, Inc.
Engineers - Planners - Surveyors



NO.	DATE	DESCRIPTION

3081 MCNAB WAREHOUSE
CITY OF POMPANO BEACH
FLORIDA
SCHEMATIC PAVING
& DRAINAGE PLAN

DATE: 04/2024
SCALE: 1"=20'
DESIGNED BY: F.V.
DRAWN BY: A.V.
JOB #: 23-4215

FEDERICO F. VALENCIA
P.E.
No. 91126
STATE OF FLORIDA
PROFESSIONAL ENGINEER
Date: September 11, 2024
This item has been digitally signed and sealed by FEDERICO F. VALENCIA, P.E. on the date adjacent to the seal. Printed copies of this document are not considered signed and sealed and signature must be on electronic copies.



DRC
PZ24-12000016
10/16/2024