



Plotted By: Millon, Teresa Sheet Set: BREWERY - LAYOUT: C1.10 DEMOLITION & EROSION CONTROL DETAILS June 20, 2023 06:38:39pm K:\FTL-Civil\044-Jobs\044203010-Express Nook\CAD\PlantSheet - Brew Fish Brewery\C1.10 DEMOLITION & EROSION CONTROL DETAILS.dwg  
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### CHAIN LINK FENCE INSTALLATION DETAILS

NOTE:  
ALL FENCE POST INSTALATIONS MUST MEET ALL FLORIDA BUILDING CODES


ENGINEERING STANDARDS 2022			
REVISIONS		ENGINEERING DIVISION CITY OF POMPAÑO BEACH	CHAIN LINK FENCE
BY	DATE		
		SCALE: N.T.S.	DATE: MAY 2022 DWG. NO. <b>303-2</b>

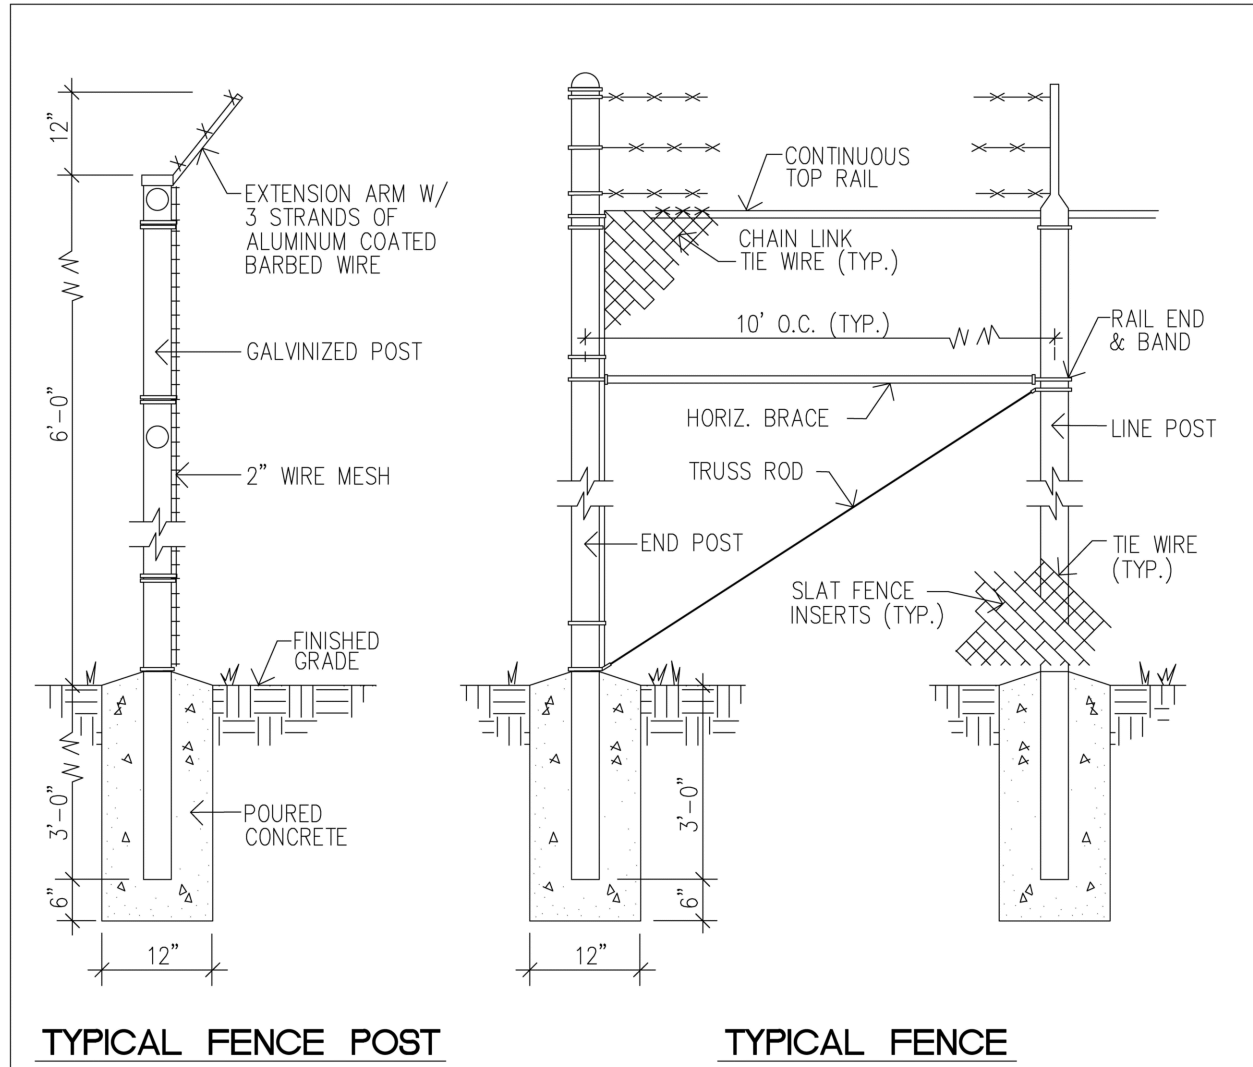

### CHAIN LINK FENCE

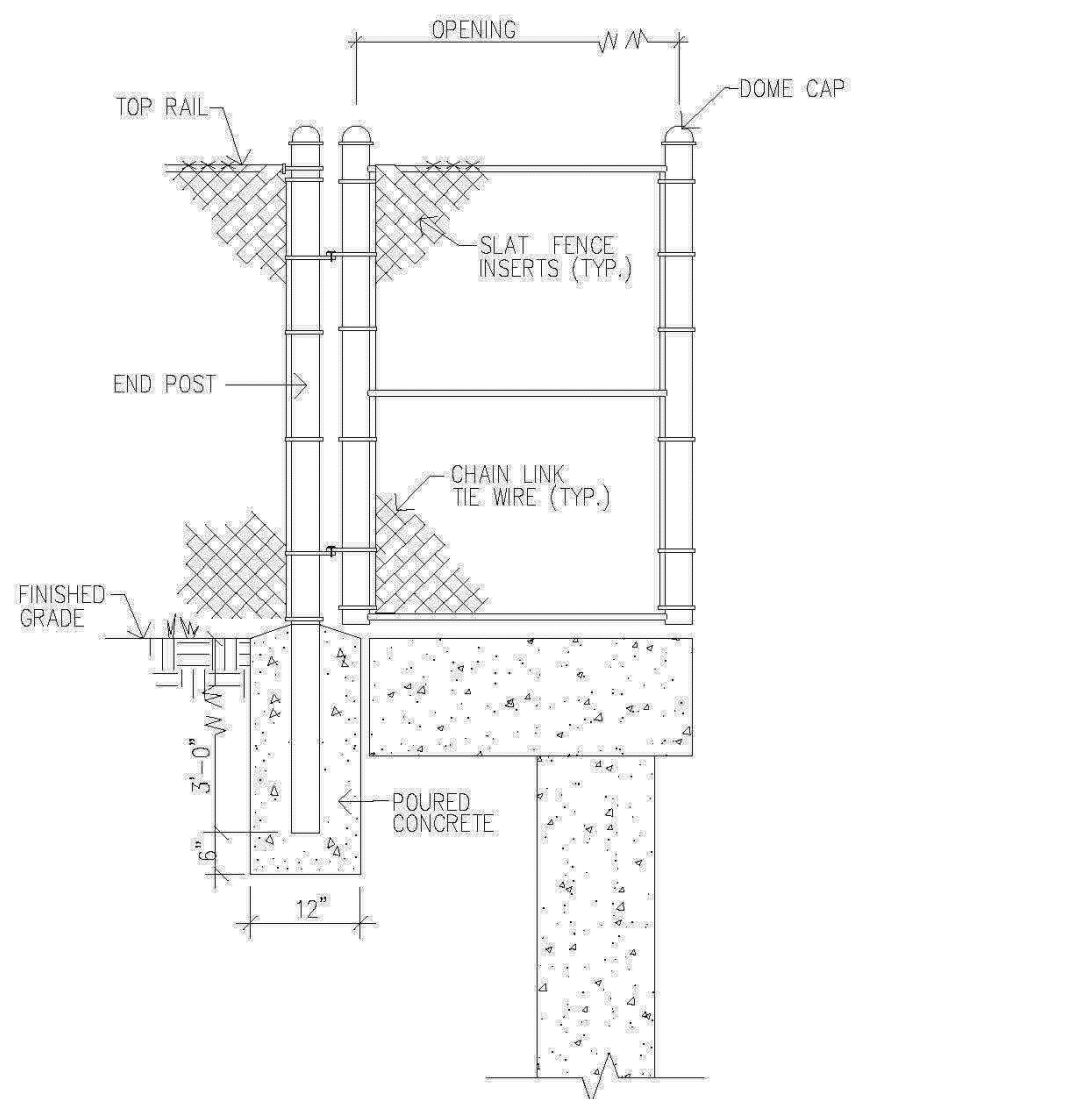NOTE:  
ALL FENCE POST INSTALATIONS MUST MEET ALL FLORIDA BUILDING CODES

ENGINEERING STANDARDS 2022			
REVISIONS		ENGINEERING DIVISION CITY OF POMPAÑO BEACH	CHAIN LINK FENCE
BY	DATE		
		SCALE: N.T.S.	DATE: MAY 2022 DWG. NO. <b>303-4</b>

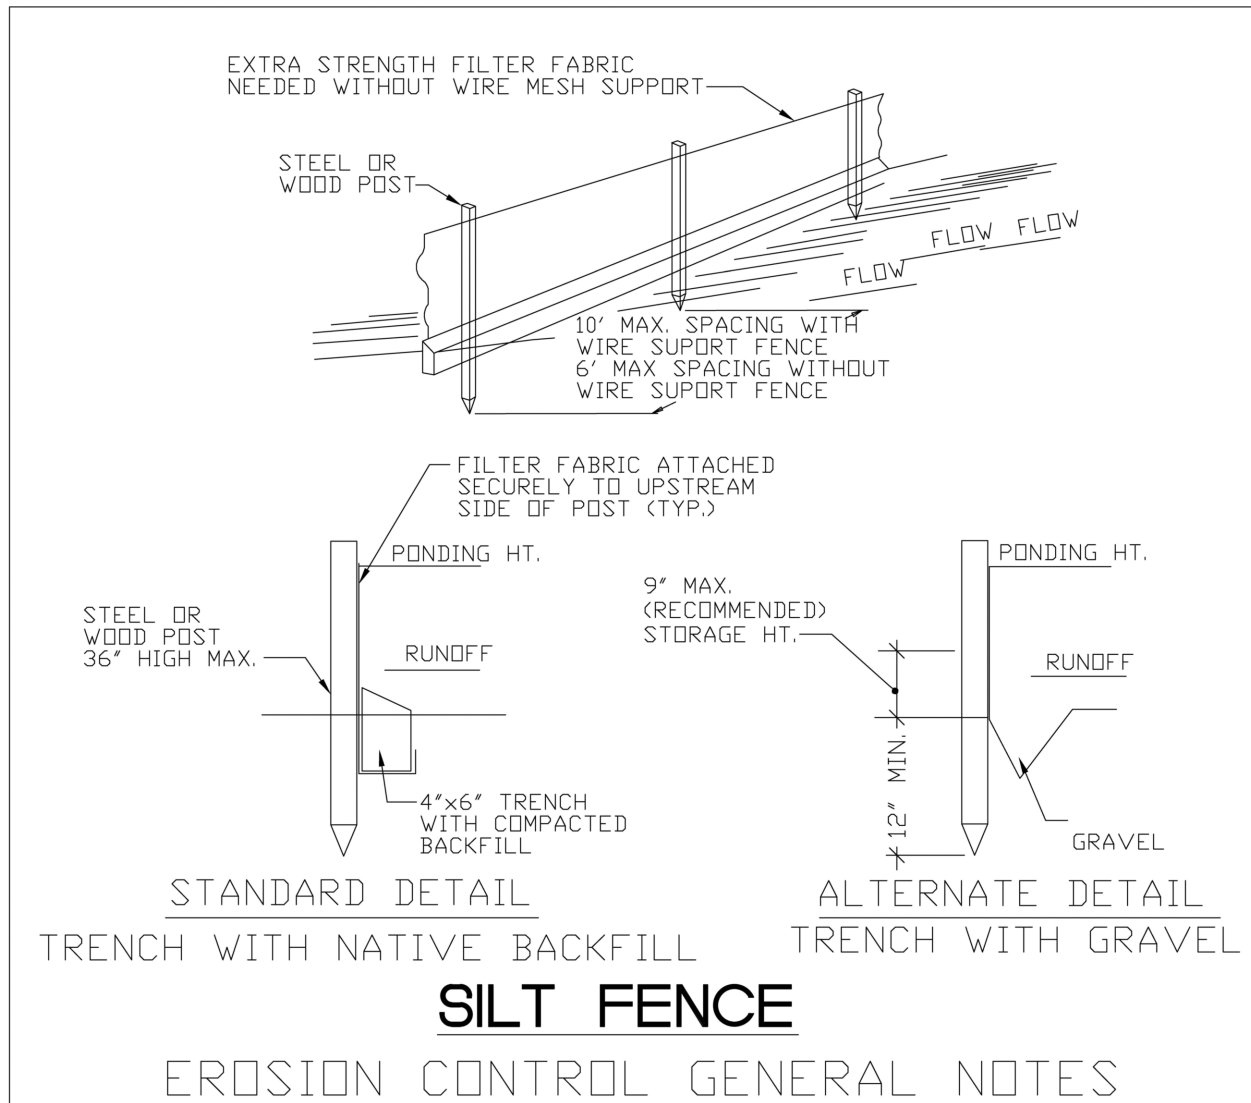


### SILT FENCE

### EROSION CONTROL GENERAL NOTES

1. SILT FENCE AND TURBIDITY BARRIERS MUST REMAIN IN PLACE AND BE MAINTAINED AT ALL LOCATIONS SHOWN IN THE DRAWINGS UNTIL CONSTRUCTION IS COMPLETED AND SOILS ARE STABILIZED AND VEGETATION HAS BEEN.
2. CONTRACTOR SHALL SUBMIT SCHEDULE FOR THE INSTALLATION, INSPECTION AND MAINTENANCE OF THE EROSION CONTROL FEATURES AS SHOWN IN THE DRAWINGS OR AS DIRECTED BY THE DESIGN ENGINEER. THE SCHEDULE SHALL SPECIFICALLY INDICATE THE SEQUENCE OF CLEARING, EARTH WORK OPERATIONS, AND WHEN THE EROSION CONTROL FEATURE WILL BE INSTALLED, INSPECTED, AND MAINTAINED. IT SHALL ALSO INCLUDE METHODS TO PREVENT POLLUTION OF STREAM, LAKES, TIDAL WATERS, CANALS, AND IMPOUNDMENTS. ESTABLISHED.

### ENGINEERING STANDARDS 2022

REVISIONS		ENGINEERING DIVISION CITY OF POMPAÑO BEACH	SILT FENCE
BY	DATE		
		SCALE: N.T.S.	DATE: MAY 2022 DWG. NO. <b>509-1</b>

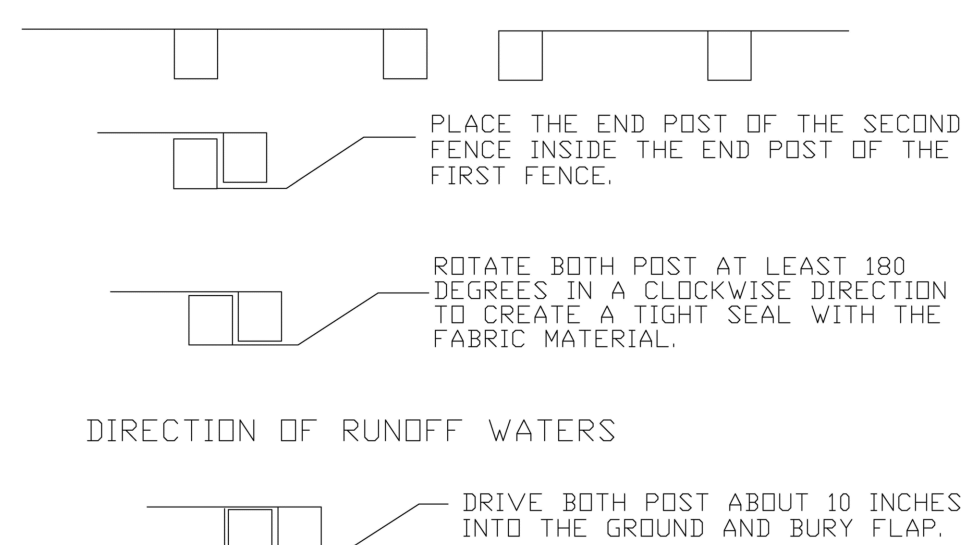


- NOTES:
1. INSPECT AND REPAIR FENCE AFTER EACH STORM EVENT AND REMOVE SEDIMENT WHEN NECESSARY.
  2. REMOVED SEDIMENT SHALL BE DEPOSITED TO AN AREA THAT WILL NOT CONTRIBUTE SEDIMENT OFF-SITE AND CAN BE PERMANENTLY STABILIZED.
  3. SILT FENCE SHALL BE PLACED ON SLOPE CONTOURS TO MAXIMIZE PONDING EFFICIENCY.

### ATTACHING TWO SILT FENCES

### ENGINEERING STANDARDS 2022


REVISIONS		ENGINEERING DIVISION CITY OF POMPAÑO BEACH	ATTACHING TWO SILT FENCES
BY	DATE		
		SCALE: N.T.S.	DATE: MAY 2022 DWG. NO. <b>509-2</b>

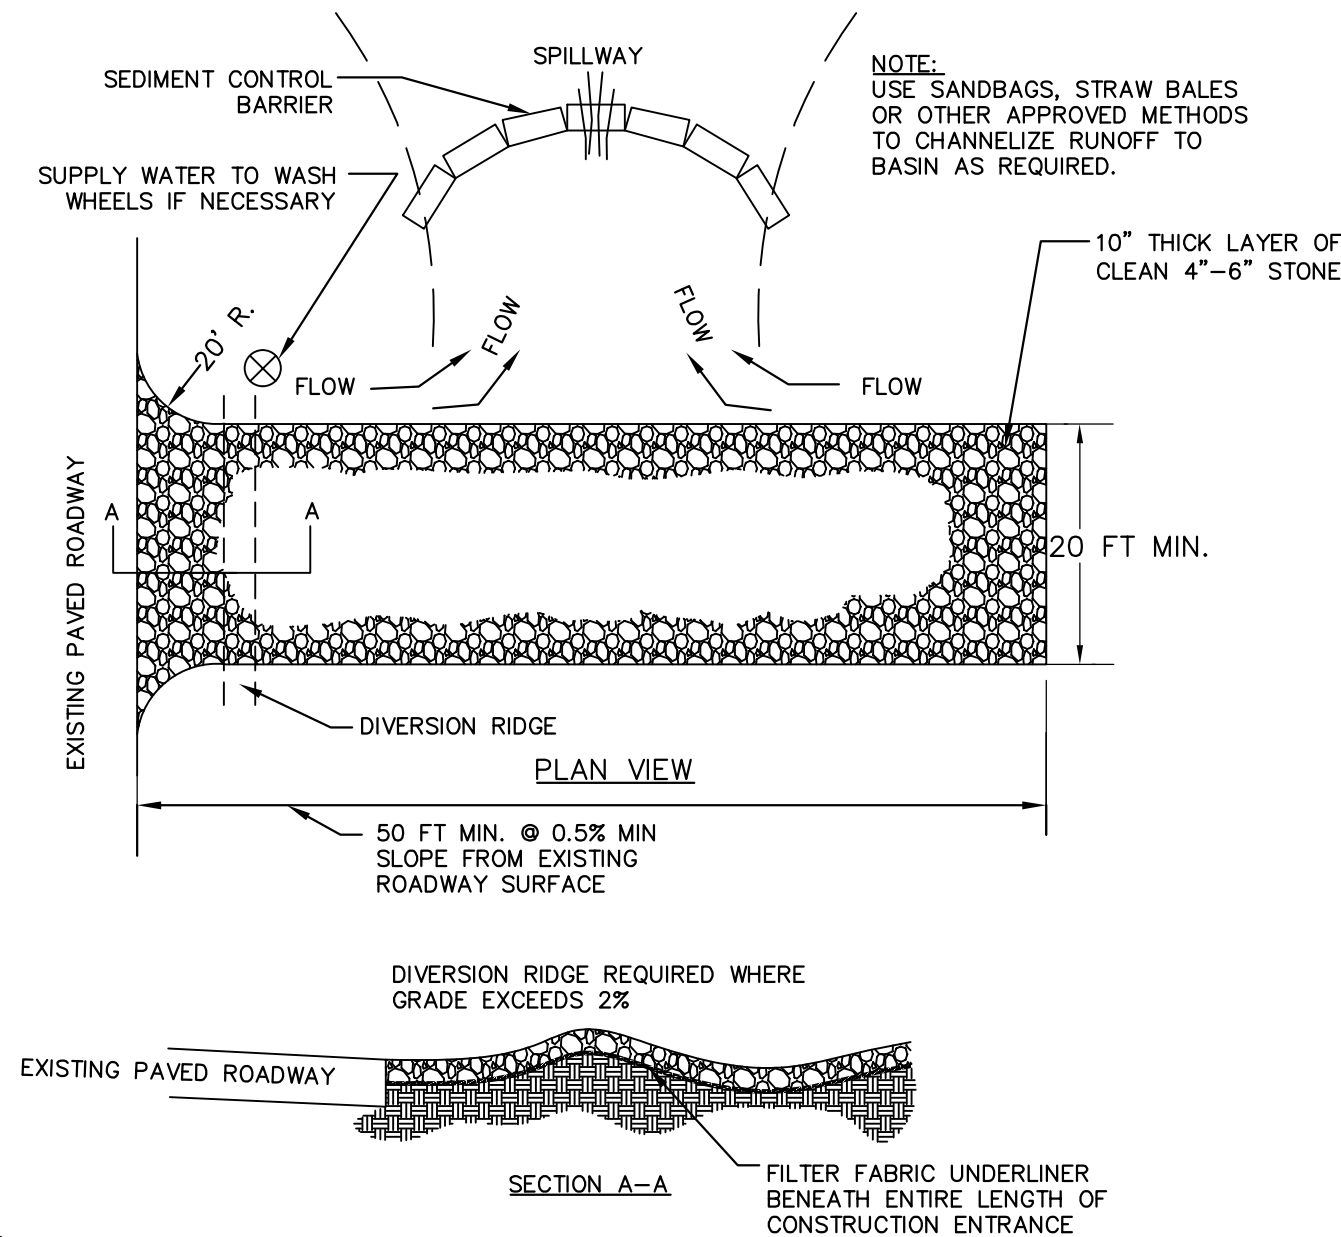

### NOTES:

1. THE ENTRANCE SHALL BE MAINTAINED IN A CONDITION THAT WILL PREVENT TRACKING OR FLOWING OF SEDIMENT ONTO PUBLIC RIGHTS-OF-WAY. THIS MAY REQUIRE TOP DRESSING, REPAIR AND/OR CLEANOUT OF ANY MEASURES USED TO TRAP SEDIMENT.
2. WHEN NECESSARY, WHEELS SHALL BE CLEANED PRIOR TO ENTRANCE ONTO PUBLIC RIGHT-OF-WAY.
3. WHEN WASHING IS REQUIRED, IT SHALL BE DONE ON AN AREA STABILIZED WITH CRUSHED STONE THAT DRAINS INTO AN APPROVED SEDIMENT TRAP OR SEDIMENT BASIN.


### 1 STABILIZED CONSTRUCTION ENTRANCE N.T.S.

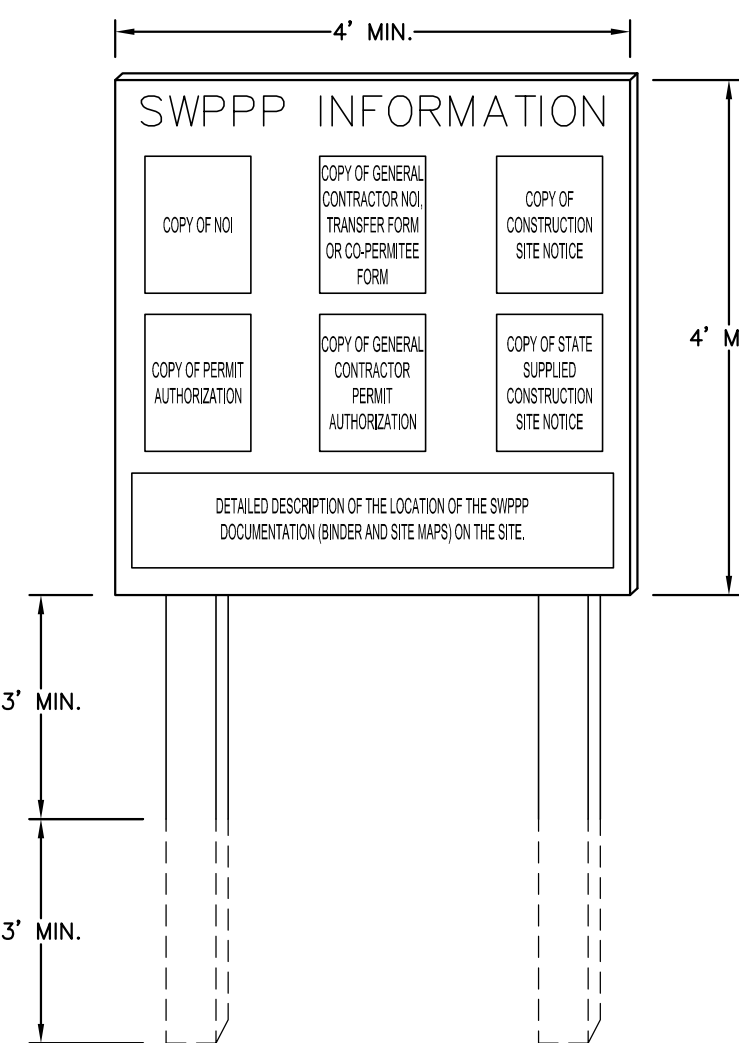

### NOTES:

1. "SWPPP INFORMATION" MUST BE DISPLAYED PROMINENTLY ACROSS THE TOP OF THE SIGN, AS SHOWN IN THE DETAIL.
2. SIGN TO BE CONSTRUCTED OF A RIGID MATERIAL, SUCH AS PLYWOOD OR OUTDOOR SIGN BOARD. SIGN MUST BE CONSTRUCTED IN A MANNER TO PROTECT DOCUMENTS FROM DAMAGE DUE TO WEATHER (WIND, SUN, MOISTURE, ETC.).
3. THE SWPPP INFORMATION SIGN MUST BE LOCATED NEAR THE ENTRANCE/EXIT OF THE SITE, SUCH THAT IT IS ACCESSIBLE/VISIBLE BY THE GENERAL PUBLIC, BUT NOT OBSTRUCTING VIEWS AS TO CAUSE A SAFETY HAZARD.
4. ALL POSTED DOCUMENTS MUST BE MAINTAINED IN A CLEARLY READABLE CONDITION AT ALL TIMES THROUGHOUT CONSTRUCTION AND UNTIL THE NOTICE-OF-TERMINATION (NOT) IS FILED FOR THE PERMIT.
5. CONTRACTOR SHALL POST OTHER STORM WATER AND/OR EROSION AND SEDIMENT CONTROL RELATED PERMITS ON THE SIGN AS REQUIRED BY THE LOCAL AGENCY.
6. SIGN SHALL BE LOCATED OUTSIDE OF PUBLIC RIGHT-OF-WAY AND EASEMENTS UNLESS APPROVED BY THE GOVERNING AGENCY.
7. CONTRACTOR IS RESPONSIBLE FOR ENSURING STABILITY OF THIS SWPPP INFORMATION SIGN.

### 2 SWPP INFORMATION SIGN N.T.S.

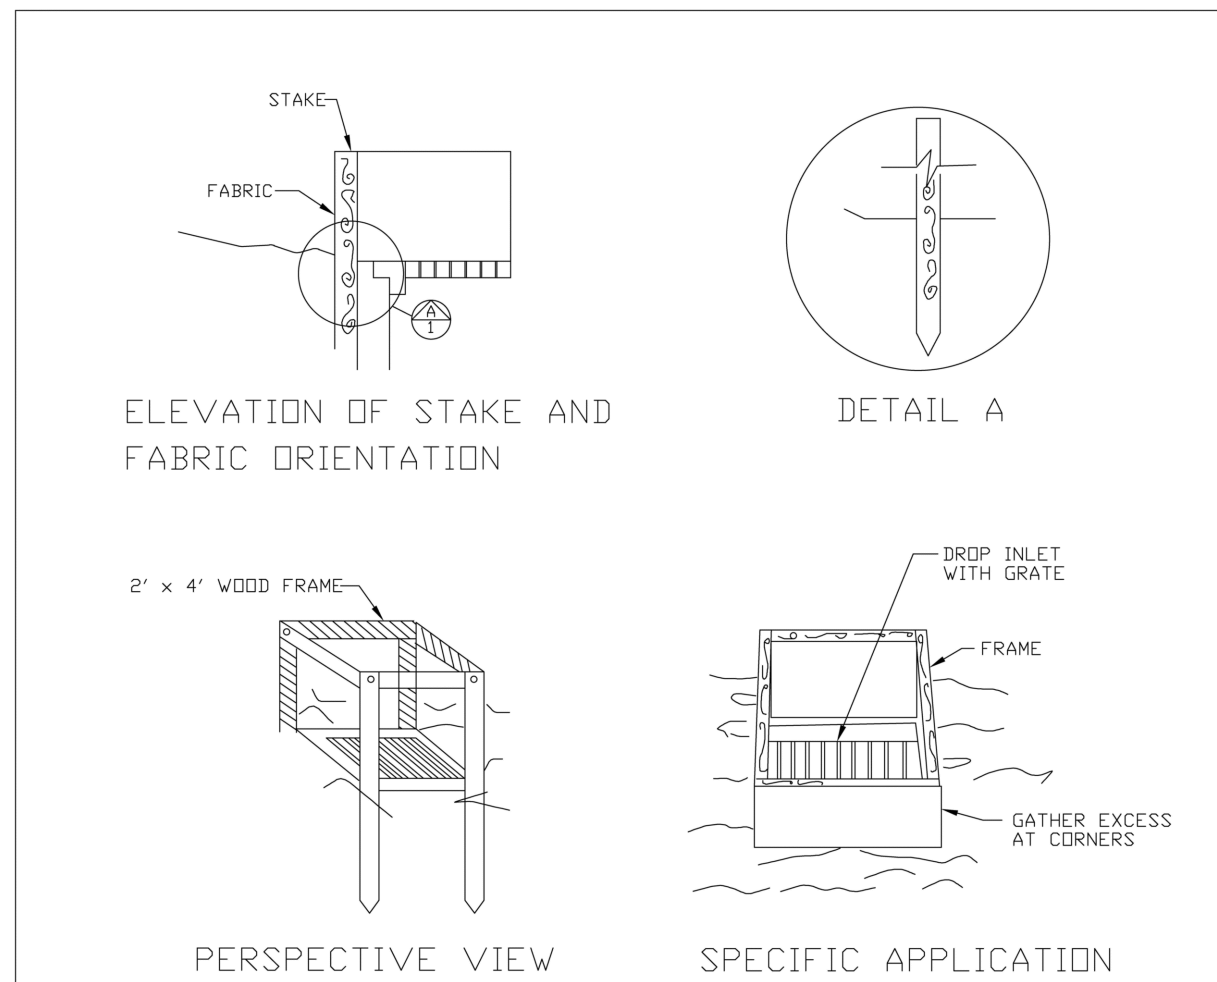

THIS METHOD OF INLET PROTECTION IS APPLICABLE WHERE THE INLET DRAINS A RELATIVELY FLAT AREA (SLOPE NO GREATER THAN 5%) WHERE THE INLET SHEET OR OVERLAND FLOWS (NOT EXCEEDING 1 C.F.S.) ARE TYPICAL. THE METHOD SHALL NOT APPLY TO INLETS RECEIVING CONCENTRATED FLOWS, SUCH AS IN STREET OR HIGHWAY MEDIANS

### FILTER FABRIC DROP INLET SEDIMENT FILTER

### ENGINEERING STANDARDS 2022

REVISIONS		ENGINEERING DIVISION CITY OF POMPAÑO BEACH	FILTER FABRIC DROP INLET SEDIMENT FILTER
BY	DATE		
		SCALE: N.T.S.	DATE: MAY 2022 DWG. NO. <b>508-1</b>

George Balaban  
Digitally signed by George Balaban  
Date: 2023.06.22 18:04:53 -04'00'

GEORGE BALABAN, STATE OF FLORIDA, PROFESSIONAL ENGINEER, LICENSE NO. 74543

THIS ITEM HAS BEEN DIGITALLY SIGNED AND SEALED BY GEORGE BALABAN, P.E. ON THE DATE INDICATED HERE.

PRINTED COPIES OF THE DOCUMENT ARE NOT CONSIDERED SIGNED AND SEALED AND THE SIGNATURE MUST BE VERIFIED ON ANY ELECTRONIC COPIES.

PLANS ARE IN NAVD 1988 DATUM  
CONVERSION EQUATION IS BELOW:  
(NAVD 1988) + 1.58' = (NGVD 1929)

THE PRESENCE OF GROUNDWATER SHOULD BE ANTICIPATED. CONTRACTOR'S BID SHALL INCLUDE CONSIDERATION FOR ADDRESSING THIS ISSUE AND OBTAINING ALL NECESSARY PERMITS.

Always call 811 two full business days before you start to have underground utilities located and marked.  
**Sunshine 811.com**

**DRC**  
223-12000029.10  
09/20/2023

DEMOLITION &  
EROSION CONTROL  
DETAILS

BREW FISH  
BREWERY  
PREPARED FOR  
CITY OF POMPAÑO BEACH

**Kimley»Horn**  
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WWW.KIMLEY-HORN.COM REGISTRY No. 35106

LICENSED PROFESSIONAL  
GEORGE BALABAN, P.E.  
FL LICENSE NUMBER  
74543

KHA PROJECT  
044203010  
DATE  
JUNE 2023  
SCALE AS SHOWN  
DESIGNED BY TVC  
DRAWN BY TVC  
CHECKED BY GB

REVISIONS  
No. BY DATE