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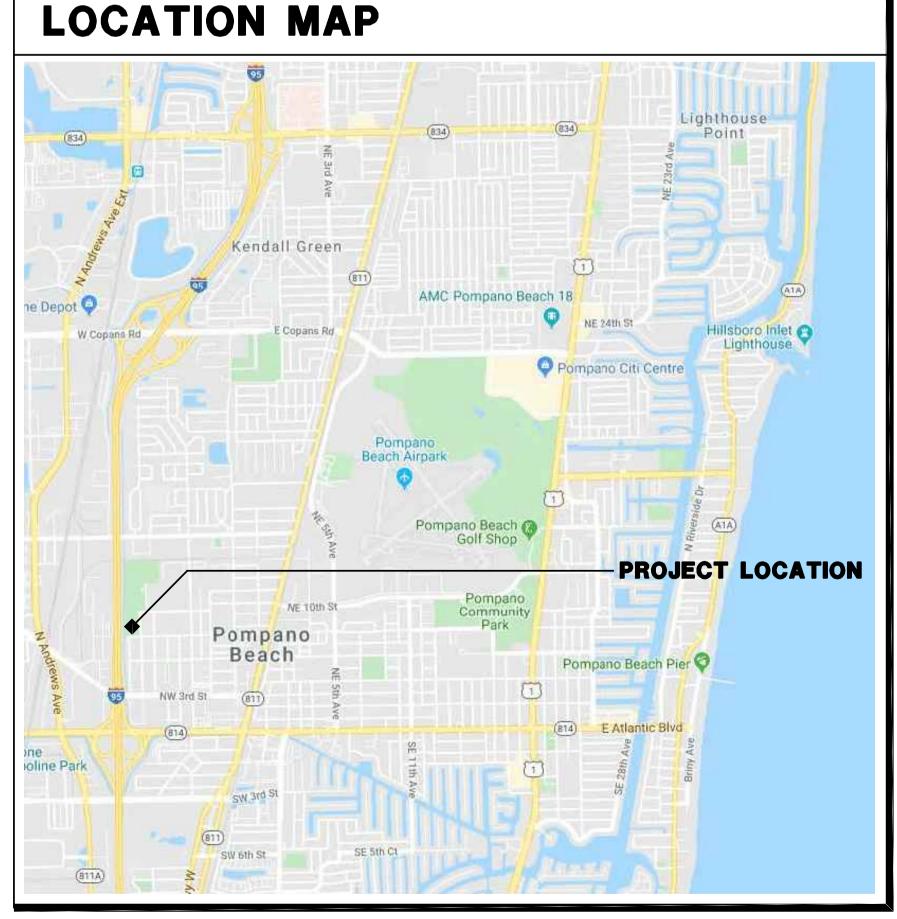
Pompano Beach Fire Plan Review BP20-00004184 9/9/2020

MITCHELL MOORE PARK IMPROVEMENTS

901 NW 10th STREET POMPANO BEACH, FL 33060


POMPANO BEACH PROJECT NO. 19367
WZA PROJECT NO. 1907






POMPANO BEACH CITY COMMISSION Mayor REX HARDIN Vice Mayor BARRY MOSS Commissioner ANDREA McGEE Commissioner RHONDA EATON Commissioner TOM McMAHON District 2 Commissioner TOM McMAHON District 3 Commissioner BEVERLY PERKINS District 4 GREG HARRISON City Manager

ALTERS-ZACKRIA ASSOCIATES
RT LAUDERDALE, FLORIDA 33309 (954) 522-4123 Fax. (954) 522-4128
BI GROUP DO PARK CENTRAL BLVD S, SUITE 3500 MPANO BEACH, FLORIDA 33064 . (954) 974-2200
ELTA G CONSULTING ENGINEERS INC. 7 NE 3 AVENUE #200 RT LAUDERDALE, FL 33304 . (954) 527-1112 Fax. (954) 524-7505
/

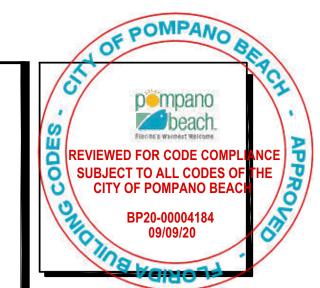

Abba Digitally signed by Abbas H Zackria DN: c=US, o=WALTERS ZACKRIA ASSOCIATES PLLC, ou=A01427E00000 167A29D31730000 583A, cn=Abbas H Zackria Date: 2020.06.05 12:38:43 -04'00'

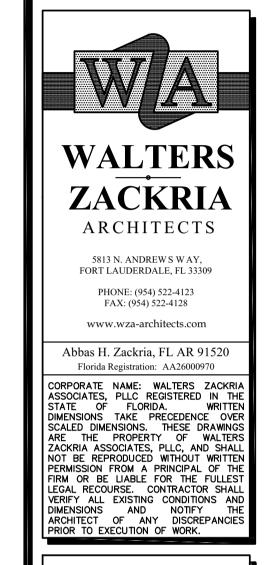

ITCHELL MOORE PARK
IMPROVEMENTS
861 NW 9TH AVENUE

DRAWN BY: JA
CHECKED BY: GD
DATE: 06/05/2020
REVISIONS:

1907

A0.00

COVER SHEET

PROJECT INFORMATION

PARCEL IDENTIFICATION NO. 4842 34 12 0090

SITE ADDRESS: 861 NW 9 AVENUE, POMPANO BEACH FL 33060

PROPERTY OWNER: CITY OF POMPANO BEACH

LEGAL DESCRIPTION: REFER TO SURVEY

YEAR BUILT: 199

ENTIRE PARK SITE AREA: 703,704 SQUARE FEET OR 16.2 ACRES

AREA OF PROPOSED IMPROVEMENTS: 150,000 SQUARE FEET

LAND USE: OR / RECREATIONAL OPEN SPACE

ZONING: CF / COMMUNITY FACILITIES

FLOOD ZONE: FEMA FLOOD ZONE X

CODE INFORMATION

CLASSIFICATION OF WORK: ALTERATION - LEVEL 1 COMPLYING W/ CHAPTER 7 FBC - EXISTING BUILDINGS 2017 (SIXTH

EDITION)

BUILDING CODE:

TO THE BEST OF OUR KNOWLEDGE, ALL EXISTING CONDITIONS COMPLY WITH CODES IN EFFECT AT THE TIME OF CONSTRUCTION. THE PROPOSED SCOPE OF NEW WORK IS LIMITED

TO EXTERIOR IMPROVEMENTS OF THE EXISTING FIELDS AND ALL WORK SHALL COMPLY WITH FLORIDA BUILDING CODE 2017 (SIXTH EDITION) AND THE FLORIDA FIRE PREVENTION CODE

2015 (SIXTH EDITION), INCLUDING NFPA 101 LIFE SAFETY CODE.

TYPE OF CONSTRUCTION: NOT APPLICABLE FOR THIS PROJECT

OCCUPANCY CLASSIFICATION: ASSEMBLY GROUP A-5

GENERAL NOTES

- 1. GENERAL CONTRACTOR SHALL BE FAMILIAR WITH THE SITE & VERIFY ALL EXISTING UTILITY SERVICE LOCATIONS IN ALL AREAS INCLUDED IN THE SCOPE OF WORK PRIOR TO COMMENCING CONSTRUCTION
- 2. ANY EXISTING ITEMS THAT ARE DISTURBED, DAMAGED OR REMOVED DURING CONSTRUCTION SHALL BE REPLACED WITH NEW OR REPAIRED TO THE OWNERS SATISFACTION AND LIKE NEW CONDITION.
- 3. DO NOT DISTURB ANY STRUCTURAL COMPONENTS OF EXISTING BUILDINGS, UNLESS OTHERWISE DIRECTED IN THE DOCUMENTS WITHOUT PRIOR WRITTEN APPROVAL BY ARCHITECT.
- 4. PROTECT ALL EXISTING UTILITIES FROM DAMAGE DURING ALL PHASES OF CONSTRUCTION. ANY UTILITIES ACCIDENTALLY DAMAGED
- DURING CONSTRUCTION SHALL BE REPLACED AT CONTRACTOR'S EXPENSE

 5. EACH CONTRACTOR SHALL USE ALL POSSIBLE CARE TO PROTECT ALL EXISTING MATERIALS, SURFACES, AND FURNISHINGS FROM
- DAMAGE DURING ALL PHASES OF CONSTRUCTION.
- 6. ALL UNANTICIPATED AND UNFORESEEN DEMOLITION AND OR NEW CONSTRUCTION CONDITIONS WHICH REQUIRE DEVIATION FROM THE PLANS AND NOTES HEREIN SHALL BE REPORTED TO THE ARCHITECT, IN WRITING, AND APPROVAL SOUGHT PRIOR TO COMMENCING SAID WORK PER CONTRACT.
- 7. ARCHITECT SHALL NOT BE LIABLE FOR PROBLEMS RELATING TO EXISTING CONDITIONS. NOTIFY ARCHITECT, IN WRITING, IMMEDIATELY IF PROBLEMS ARISE.
- 8. ALL NEW MATERIAL AND/OR PATCHWORK SHALL BE PROVIDED TO MATCH EXISTING MATERIALS AND/OR ADJOINING WORK WHERE PRACTICAL, EXCEPT AS SPECIFICALLY NOTED HEREIN.
- 9. UNLESS NOTED OTHERWISE, THE CONTRACTOR SHALL FURNISH WRITTEN GUARANTEES FOR ALL TRADES FOR A MINIMUM OF ONE YEAR FROM DATE OF SUBSTANTIAL COMPLETION. DEFECTIVE MATERIALS OR WORKMANSHIP SHALL BE REPLACED AT THE CONTRACTOR'S EXPENSE.
- 10. GENERAL CONTRACTOR IS TO THOROUGHLY REVIEW ALL DRAWINGS AND PROVIDE OVERVIEW TO ALL TRADES. ALL SUBCONTRACTORS ARE TO REVIEW ALL DRAWING SHEETS GENERAL CONTRACTOR TO PROVIDE COMPLETE SETS OF PLANS TO ALL SUBCONTRACTORS FOR REVIEW. ITEMS SHOWN ON ARCHITECTURAL DRAWINGS ARE REQUIRED TO BE COMPLETELY INSTALLED REGARDLESS IF THEY ARE NOT SPECIFICALLY DESIGNATED ON ELECTRICAL, MECHANICAL, PLUMBING, CIVIL OR STRUCTURAL ENGINEERING DRAWINGS. GENERAL CONTRACTOR IS RESPONSIBLE FOR COORDINATING ALL REQUIRED ITEMS WITH ALL SUBCONTRACTORS AND THROUGHOUT ALL PHASES OF CONSTRUCTION.
- 11. ALL WORK SHALL BE DONE IN ACCORDANCE W/ ALL APPLICABLE NATIONAL, STATE, COUNTY & LOCAL CODES AND ORDINANCES. WORK SHALL BE DONE IN A WORKMANLIKE MANNER AS PER STANDARD BUILDING TECHNIQUES AND PRACTICES.
- 12. GENERAL CONTRACTOR IS RESPONSIBLE TO FILE AND OBTAIN THE BUILDING DEPARTMENT PERMIT. OWNER SHALL REIMBURSE THE PERMIT FEES.
- 13. GENERAL CONTRACTOR IS RESPONSIBLE FOR ALL SAFETY CONDITIONS PER OSHA AND ALL STATE AND LOCAL REGULATIONS RELATING TO JOB CONSTRUCTION.
- 14. GENERAL CONTRACTOR TO BE RESPONSIBLE FOR ALL HOISTING RELATED TO WORK IN THIS CONTRACT.
- 15. GENERAL CONTRACTOR IS TO VISIT THE SITE AND CAREFULLY INSPECT THE EXISTING CONDITIONS AFFECTING THE WORK. ANY DISCREPANCIES BETWEEN THE DRAWINGS AND EXISTING CONDITIONS MUST BE REPORTED TO ARCHITECT IN WRITING.
- 16. GENERAL CONTRACTOR IS TO MAINTAIN A CLEAN JOBSITE AND SHALL CONTAIN DIRT, DEBRIS AND DUST WITHIN THE IMMEDIATE AREA OF WORK.
- 17. GENERAL CONTRACTOR SHALL PROTECT THE WORK AREA AGAINST ENTRY BY UNAUTHORIZED PERSONNEL AND THE PUBLIC, IN GENERAL. PROVIDE TEMPORARY ENCLOSURE TO SECURE THE AREA AFTER WORK HOURS.

SCOPE OF WORK

THE SCOPE OF WORK FOR THE PROJECT INCLUDES THE FOLLOWING IMPROVEMENTS TO THE SPORTS FIELDS AT THE SOUTH END OF THE EXISTING PARK:

- PROVIDE A NEW SYNTHETIC TURF AND INFILL SYSTEM AT SAME AREA AS THE NATURAL GRASS PLAYING FIELDS; PREPARE SUB-GRADE AS NECESSARY AND PROVIDE NEW COMPACTED STONE BASE. THIS AREA IS WITHIN THE EXISTING CHAIN LINK BACKSTOPS AND FENCE ENCLOSURE AND CONSISTS OF ONE MULTIPURPOSE FOOTBALL / SOCCER FIELD AND TWO BASEBALL FIELDS WHERE THE OUTFIELD OVERLAPS THE MULTIPURPOSE FIELD. PROVIDE AN 8'-0" WIDE WARNING TRACK BETWEEN THE SYNTHETIC TURF AND EXISTING CHAIN LINK ENCLOSURE AT THE PERIMETER OF THE FIELDS.
- PROVIDE NEW REMOVABLE GOALS / UPRIGHTS AT BOTH ENDS OF MULTIPURPOSE FIELD; MUST BE REMOVABLE TO ELIMINATE HAZARD IN THE BASEBALL OUTFIELDS.
- PROVIDE NEW LED SPORTS LIGHTING HEADS ON EXISTING CONCRETE POLES.

REPLACE EXISTING MULTIPURPOSE SCOREBOARD W/ NEW DIGITAL SCOREBOARD WITH NEW GALVANIZED STEEL PIPE SUPPORTS AND CONCRETE FOUNDATIONS. PROVIDE ALL HARDWARE TO ATTACH SCOREBOARD TO SUPPORTS AND ALL WIRING TO ELECTRIFY. NEW SCOREBOARD TO BE AT APPROXIMATELY SAME LOCATION AS EXISTING.

- RESTORE EXISTING ALUMINUM BLEACHES ON THE EXISTING CONCRETE PADS PROVIDED AT THE SOUTH BASEBALL FIELD.
- PROVIDE NEW 6'-0" HIGH POWDER COATED STEEL FENCE WITH GATES AT EDGE OF PARK TO CONTROL ACCESS AND CLOSE PARK AS NECESSARY. FENCE SHALL HAVE REINFORCED MASONRY COLUMNS W/STUCCO FINISH AND SHALL BE SIMILAR IN DESIGN TO THE PERIMETER FENCE AT THE CITY OF POMPANO BEACH COMMUNITY PARK, WHICH IS CONSIDERED "CITY STANDARD".
- VERY LIMITED SECTIONS OF NEW CONCRETE SIDEWALK SHALL BE PROVIDED TO IMPROVE ACCESS AND CIRCULATION AROUND THE SITE.

OTHER MISCELLANEOUS IMPROVEMENTS AS BUDGET PERMITS

- TRANSPORTABLE BLEACHERS; SEE GENERAL NOTE 6 ON SHEET NO. A1.00
- SHADING AT PERMANENT BLEACHERS AT BASEBALL FIELDS; SEE GENERAL NOTE 4 ON SHEET NO. A1.00.
- REMOVABLE FENCE AT EAST END OF FOOTBALL FIELD IF SPECTATORS ARE PERMITTED ON THE TURF FIELD; SEE GENERAL NOTE 7 ON SHEET NO. A1.00
- REMOVABLE FENCE FOR BASEBALL OUTFIELD; REFER TO GENERAL NOTE 5.ON SHEET NO. A1.00 IF THE CITY IS INTERESTED, AND FUNDING IS AVAILABLE.
- OUTDOOR FITNESS EQUIPMENT; THIS SCOPE SHALL BE DEVELOPED WITH THE CITY IF FUNDING IS AVAILABLE.

DRAWING INDEX

GENERAL INFORMATION

A0.00 COVER SHEET

A0.01 DRAWING INDEX AND NOTES

A0.02 CONSTRUCTION SCOPE PLAN

A0.05 CPTED CONCEPTUAL PLAN

SHEET 1 OF 3 SURVEY NOTES, LEGAL DESCRIPTION AND GENERAL INFORMATION

SHEET 2 OF 3 SURVEY SOUTHERN PORTION
SHEET 3 OF 3 SURVEY NORTHERN PORTION

CIVIL ENGINEERING

C1.0 PAVING, GRADING & DRAINAGE PLAN

C1.1 PAVING, GRADING & DRAINAGE TYPICAL SECTIONS AND DETAILS

C1.2 PAVING, GRADING & DRAINAGE DETAILS

C2.0 EROSION CONTROL PLAN

ARCHITECTURAL

A0.10 SITE PLAN - DEMOLITION

A1.00 SITE PLAN - PROPOSED

A1.10 FIELD LAYOUT PLAN

A1.11 TURF DRAINAGE INFORMATION

A2.10 MISCELLANEOUS DETAILS

ELECTRICAL ENGINEERING

E1.00 INDEX, SYMBOL, LEGEND AND NOTES

E2.00 PROPOSED SITE PLAN - ELECTRICAL

E3.00 PROPOSED SITE PLAN - PHOTOMETRICS

E4.00 ELECTRICAL DETAILS

POMPANO PROTORE WAS PROJUCT WAS COMPLIANCE SUBJECT TO ALL CODES OF THE CITY OF POMPANO BEACL BP20-00004184 09/09/20

Abbas H

Digitally signed by Abbas H Zackria DN: c=US, o=WALTERS ZACKRIA ASSOCIATESPLLC, ou=A01427E00000167A29D317300 00583A, cn=Abbas H Zackria Date: 2020.06.05 12:39:19 -04'00'



WALTERS ZACKRIA ARCHITECTS

5813 N. ANDREWS WAY, FORT LAUDERDALE, FL 33309 PHONE: (954) 522-4123

www.wza-architects.com

FAX: (954) 522-4128

Abbas H. Zackria, FL AR 91520
Florida Registration: AA26000970

CORPORATE NAME: WALTERS ZACKRIA ASSOCIATES, PLLC REGISTERED IN THE STATE OF FLORIDA. WRITTEN DIMENSIONS TAKE PRECEDENCE OVER SCALED DIMENSIONS. THESE DRAWINGS ARE THE PROPERTY OF WALTERS ZACKRIA ASSOCIATES, PLLC, AND SHALL NOT BE REPRODUCED WITHOUT WRITTEN PERMISSION FROM A PRINCIPAL OF THE FIRM OR BE LIABLE FOR THE FULLEST LEGAL RECOURSE. CONTRACTOR SHALL VERIFY ALL EXISTING CONDITIONS AND DIMENSIONS AND NOTIFY THE ARCHITECT OF ANY DISCREPANCIES PRIOR TO EXECUTION OF WORK.


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OF POMPANO BICHELL MOORE PAMPROVEMENT

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DATE: 06/05/2020
REVISIONS:

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DRAWING INDEX AND NOTES



CITY OF POMPANO BEA

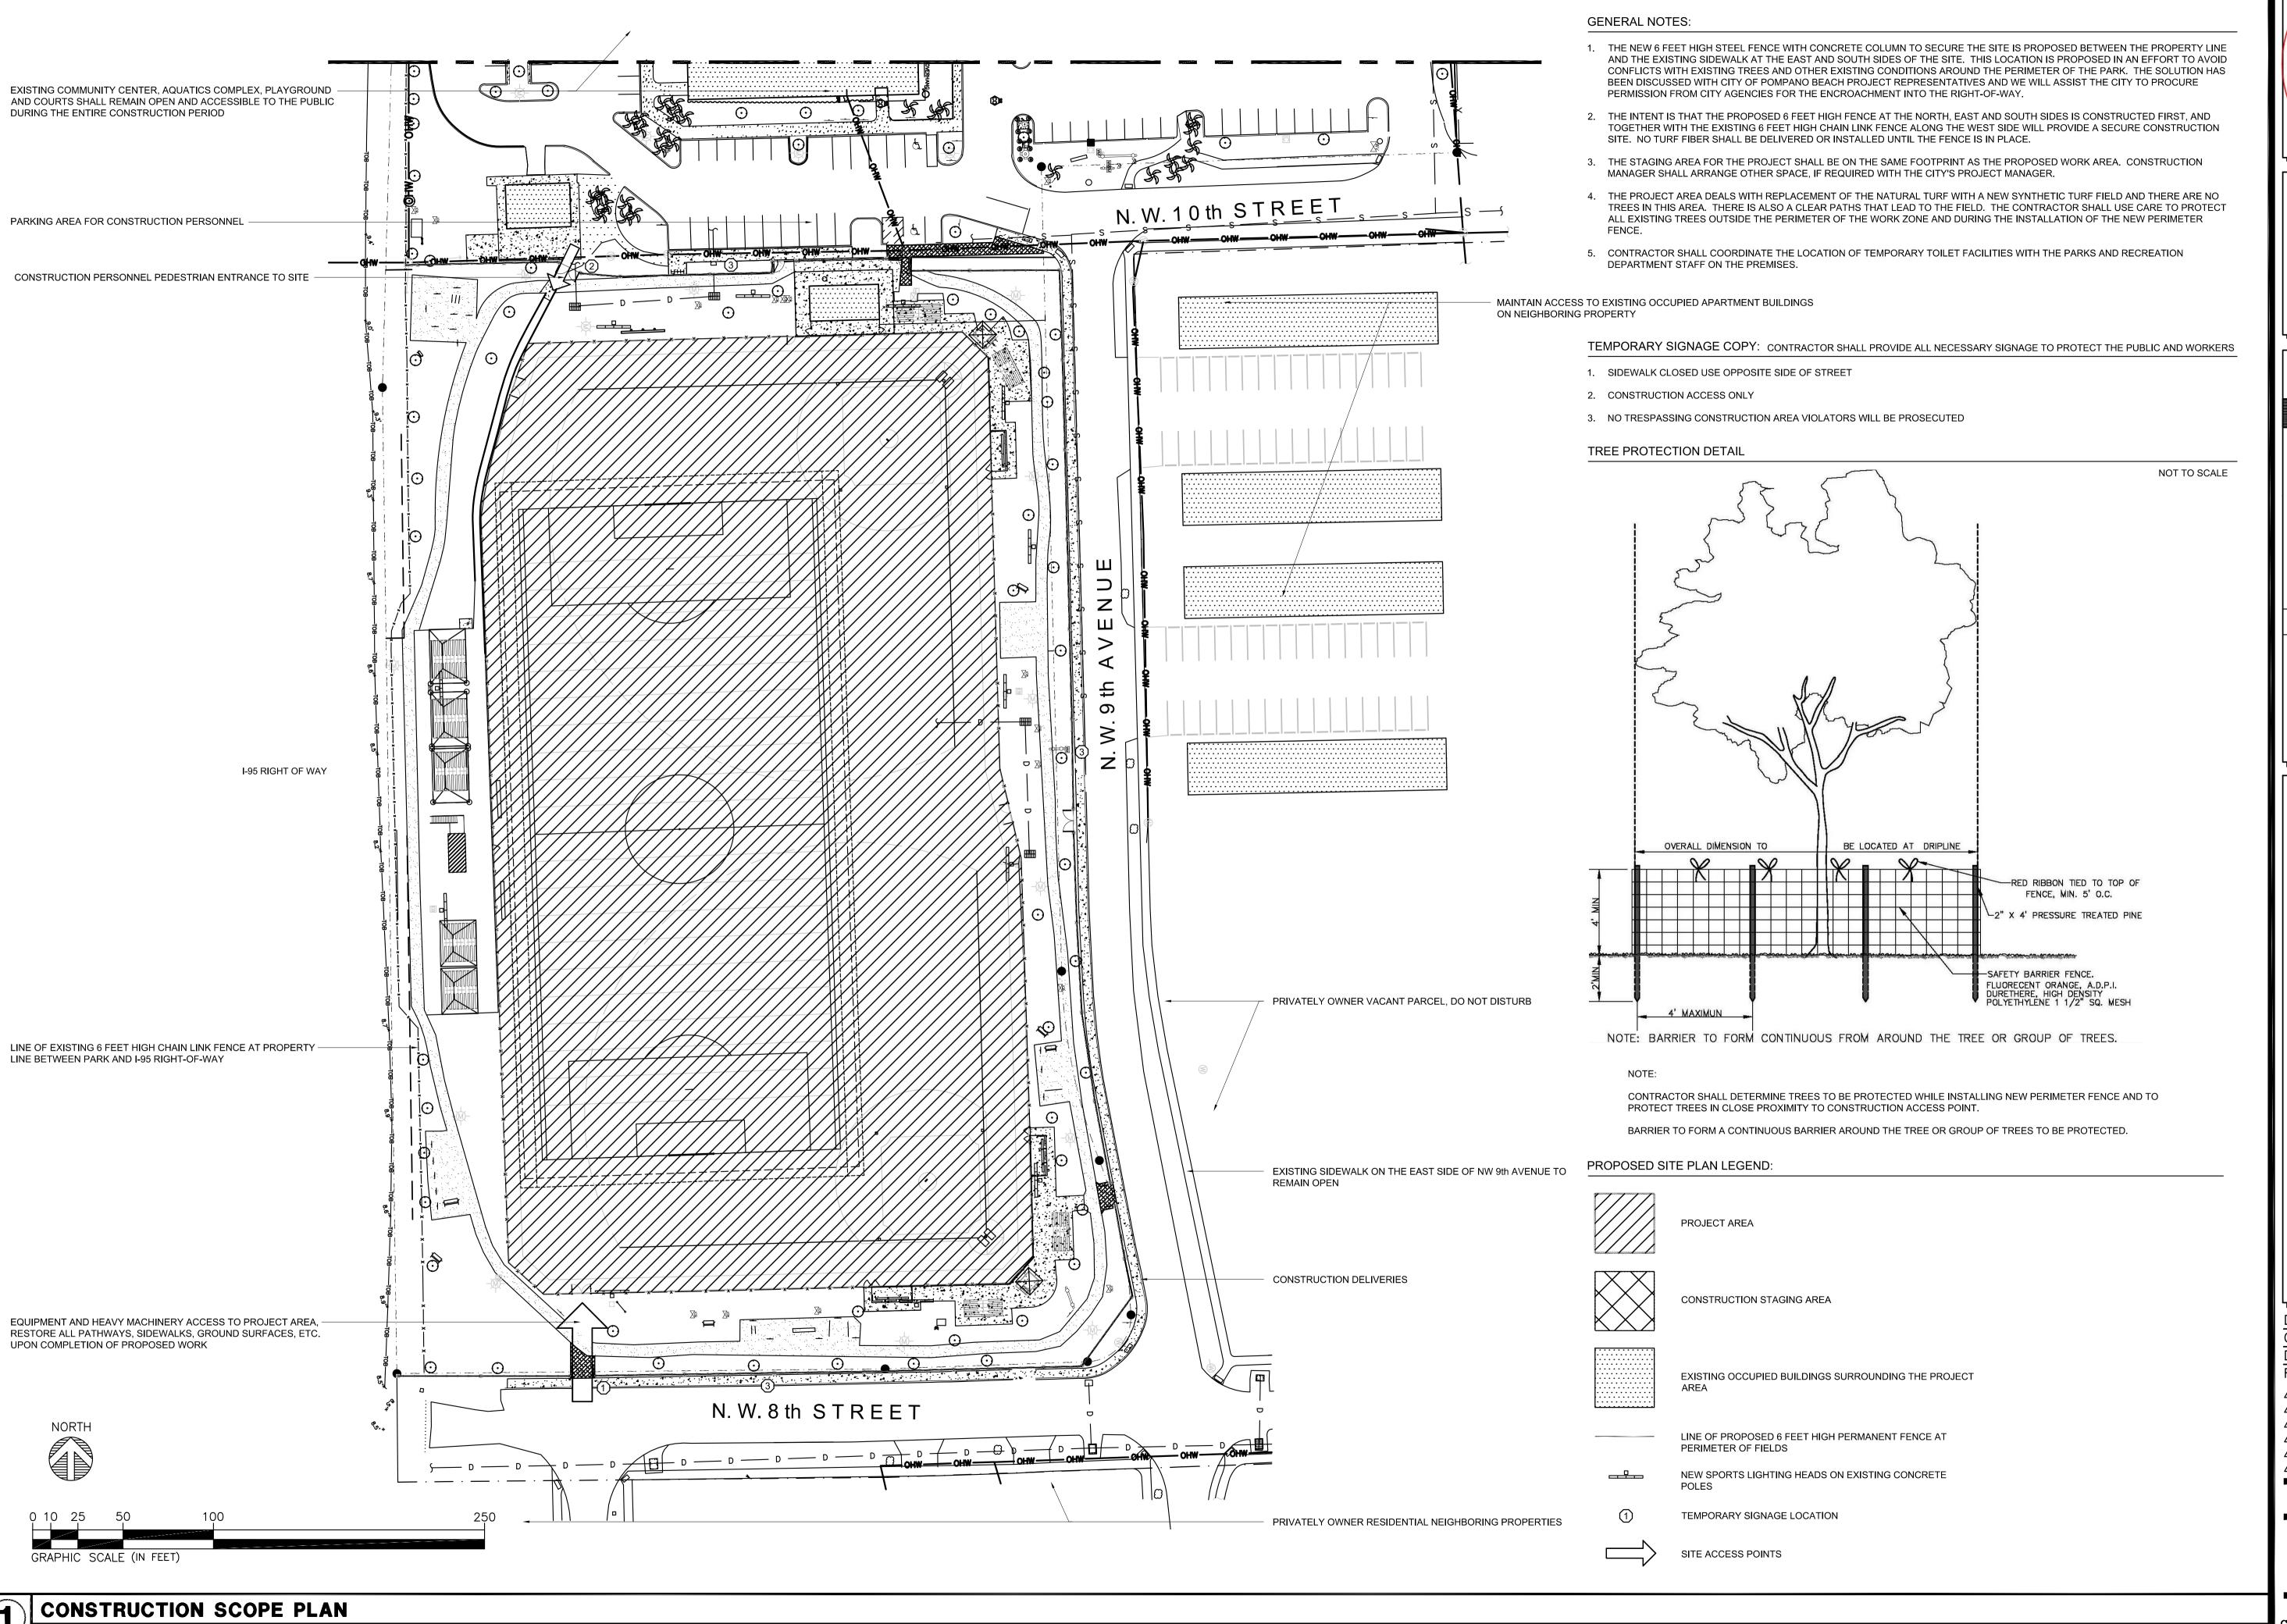Zackria

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WALTERS ARCHITECTS

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www.wza-architects.com

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OF

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REVISIONS:

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SUBJECT TO ALL CODES CITY OF POMPANO BEA

Abbas H

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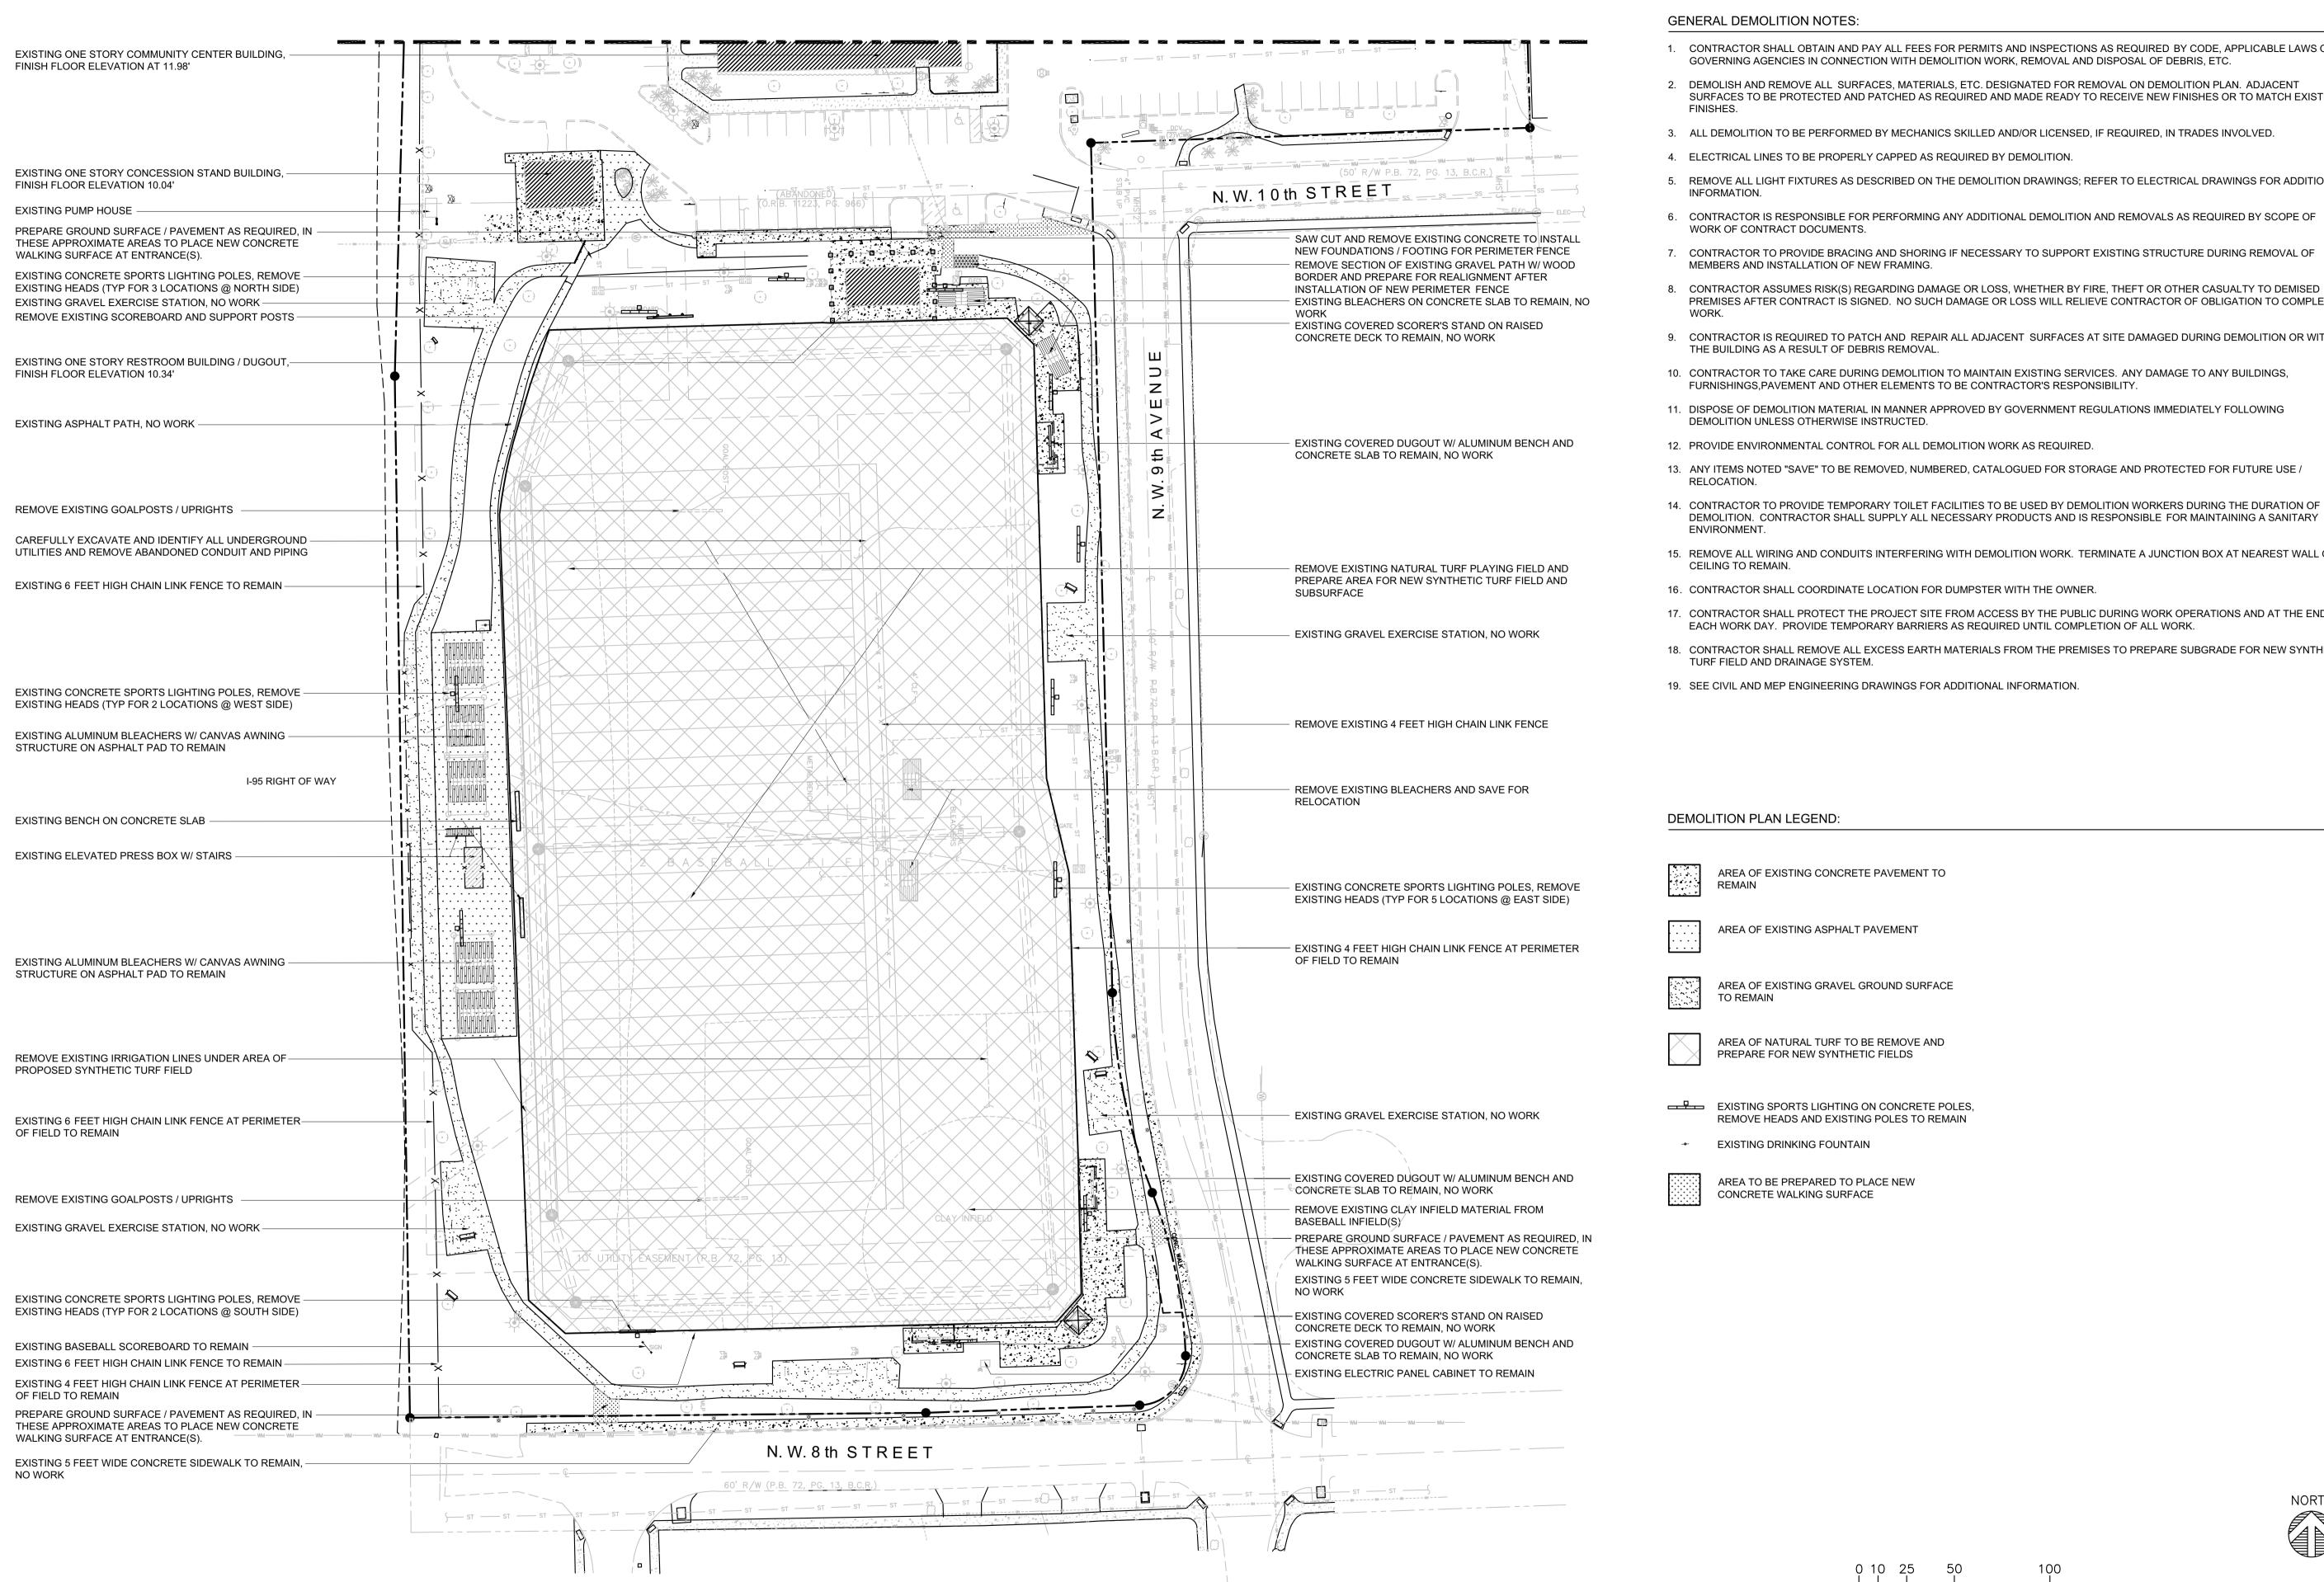
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DRAWN BY: CHECKED BY: DATE: 06/05/2020 **REVISIONS:**

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DEMOLITION SITE PLAN

SCALE: 1" = 40'-0"

CONTRACTOR SHALL OBTAIN AND PAY ALL FEES FOR PERMITS AND INSPECTIONS AS REQUIRED BY CODE, APPLICABLE LAWS OR

2. DEMOLISH AND REMOVE ALL SURFACES, MATERIALS, ETC. DESIGNATED FOR REMOVAL ON DEMOLITION PLAN. ADJACENT SURFACES TO BE PROTECTED AND PATCHED AS REQUIRED AND MADE READY TO RECEIVE NEW FINISHES OR TO MATCH EXISTING

5. REMOVE ALL LIGHT FIXTURES AS DESCRIBED ON THE DEMOLITION DRAWINGS; REFER TO ELECTRICAL DRAWINGS FOR ADDITIONAL

6. CONTRACTOR IS RESPONSIBLE FOR PERFORMING ANY ADDITIONAL DEMOLITION AND REMOVALS AS REQUIRED BY SCOPE OF

7. CONTRACTOR TO PROVIDE BRACING AND SHORING IF NECESSARY TO SUPPORT EXISTING STRUCTURE DURING REMOVAL OF

8. CONTRACTOR ASSUMES RISK(S) REGARDING DAMAGE OR LOSS, WHETHER BY FIRE, THEFT OR OTHER CASUALTY TO DEMISED PREMISES AFTER CONTRACT IS SIGNED. NO SUCH DAMAGE OR LOSS WILL RELIEVE CONTRACTOR OF OBLIGATION TO COMPLETE

9. CONTRACTOR IS REQUIRED TO PATCH AND REPAIR ALL ADJACENT SURFACES AT SITE DAMAGED DURING DEMOLITION OR WITHIN

10. CONTRACTOR TO TAKE CARE DURING DEMOLITION TO MAINTAIN EXISTING SERVICES. ANY DAMAGE TO ANY BUILDINGS.

11. DISPOSE OF DEMOLITION MATERIAL IN MANNER APPROVED BY GOVERNMENT REGULATIONS IMMEDIATELY FOLLOWING

13. ANY ITEMS NOTED "SAVE" TO BE REMOVED, NUMBERED, CATALOGUED FOR STORAGE AND PROTECTED FOR FUTURE USE /

15. REMOVE ALL WIRING AND CONDUITS INTERFERING WITH DEMOLITION WORK. TERMINATE A JUNCTION BOX AT NEAREST WALL OR

17. CONTRACTOR SHALL PROTECT THE PROJECT SITE FROM ACCESS BY THE PUBLIC DURING WORK OPERATIONS AND AT THE END OF

18. CONTRACTOR SHALL REMOVE ALL EXCESS EARTH MATERIALS FROM THE PREMISES TO PREPARE SUBGRADE FOR NEW SYNTHETIC

GRAPHIC SCALE (IN FEET)

mpano SUBJECT TO ALL CODES CITY OF POMPANO BEA

Abbas H

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ARCHITECTS

FORT LAUDERDALE, FL 33309 PHONE: (954) 522-4123 FAX: (954) 522-4128


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OF

DRAWN BY: CHECKED BY: DATE: 06/05/2020 **REVISIONS:**

NORTH



GENERAL NOTES:

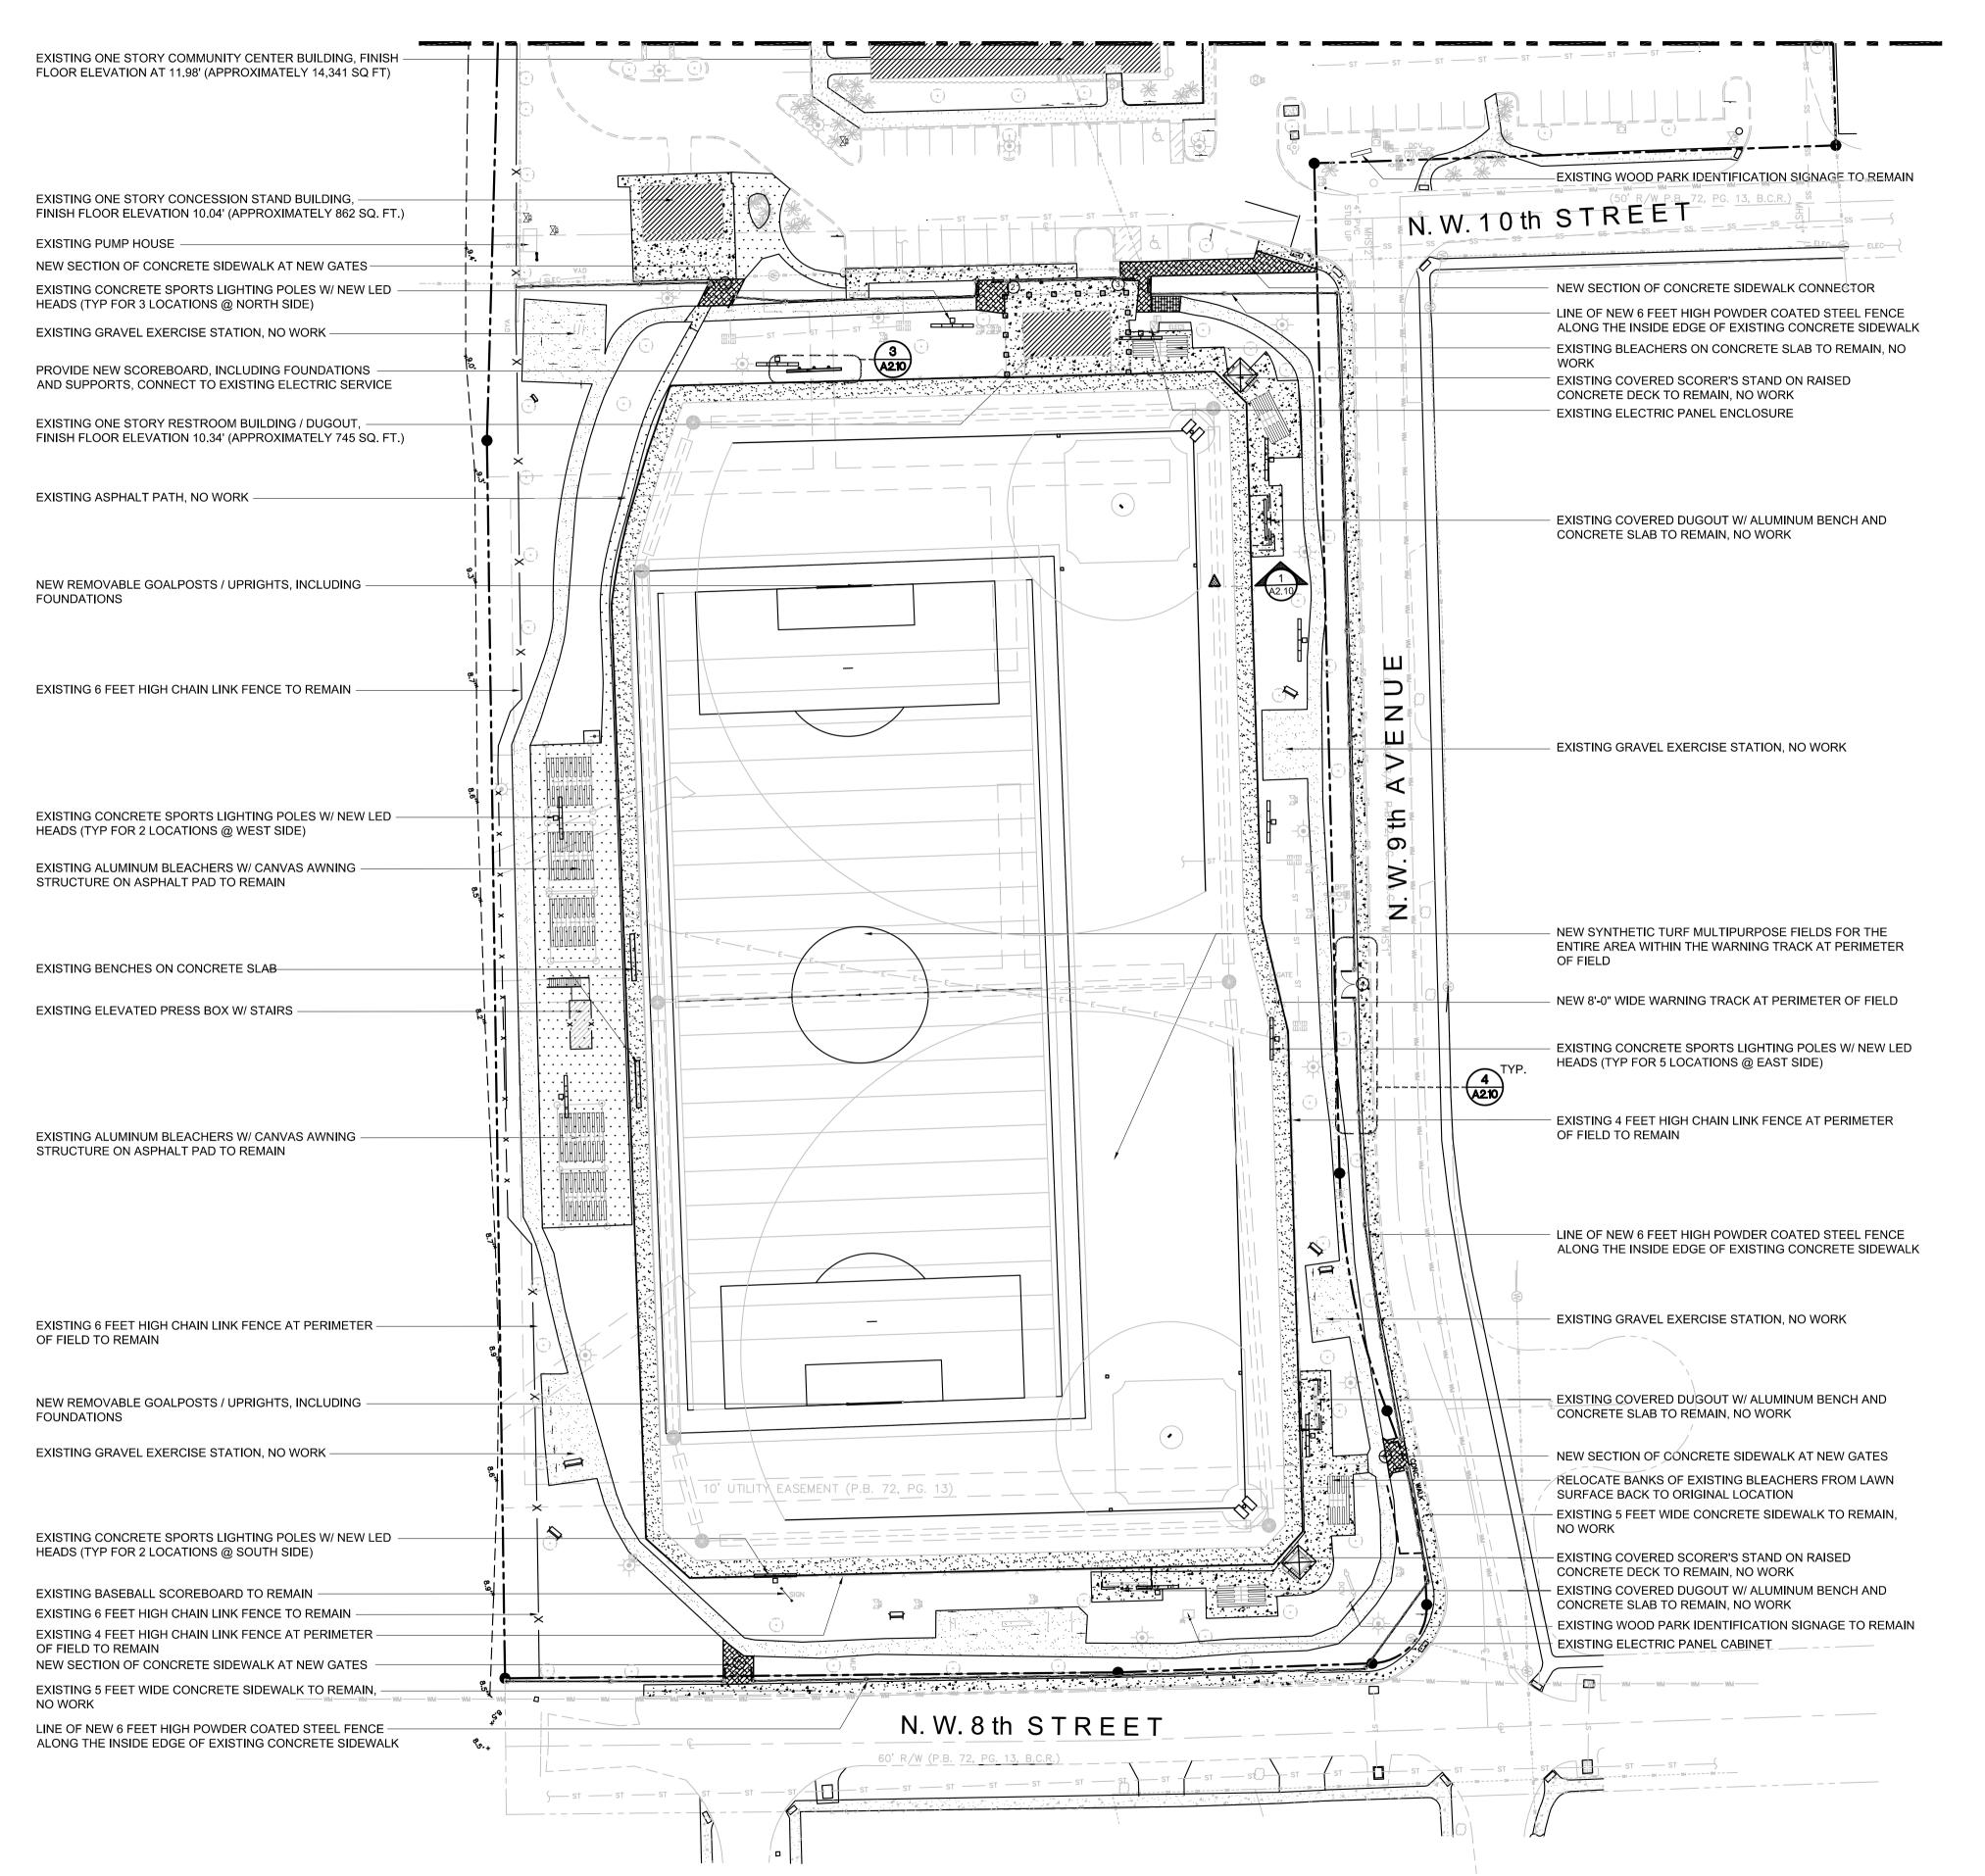- 1. THE MAJORITY OF THE WORK SHALL BE PERFORMED WITHIN THE EXISTING 48" HIGH CHAIN LINK FENCE AT THE PERIMETER OF THE PLAYING FIELDS. PROTECT ALL OTHER ADJACENT AREAS AND RESTORE ANY DAMAGED PORTIONS UPON COMPLETION OF WORK.
- PARK FEATURES SURROUNDING THE THE NEW TURF FIELD AND WITHIN THE BOUNDARY OF THE NEW 6'-0" HIGH POWDER COATED STEEL FENCE, INSIDE THE SIDEWALK SHALL REMAIN CLOSED AND NOT ACCESSIBLE TO THE PUBLIC DURING THE CONSTRUCTION PERIOD.
- THE SOCCER GOAL / FOOTBALL GOALPOSTS ARE WITHIN THE PLAYING SURFACE OF THE BASEBALL OUTFIELDS; THESE SHALL BE REMOVABLE AND THE TOP OF THE SLEEVES EMBEDDED BELOW THE TURF SURFACE SHALL BE CAPPED AND COVERED WITH TURF MATERIAL.
- 4. IDEALLY, THE EXISTING ALUMINUM BLEACHERS AT BOTH SIDES OF EACH BASEBALL FIELD SHALL BE COVERED WITH AN AWNING STRUCTURE SIMILAR TO THE EXISTING STRUCTURES THAT SHADE THE BLEACHER ALONG THE WEST SIDE FOOTBALL FIELD. PROVIDE AN ADD ALTERNATE TO PROVIDE NEW AWNING STRUCTURES, SIMILAR TO THE EXISTING, FOR THE 4 BANKS OF BLEACHERS AT THE BASEBALL FIELDS.
- 5. THE EDGE OF THE BASEBALL OUTFIELD LINE OR "HOME RUN" LINE WILL BE MARKED ON THE TURF SURFACE BUT NO FENCE WILL BE PROVIDED IN THE BASE BID. PROVIDE AN ALTERNATE FOR EITHER OF THE FOLLOWING TO ACCOMMODATE A FUTURE FENCE FOR
- A. PROVIDE 7 FEET HIGH REMOVABLE OUTFIELD FENCING SYSTEM SIMILAR TO SPECTO SYSTEMS BY GRAND SLAM SAFETY, LLC. ALONG THE LINE. THIS INCLUDES REMOVABLE, SLEEVED FOUL POLES AND A NETWORK OF POSTS W/ CABLE SUSPENDED MESH FENCING BETWEEN THE 2 FOUL POLES. THESE ARE ALL INSTALLED INTO SLEEVES, EMBEDDED INTO CONCRETE BELOW THE TURF SURFACE AND COVERED WITH A TURF COVERED CAP WHEN NOT IN USE.
- B. INSTALL ONLY THE PERMANENT SLEEVES THAT ARE SET INTO THE GROUND AND UNDER THE NEW TURF W/ NEW CAPS IN THE FIRST STEP, TO AVOID TEARING UP THE FIELD IN FUTURE, THE REMOVABLE FENCING SYSTEM AND FOUL POLES CAN BE PURCHASED AT A FUTURE DATE AND INSTALLED INTO THE SLEEVES PROVIDED.
- 6. THE TWO EXISTING 5 ROW BANKS OF ALUMINUM BLEACHERS THAT CURRENTLY SIT ALONG THE EAST EDGE OF THE FOOTBALL FIELD ARE BEING PROPOSED TO THEIR ORIGINAL LOCATION OUTSIDE THE BASEBALL FIELD AT THE SOUTHEAST CORNER. PROVIDE AN ALTERNATE TO ADD (2) FIVE ROW 21 FEET LONG TRANSPORTABLE BLEACHER UNITS, SIMILAR TO THOSE SUPPLIED BY THE PARK CATALOG.
- 7. PROVIDE ADD ALTERNATE TO INCLUDE 300 LINEAR FEET OF 48" HIGH BASELINE FENCING ALONG THE EAST SIDE OF THE FOOTBALL FIELD, BETWEEN THE ATHLETES AND SPECTATORS ON THE MOVEABLE BLEACHERS. USE THE BASELINE FENCING SYSTEM SIMILAR TO THAT PROVIDED BY GRAND SLAM SAFETY, LLC.

SITE AREA BREAKDOWN:

	EXISTING CONDITION	POST IMPROVEMENTS
TOTAL SITE AREA	16.15ACRE / 703,703 SQ. FT. (100%)	16.15ACRE / 703,703 SQ. FT. (100%)
BUILDING AREA:	0.49 ACRE / 21,320 SQ. FT. (3%)	0.49 ACRE / 21,320 SQ. FT. (3%)
IMPERVIOUS AREA:	4.70 ACRE / 204,732 SQ. FT. (29%)	7.84 ACRES / 341,630 SQ. FT. (48.6%)
PERVIOUS AREA:	10.96 ACRE / 477,651 SQ. FT. (68%)	7.82 ACRES / 340,753 SQ. FT. (48.4%)

PROJECT AREA: 3.415 ACRES / 148,757 SQ. FT. (136, 898 SQ. FT. SYNTHETIC TURF AREA / 11,859 SQ. FT. WARNING TRACK AREA

PERVIOUS AREA EXCEEDS THE 20% MINIMUM REQUIREMENT FOR COMMUNITY FACILITIES ZONING DISTRICT IN ACCORDANCE WITH THE STANDARDS LISTED IN SECTION155.3503 OF THE CITY OF POMPANO BEACH ZONING CODE.

PROPOSED SITE PLAN LEGEND:

AREA OF EXISTING CONCRETE PAVEMENT TO REMAIN

AREA OF EXISTING ASPHALT PAVEMENT

AREA OF EXISTING GRAVEL GROUND SURFACE
TO REMAIN

AREA OF NATURAL TURF TO BE REMOVE AND PREPARE FOR NEW SYNTHETIC FIELDS

AREA OF WARNING TRACK MIX AT PERIMETER OF NEW SYNTHETIC FIELDS

AREA OF NEW CONCRETE WALKING SURFACE

NEW SPORTS LIGHTING HEADS ON EXISTING CONCRETE


AREA OF NEW GRAVEL WALKING SURFACE

POLES

* EXISTING DRINKING FOUNTAIN

GATE NUMBER

Pompano Beach Fire Plan Review BP20-00004184 9/9/2020

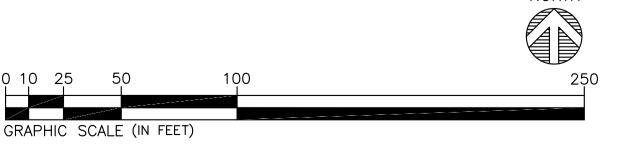

Pierra a Walcases

REVIEWED FOR CODE COMPLIANCE
SUBJECT TO ALL CODES OF THE
CITY OF POMPANO BEACK

BP20-00004184
09/09/20

Abbas H Zackria

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WALTERS ZACKRIA

ARCHITECTS

5813 N. ANDREWS WAY, FORT LAUDERDALE, FL 33309 PHONE: (954) 522-4123 FAX: (954) 522-4128

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Abbas H. Zackria, FL AR 91520
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DIMENSIONS AND NOTIFY THE
ARCHITECT OF ANY DISCREPANCIES
PRIOR TO EXECUTION OF WORK.


OF POMPANO BEACHELL MOORE PARKIPROVEMENTS

DRAWN BY: JA
CHECKED BY: GD
DATE: 06/05/2020
REVISIONS:

A1.00

PROPOSED SITE PLAN

SCALE: 1" = 40'-0"

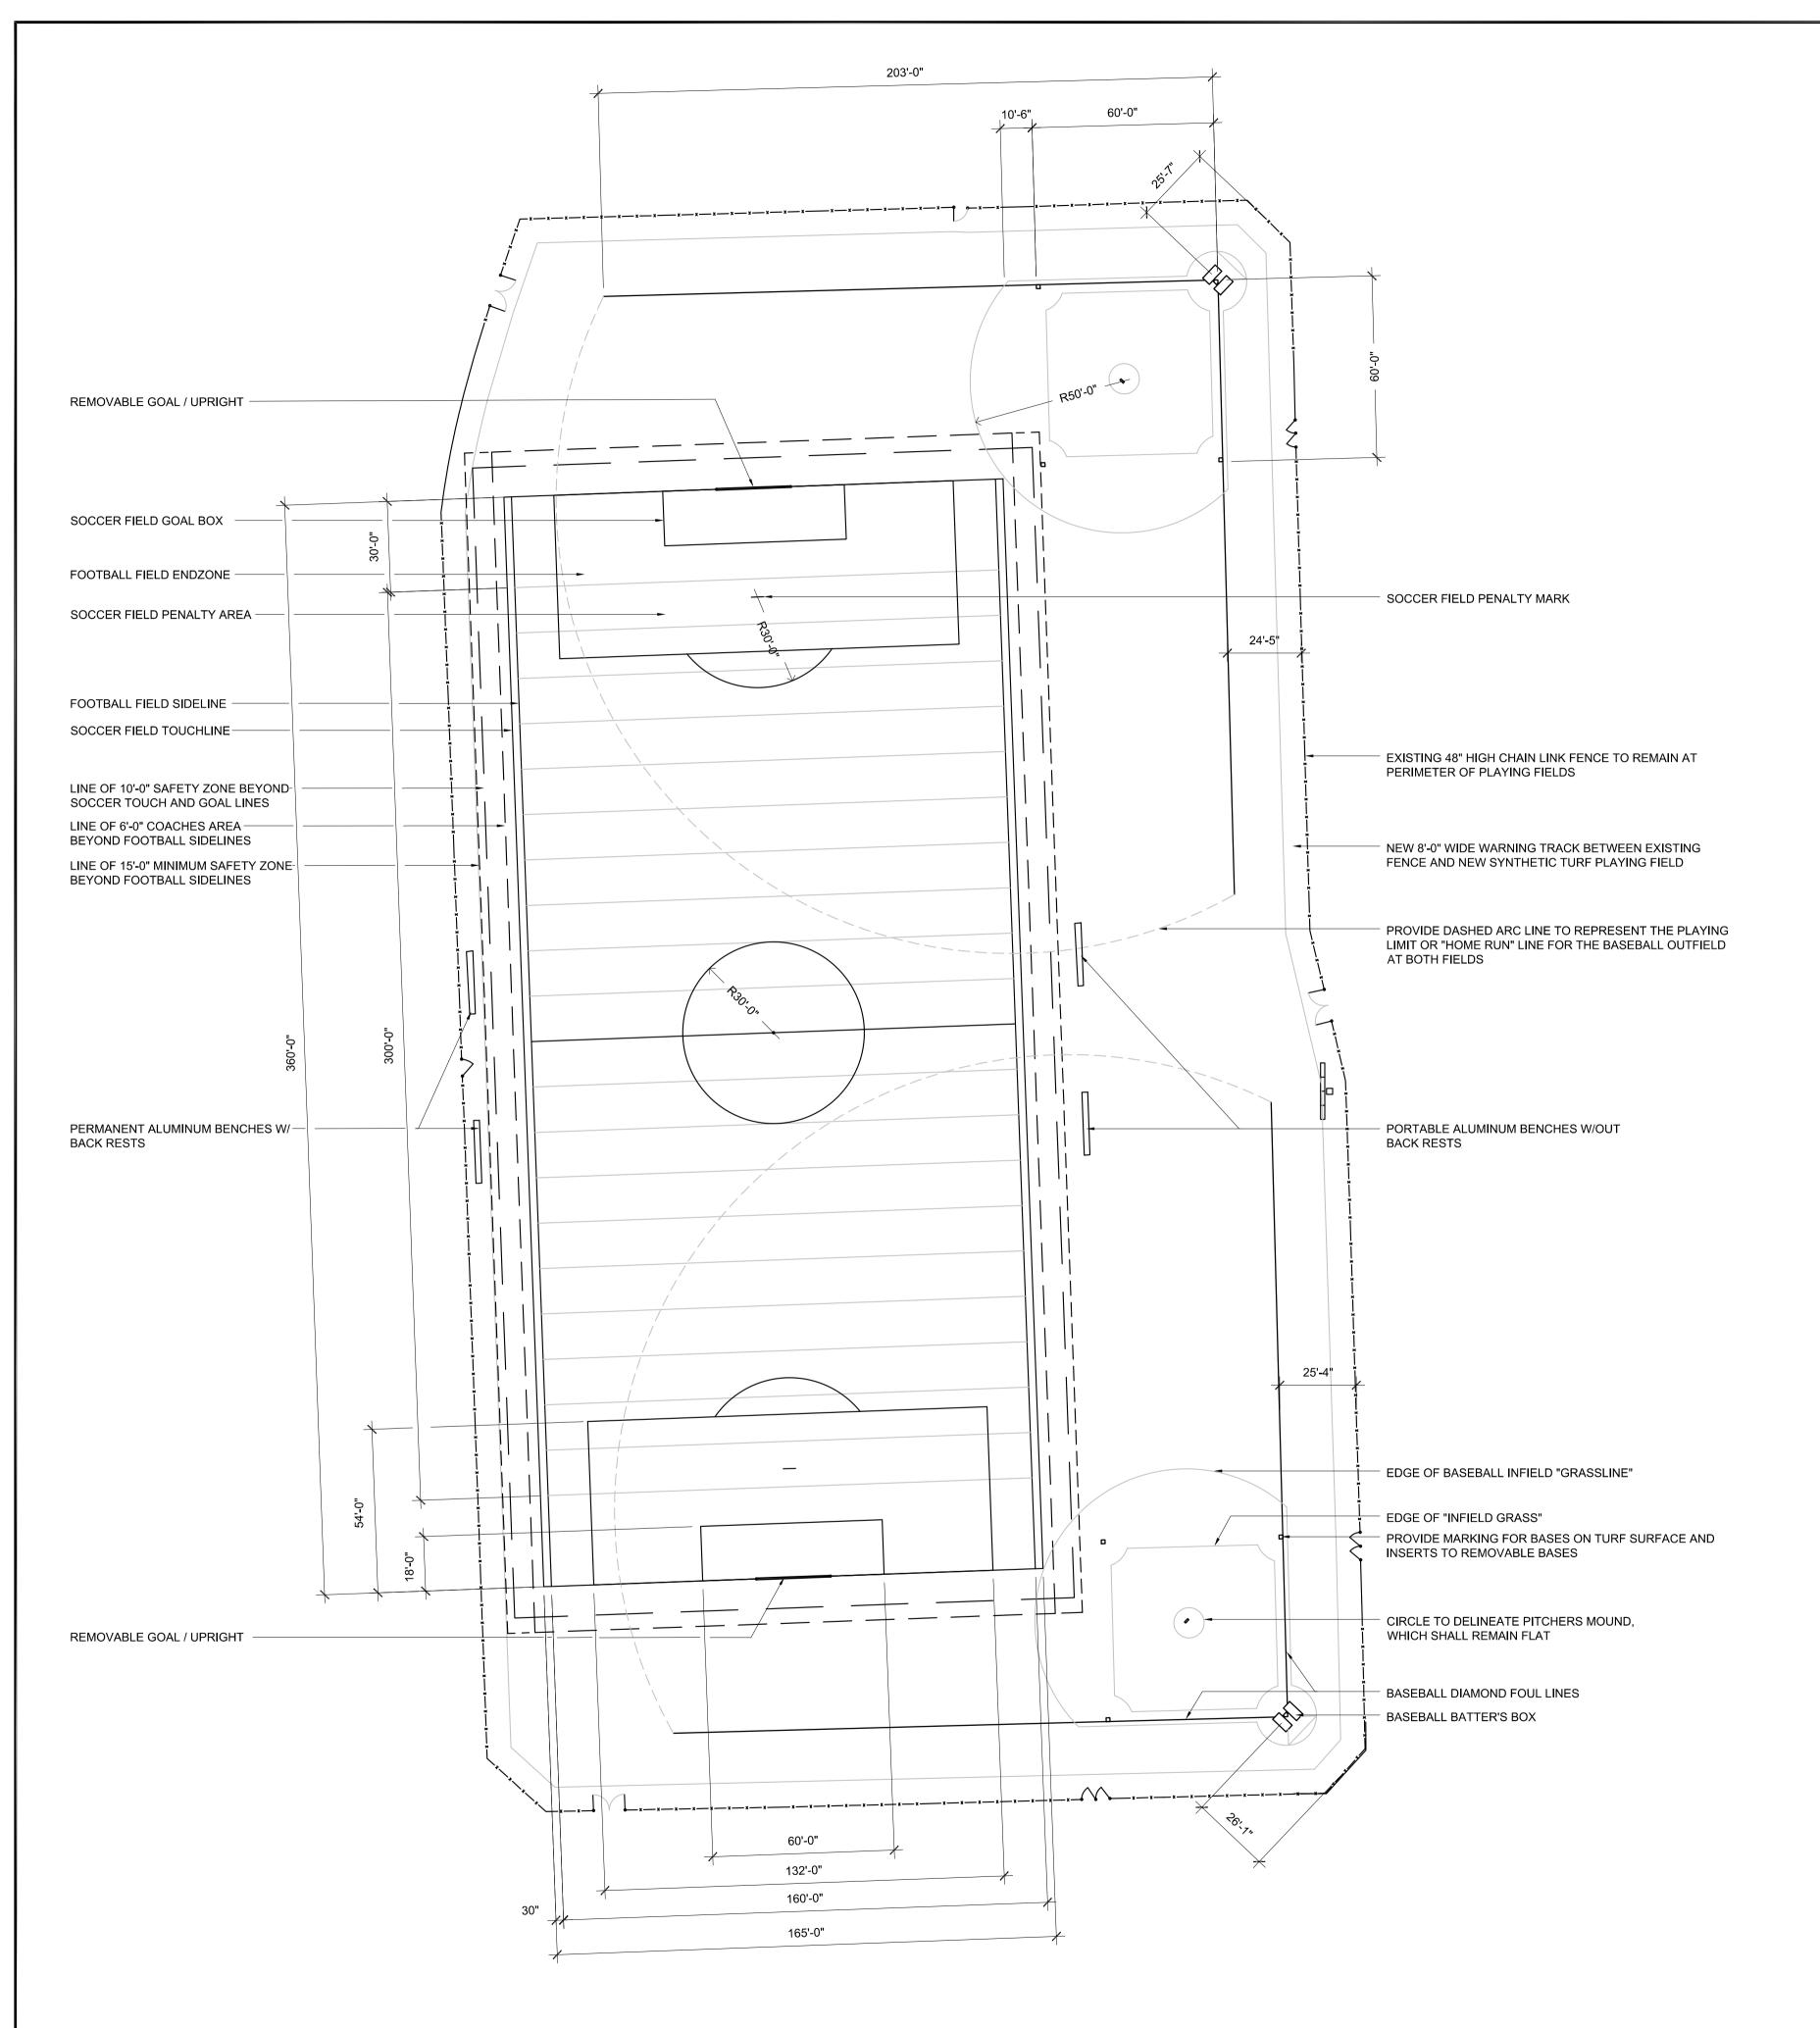

THE BASIS OF DESIGN FOR THE TURF SHALL BE FIELDTURF XT-57 (2.25"), HIGH PERFORMANCE ARTIFICIAL INFILLED GRASS SURFACE, WITH AMBIENT RUBBER OVER SAND INFILL.

THE SAME TURF SYSTEM WILL BE USED AT BOTH THE MULTIPURPOSE FIELD AND THE BASEBALL FIELDS. THE ENTIRE AREA SHALL BE THE SAME COLOR; THERE WILL NOT BE A COLOR CHANGE TO REPRESENT CLAY IN THE BASEBALL INFIELD.

THE COLORS FOR FIELD STRIPING SHALL BE AS FOLLOWS FOR EACH SPORT:


FOOTBALL: SOCCER: YELLOW


CONTRACTOR TO PROVIDE PAINTED BASES ON THE TURF SURFACE AS WELL AS INSERTS AND REMOVABLE BASES FOR EACH OF THE TWO FIELDS. THE HOME PLATES ON EACH DIAMOND SHALL BE

PITCHING PLATE SHALL BE GRAY FIBER INSERT INTO THE TURF SURFACE; PROVIDE ALTERNATE FOR ONE REMOVABLE, ONE PIECE PITCHER'S MOUND, SIMILAR TO 10" TALL X 7'-7" WIDE X 11'-3" LONG MODEL PROVIDED BY BASEBALLTIPS.COM.


PROVIDE SPORTSFIELD SPECIALTIES, INC. MODEL NO. GPKS30HSPL GOALPAK COMBINATION FOOTBALL / SOCCER GOALS WITH BASE PLATE. THESE ARE REMOVABLE GOALS / UPRIGHTS AND CONTRACTOR SHALL PROVIDE ALL COMPONENTS AND ENGINEERED DRAWINGS FOR THE CONCRETE FOUNDATIONS BELOW THE TURF SURFACE. PROVIDE TURF PLUG COVERS TO CONCEAL INSERTS ON THE PLAYING SURFACE.

PROVIDE TWO UNITS OF 21 FEET LONG, SINGLE TIER PERMANENT ALUMINUM PLANK BENCH W/BACK REST, SIMILAR TO SPORTSFIELD SPECIALTIES INC. MODEL NO. ATBBRSP (CUSTOM LENGTH); CONTACTOR TO PROVIDE ENGINEERING AND FOUNDATIONS BELOW TURF SURFACE, AND TWO UNITS OF 15 FEET LONG, SINGLE TIER PORTABLE ALUMINUM PLANK BENCH W/ NO BACK REST, SIMILAR TO SPORTSFIELD SPECIALTIES INC. MODEL NO. ATBNBPT15.

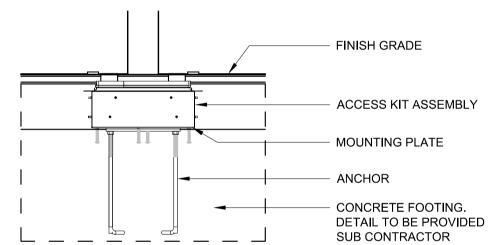

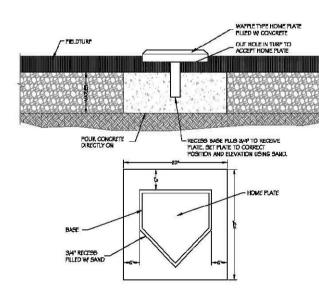

HOME PLATE MOUNT DETAIL SCALE: NTS

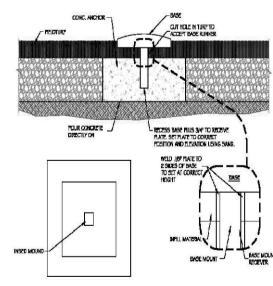

SCALE: NTS






FIELD LAYOUT PLAN SCALE: 1" = 30' - 0"


WHITE

BASEBALL / SOFTBALL: GRAY

PERMANENTLY SET INTO THE TURF SURFACE.

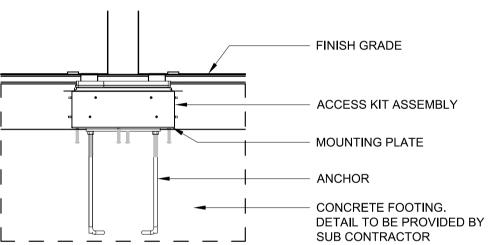

FOOTBALL GOAL POST PLATE MOUNT DETAIL SCALE: NTS

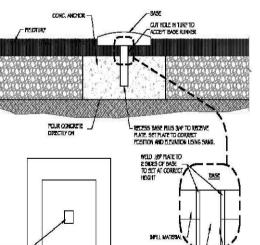

BASE MOUNT DETAIL

DATE: 06/05/2020 REVISIONS:

DRAWN BY:

CHECKED BY:

OF

A1.10

SUBJECT TO ALL CODES O CITY OF POMPANO BEA

Abbas H Zackria

Zackr 10167A29D317300 00583A, cn=Abbas

ARCHITECTS

5813 N. ANDREWS WAY, FORT LAUDERDALE, FL 33309

PHONE: (954) 522-4123

FAX: (954) 522-4128

www.wza-architects.com

Abbas H. Zackria, FL AR 91520 Florida Registration: AA26000970

CORPORATE NAME: WALTERS ZACKRIA ASSOCIATES, PLLC REGISTERED IN THE STATE OF FLORIDA. WRITTEN DIMENSIONS TAKE PRECEDENCE OVER SCALED DIMENSIONS. THESE DRAWINGS ARE THE PROPERTY OF WALTERS ZACKRIA ASSOCIATES, PLLC, AND SHALL NOT BE REPRODUCED WITHOUT WRITTEN PERMISSION FROM A PRINCIPAL OF THE FIRM OR BE LIABLE FOR THE FULLEST LEGAL RECOURSE. CONTRACTOR SHALL VERIFY ALL EXISTING CONDITIONS AND DIMENSIONS AND NOTIFY THE ARCHITECT OF ANY DISCREPANCIES PRIOR TO EXECUTION OF WORK.

DN: c=US,


o=WALTERS ZACKRIA

H Zackria

ASSOCIATESPLL ou=A01427E0000

Date: 2020.06.05 12:44:16 -04'00'

FIELD LAYOUT PLAN

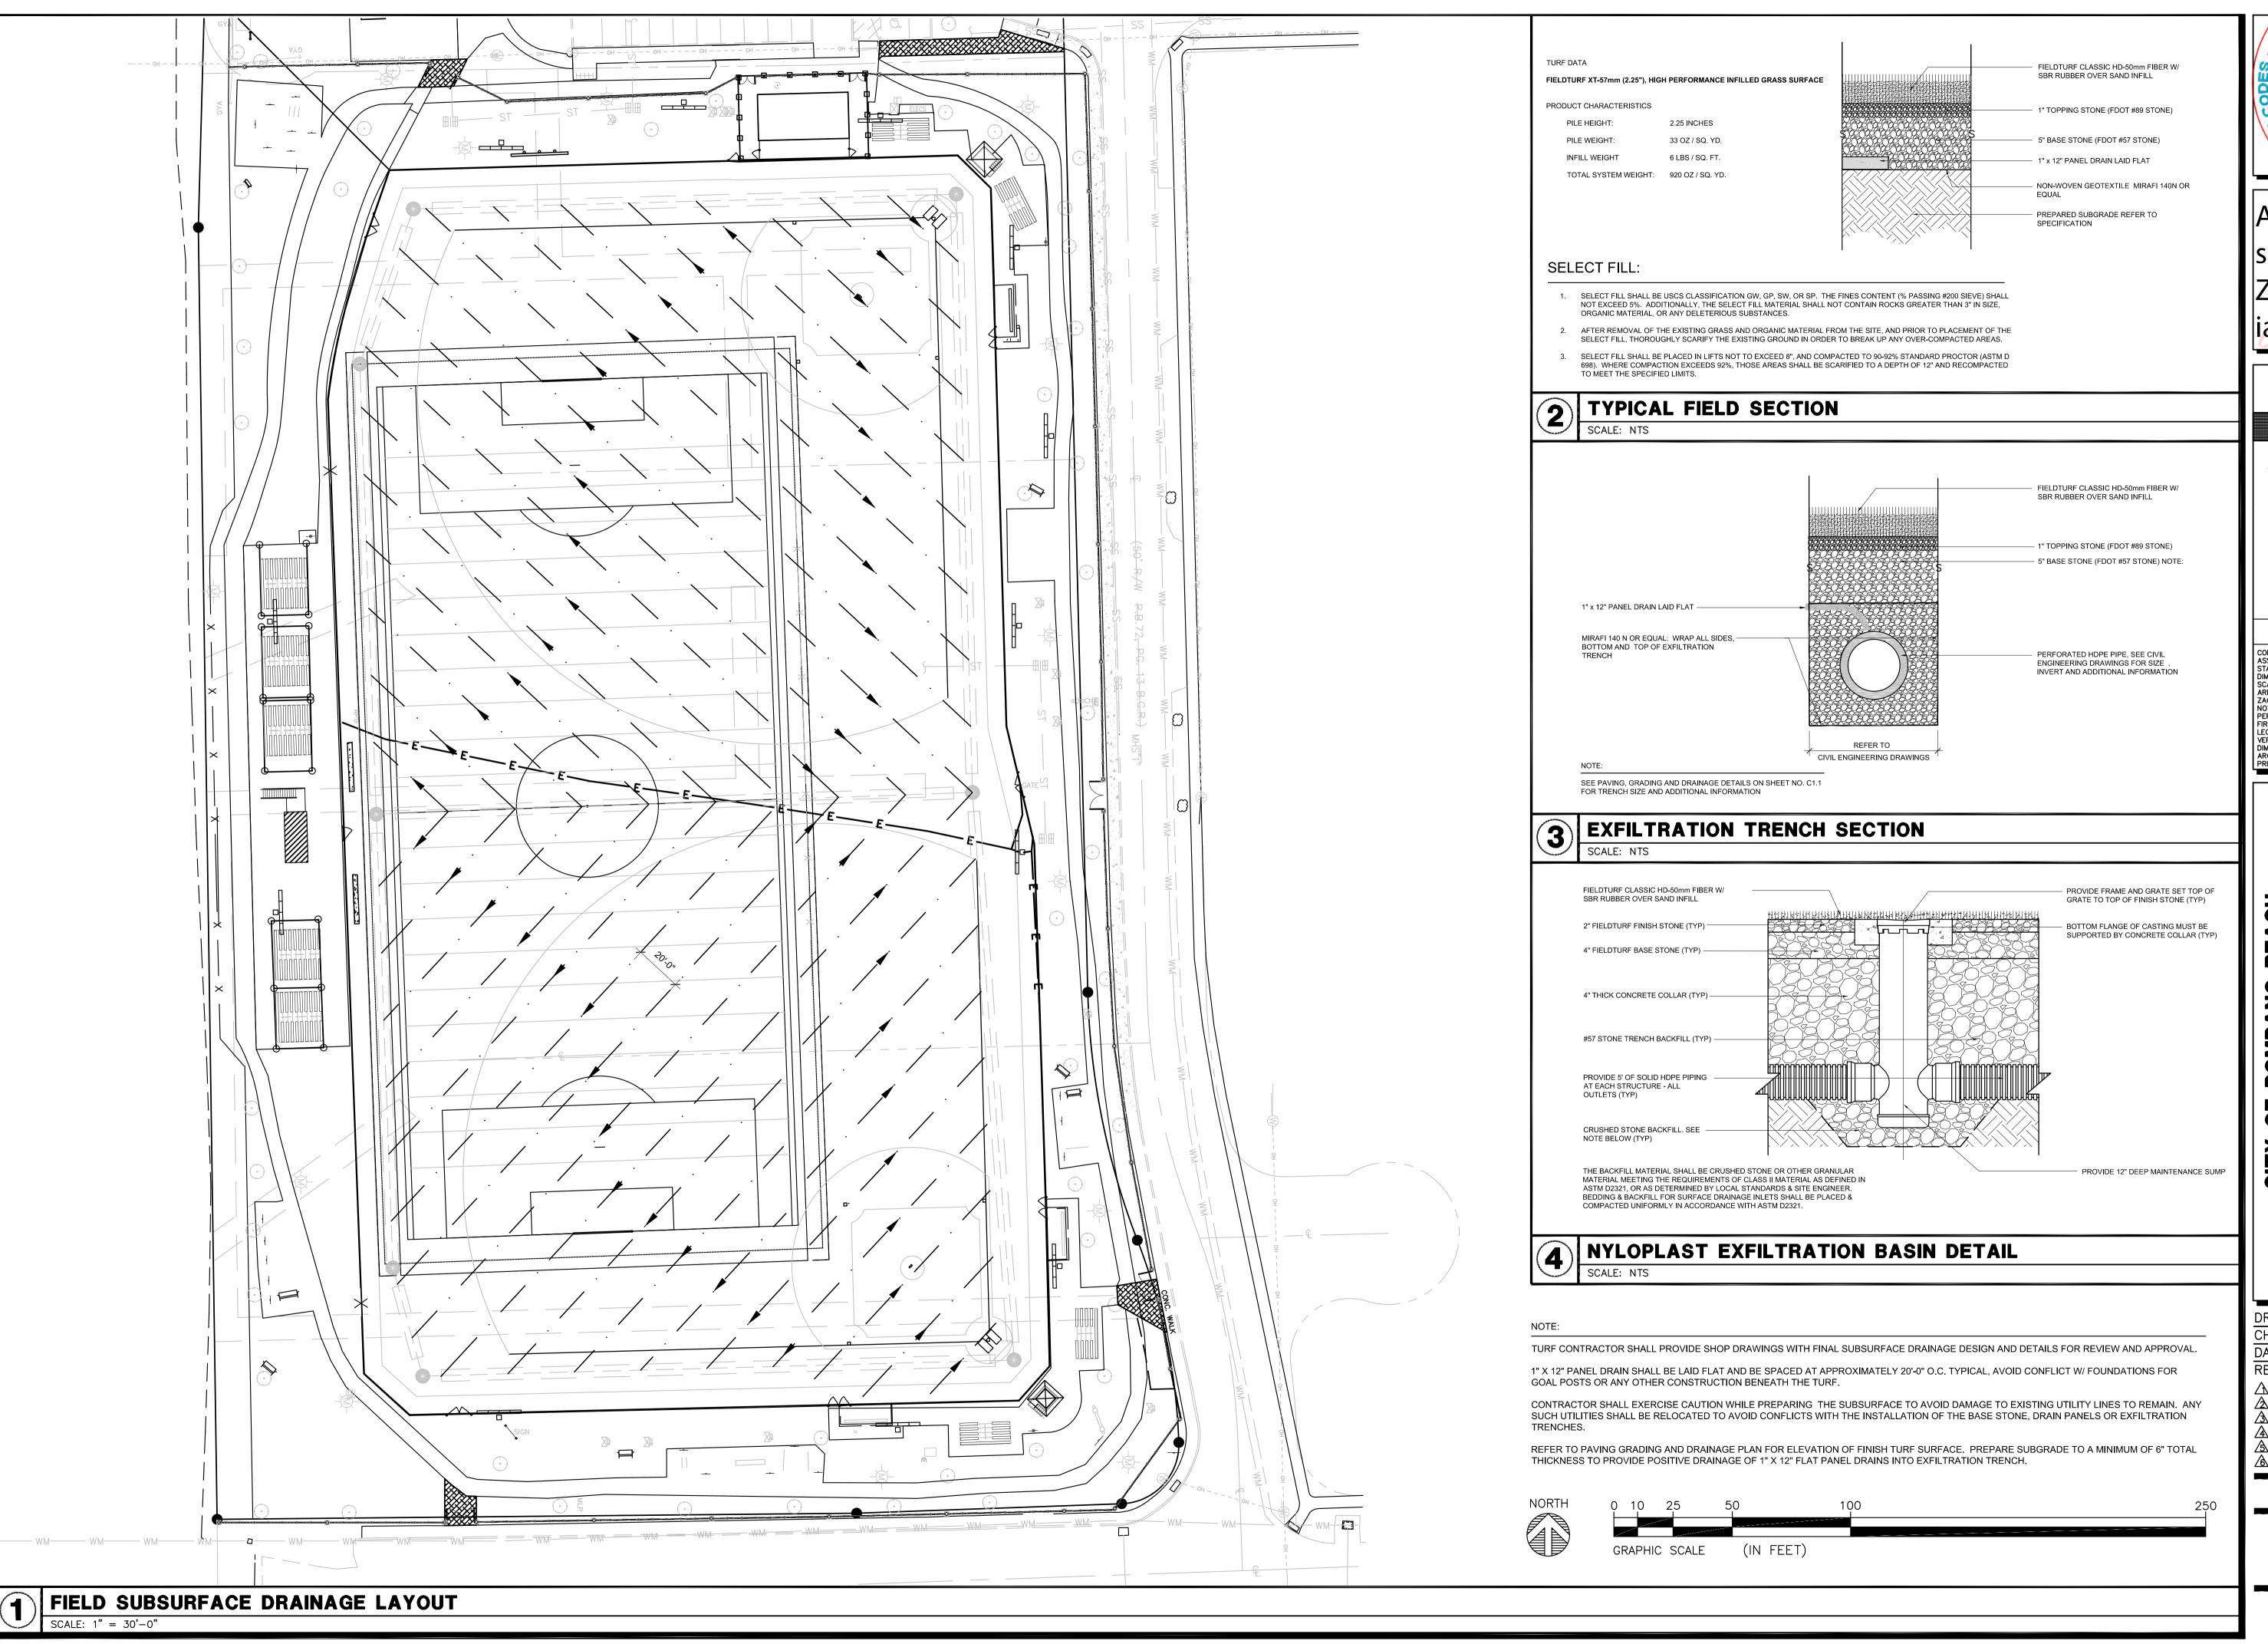

◯ \ SUBJECT TO ALL CODES O CITY OF POMPANO BEA

Abbas H Zackria DN: c=US, o=WALTERS ZACKRIA ASSOCIATESPLL ou=A01427E0000 Zackr 0167A29D317300 00583A, cn=Abba H Zackria Date: 2020.06.05 12:44:54 -04'00'



WALTERS ARCHITECTS

5813 N. ANDREWS WAY, FORT LAUDERDALE, FL 33309 PHONE: (954) 522-4123 FAX: (954) 522-4128


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DRAWN BY: DATE: 06/05/2020

CHECKED BY: **REVISIONS:**

TURF DRAINAGE INFO



SUBJECT TO ALL CODES CITY OF POMPANO BEA

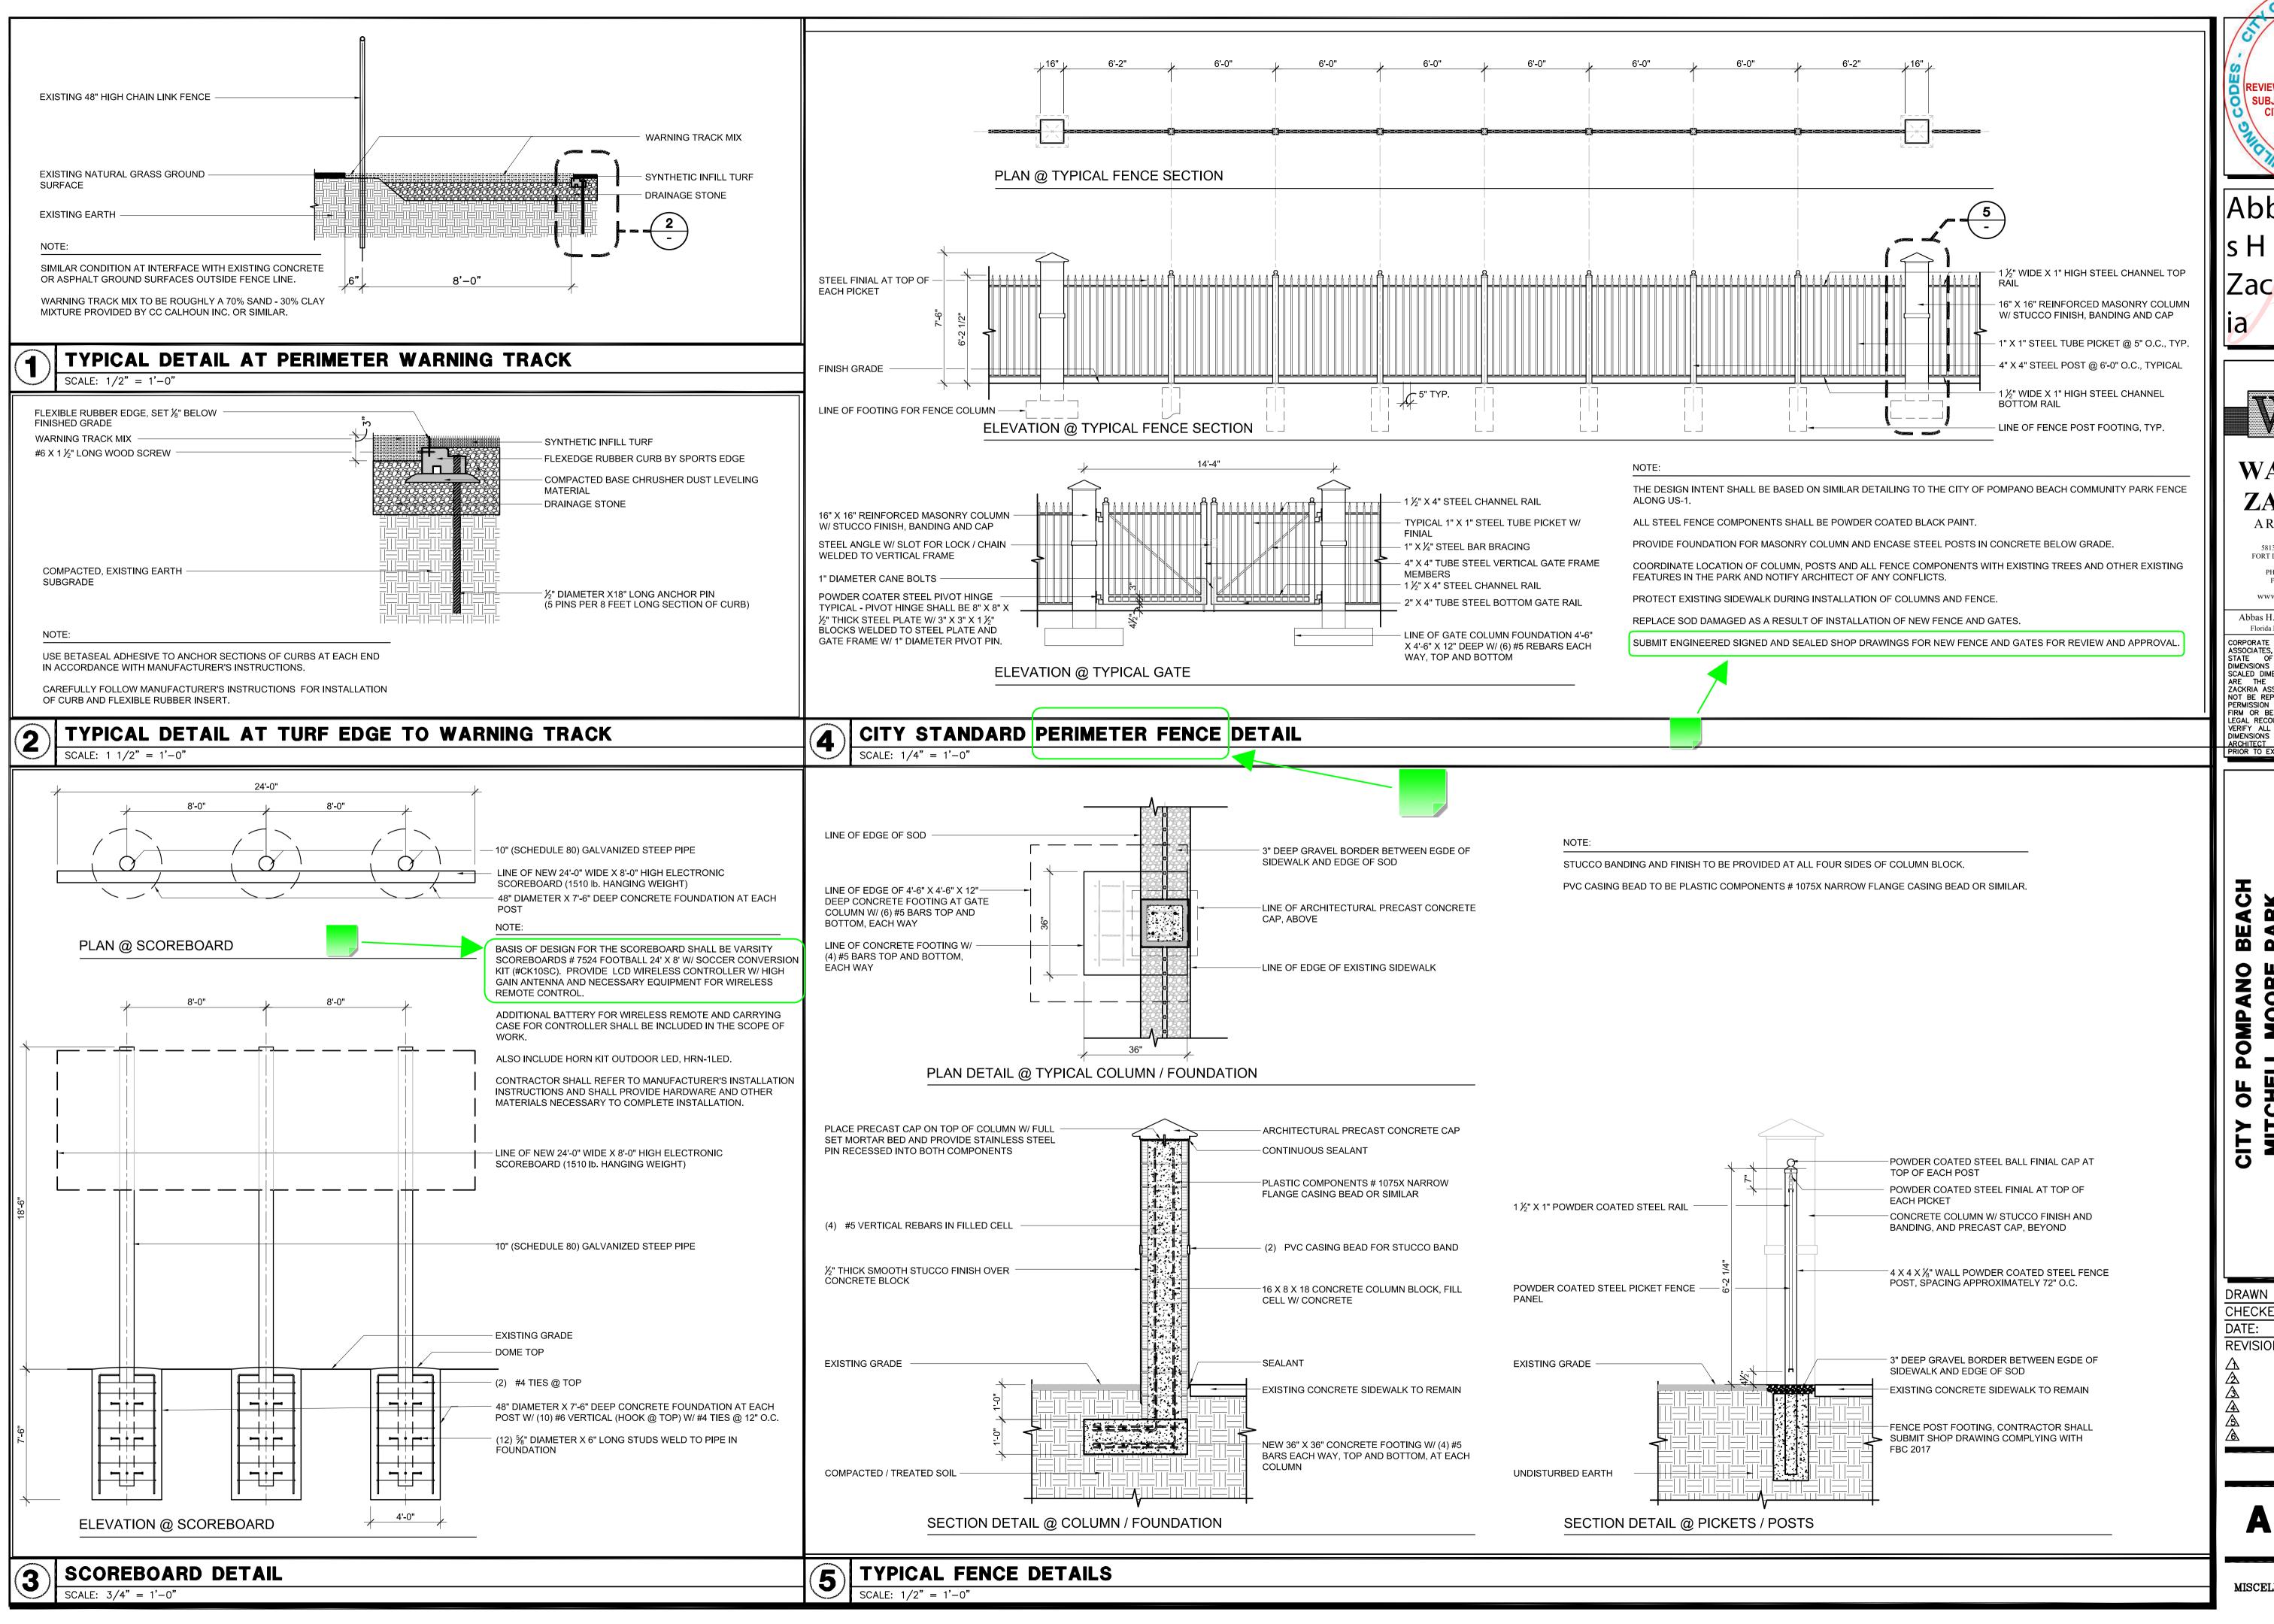Abbas H Zackria DN: c=US, o=WALTERS ZACKRIA ASSOCIATESPL ou=A01427E000 Zackr 00583A, cn=Abba C 0167A29D317300 H Zackria Date: 2020.06.05 12:45:40 -04'00'



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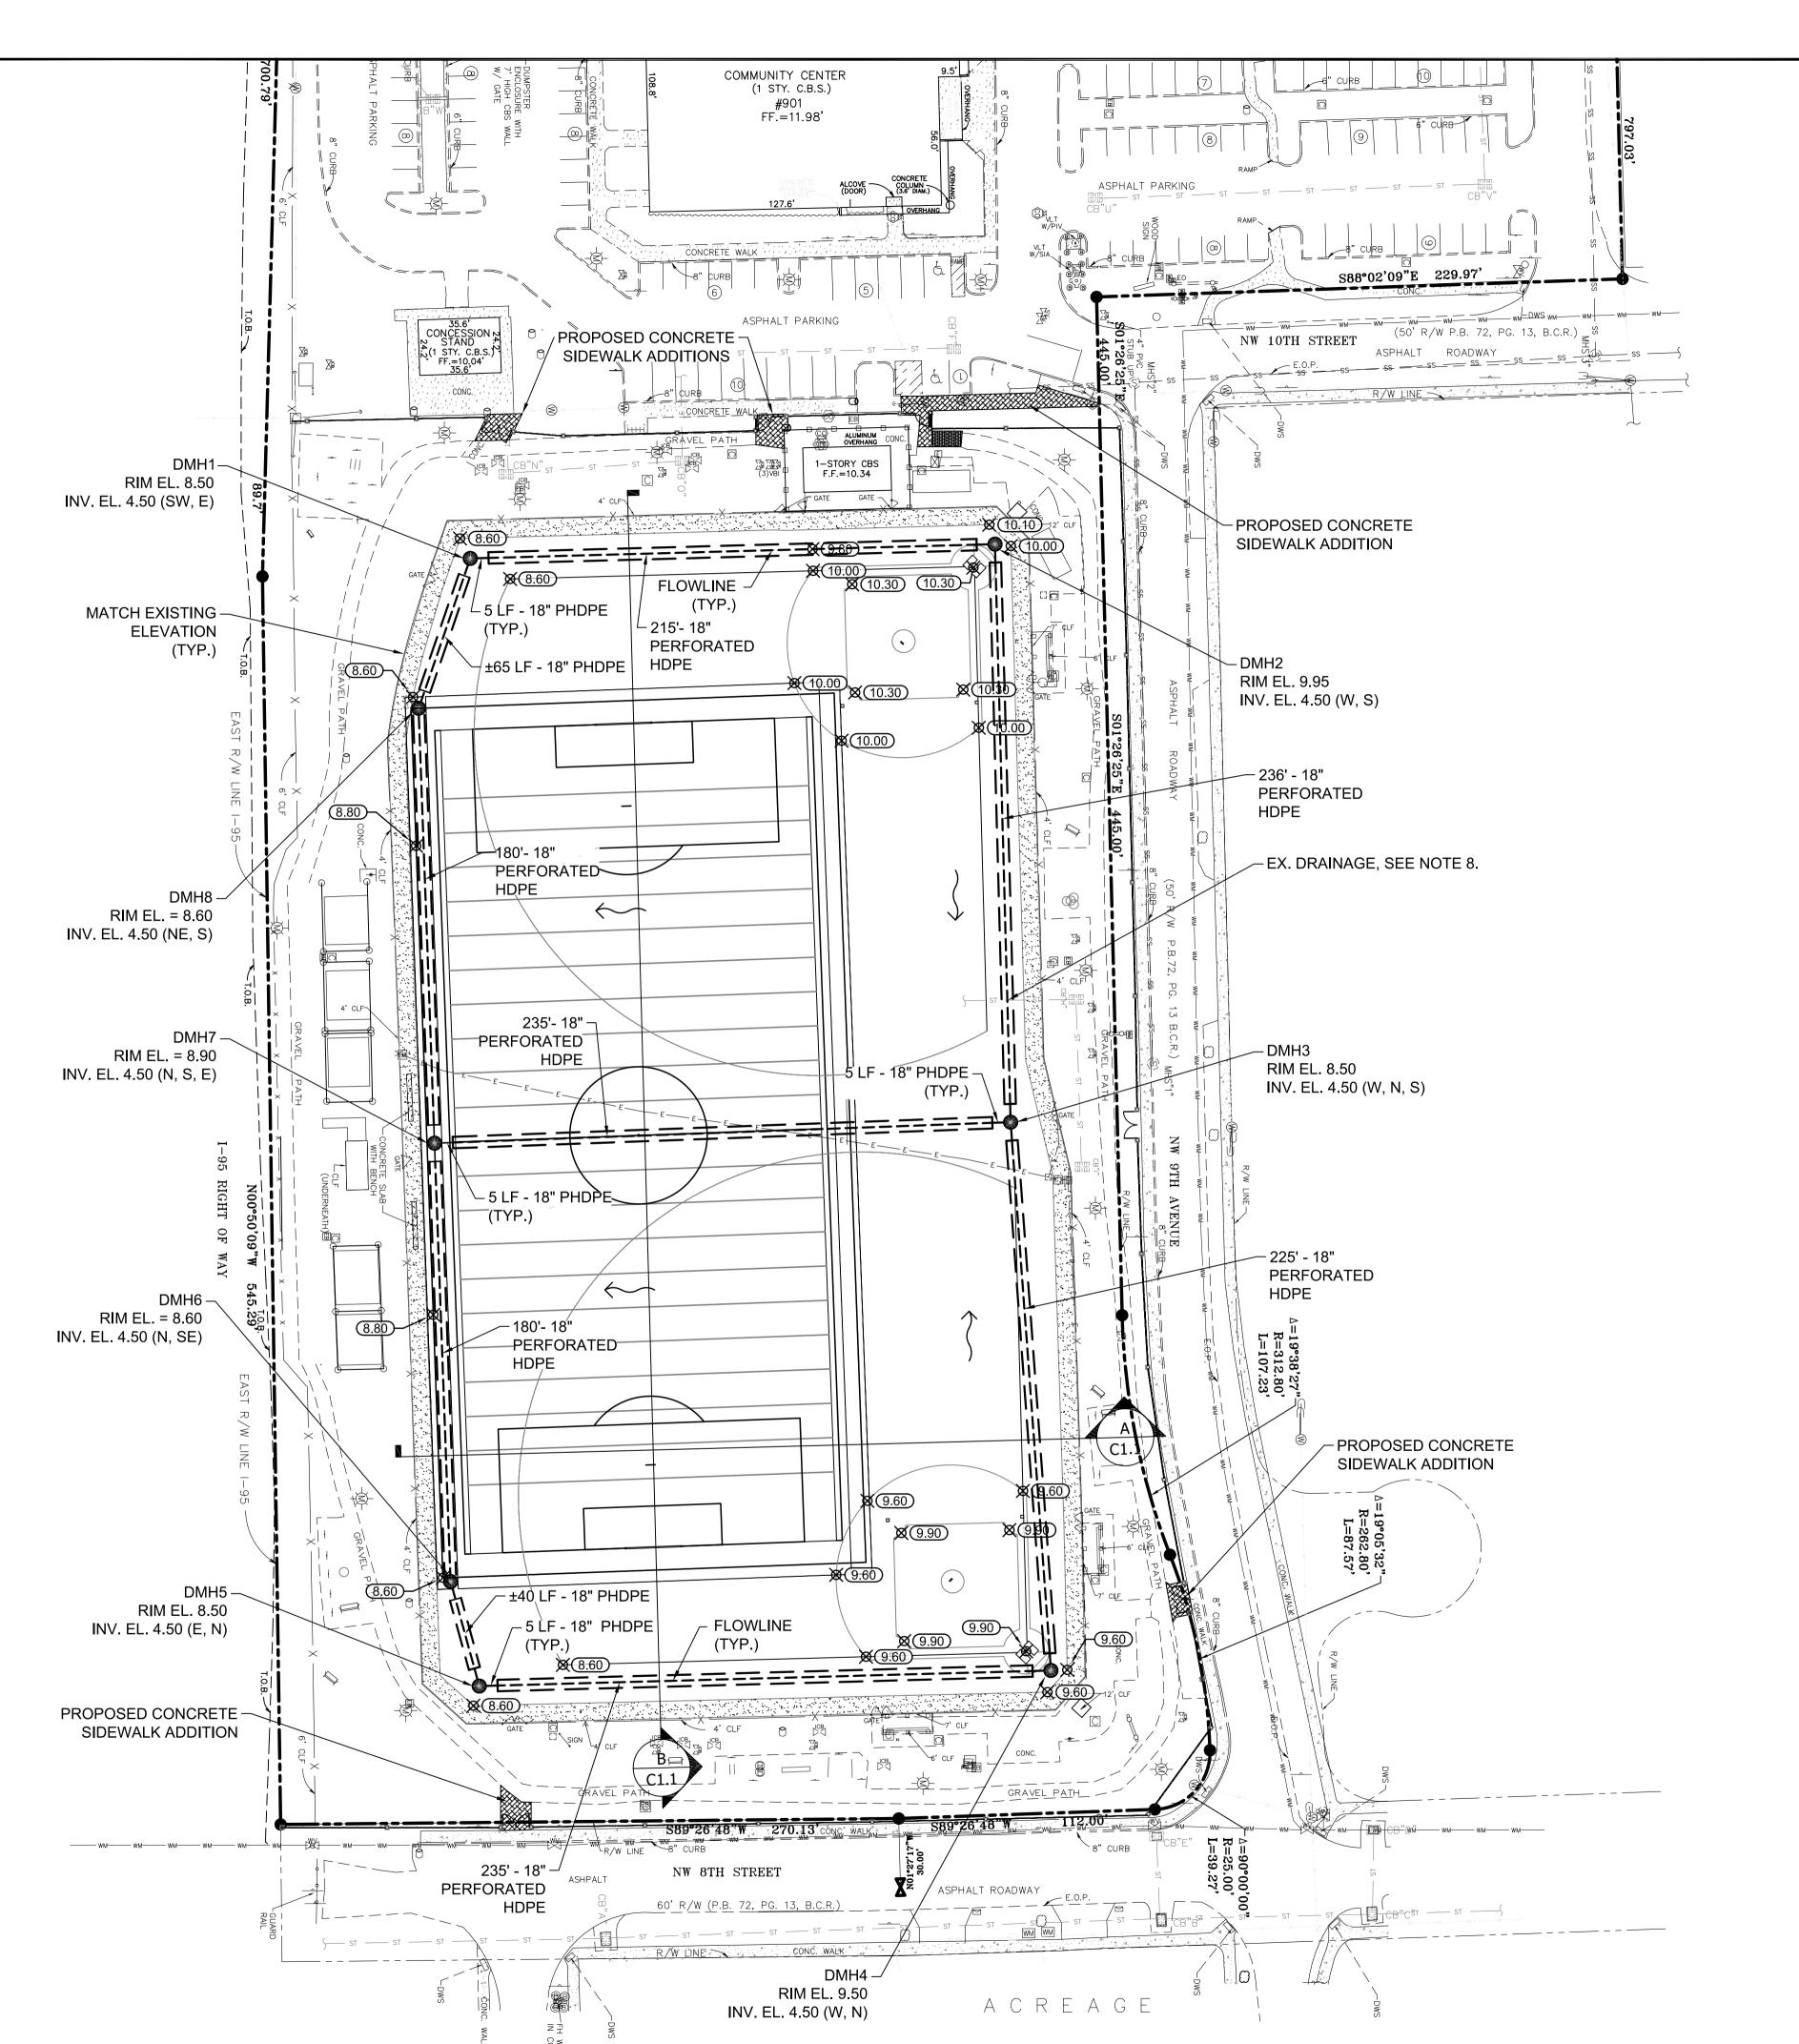
Abbas H. Zackria, FL AR 91520


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DRAWN BY: CHECKED BY: DATE: 06/05/2020 **REVISIONS:**

A2.10

MISCELLANEOUS DETAIL



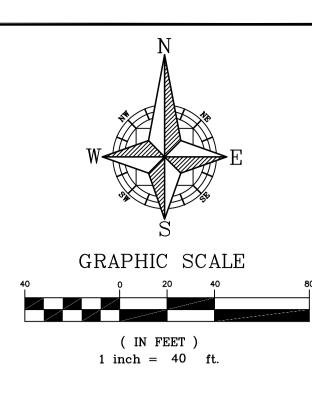


Total Site Summary:	SWM 200	06-181-0	SWM 200	06-181-2		This mod	lificatio
Site area (ac) Building area (ac) Pervious area (ac) Impervious area (ac) Avg Site Elevation Avg Site Elevation Retention Volume Retention Volume	6.400 0.00 4.11 2.29 11.37 9.795	100% 0% 64% 36% NGVD NAVD	6.400 0.00 4.34 2.06 11.26 9.69 16.00 1.33	100% 0% 68% 32% NGVD NAVD AC-in AC-ft	,	6.400 0.02 0.93 5.50 11.26 9.69 17.62 1.47	100% 0% 14% 86% NGVD NAVD AC-in
THIS PROJECT: Athletic Impervious (Artificial turf and Pervious Building		ack)	3.415 0.00 0.00	acres acres acres		100.00% 0.00% 0.00%	701

GENERAL NOTES:

- 1. EXISTING SITE SURVEY, PREPARED BY KCI, DATED 06/020/19.
- 2. REPORTOF GEOTECHNICALEXPLORATION, PREPARED BY FLORIDA ENGINEERING & TESTING, INC., DATED 06/10/19.
- 3. HYDRAULIC CONDUCTIVITY USUAL OPEN-HOLETEST, PREPARED BY FLORIDA ENGINEERING & TESTING, INC., DATED 06/10/19.
- 4. ELEVATIONS SHOWN ARE BASED ON THE NORTH AMERICAN VERTICAL DATUM OF 1988 (NAVD88).


 TO CONVERT FROM NAVD88 TO NGVD29, ADD 1.575 FEET.
- 5. SEASONAL HIGHWATERELEVATION PER LATEST BCEPDGM PERMIT MODIFICATION FOR SWM2006-181-3, WCE = 2.50 NAVD
- 6. BROWARD COUNTY FUTURE CONDITIONS AVERAGE WET SEASON GROUNDWATER ELEVATION = 4.00 NAVD/3.50 NAVD
- 7. SUBSURFACE DRAINAGE DESIGN IS PROVIDED ON SHEET A1.11.
- 8. EXISTING UTILITIES SHALL BE LOCATED AND IDENTIFIED BY CONTRACTOR. DISPOSITION SHALL BE DETERMINED BY THE CITY OF POMPANO BEACH PUBLIC WORKS DEPARTMENT.

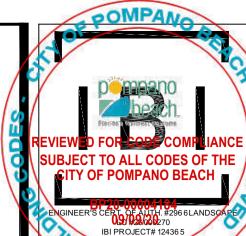

PATRI Digitally signed by PATRICIAF PATRICIAF RAMUDO Date: 2020.06.05

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-04'00'

NOT 10 BE FILED FOR RECORD UNLESS SIGNED AND DATED WITH THE ORIGINAL SEAL OF PATRICIAF. RAMUDO, FLORIDA E. #83798 FOR THE FIRM.

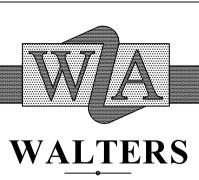

ZACKRIA ARCHITECTS

5813 N. ANDREWS WAY, FORT LAUDERDALE, FL 33309 PHONE: (954) 522-4123 FAX: (954) 522-4128 www.wza-architects.com

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TY OF POMPANO BEACH
MITCHELL MOORE PARK
IMPROVEMENTS
861 NW 9TH AVENUE


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REVISIONS:


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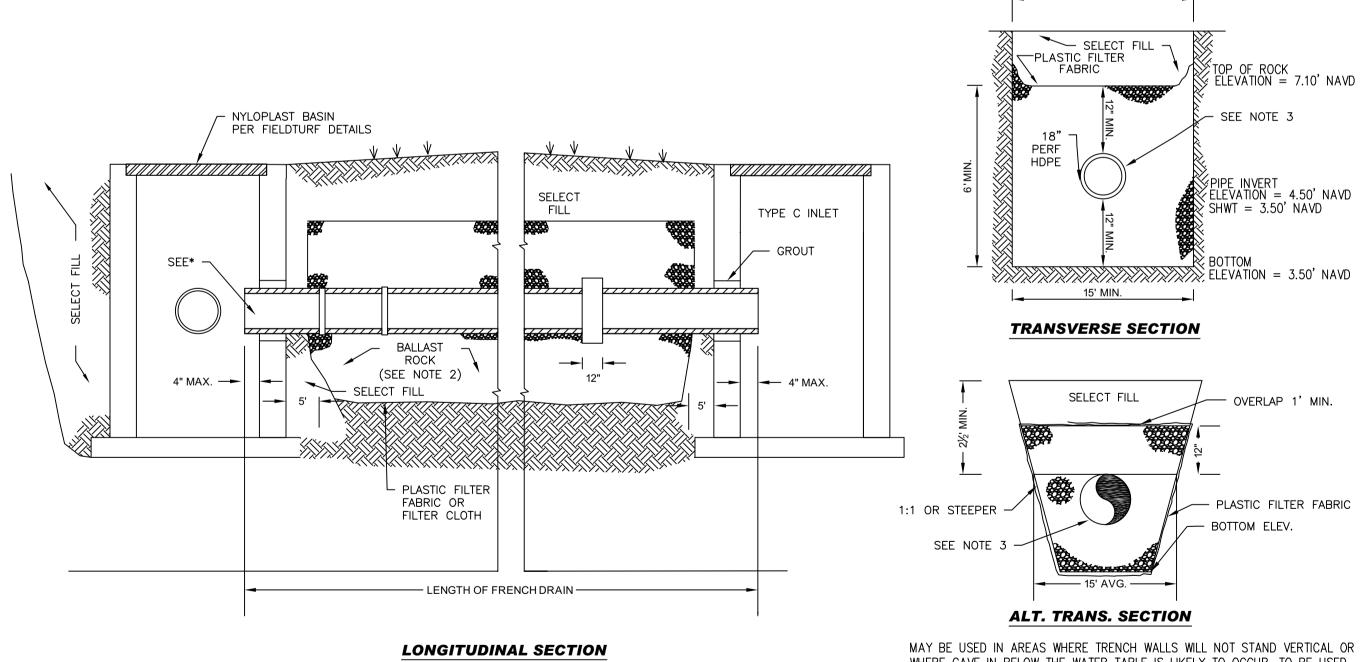


PAVING, GRADING & DRAINAGE PLAN



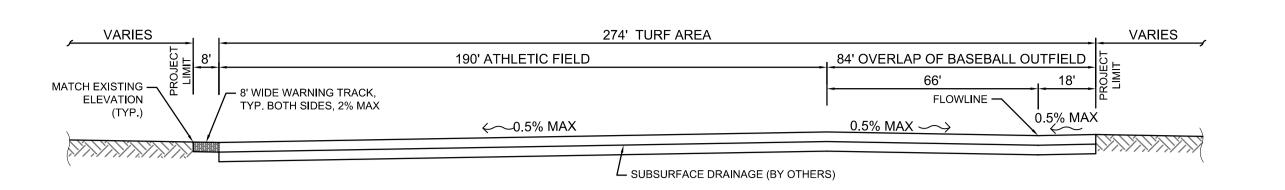

NOTE: SUBSURFACE DRAINAGE DESIGN AND DETAILS ARE TO BE PROVIDED BY TURF CONTRACTOR.

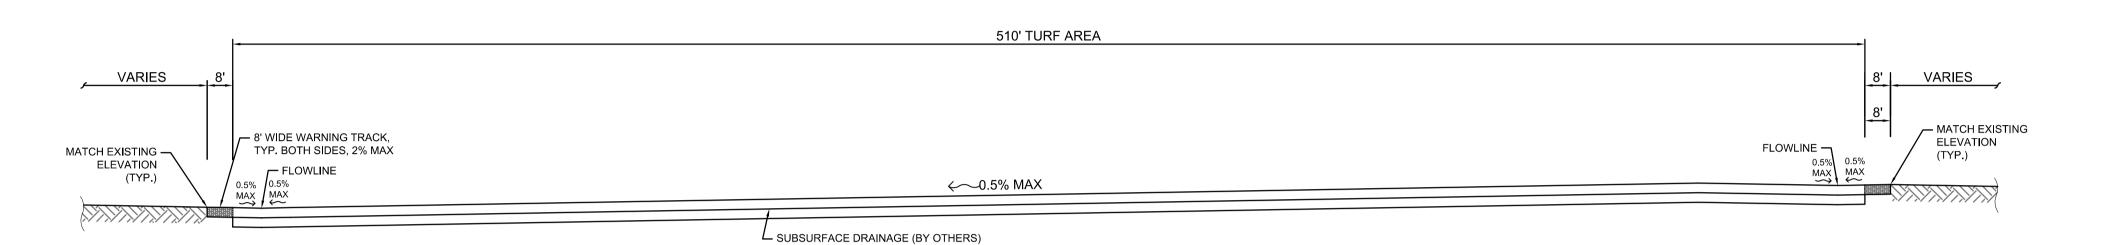


NOTE:

WHERE CAVE IN BELOW THE WATER TABLE IS LIKELY TO OCCUR. TO BE USED AT THE ENGINEER'S DISCRETION.

- 1. PLASTIC FILTER FABRIC OR FILTER CLOTH (AT EA. SIDE, TOP AND BOTTOM) SHALL BE USED IN SANDY AREAS AS NOTED IN PLANS AND/OR AS DIRECTED BY THE ENGINEER.
- 2. IF BALLAST ROCK IS NOT PRE-WASHED, AFTER IT HAS BEEN PLACED TO THE PROPER ELEVATION, IT SHALL BE CAREFULLY WASHED DOWN WITH CLEAN WATER IN ORDER TO ALLOW FOR INITIAL SETTLEMENT THAT MAY OCCUR. IF IT DOES TAKE PLACE, ADDITIONAL BALLAST ROCK WILL BE ADDED TO RESTORE THE BALLAST ROCK TO THE PROPER ELEVATION, SO THAT THE EXFILTRATION TRENCH BE COMPLETED IN ACCORDANCE WITH THE DETAILS.
- 3. INVERT ELEVATION TO BE AS SHOWN IN PLANS. 4. REFER TO FIELDTURF DETAILS FOR PANEL DRAIN CONNECTIONS.


NOTES:

EXFILTRATION TRENCH DETAIL

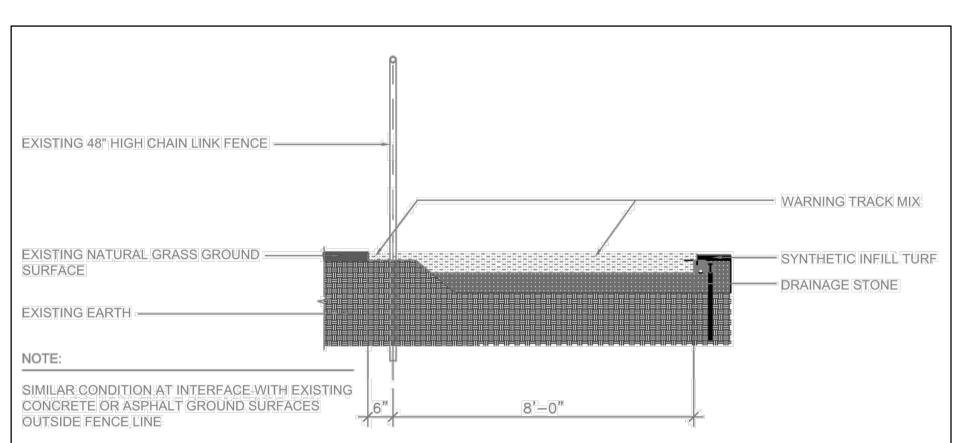

WARNING TRACK TYPICAL SECTION N.T.S.

UBJECT TO ALL CODES OF THE

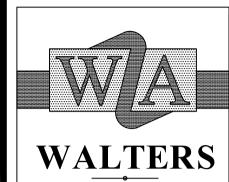

ZACKRIA ARCHITECTS

FORT LAUDERDALE, FL 33309 PHONE: (954) 522-4123 FAX: (954) 522-4128

5813 N. ANDREWS WAY,


www.wza-architects.com Abbas H. Zackria, FL AR 91520


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BEACH PARK TS 1UE OMPANO MOORE

DRAWN BY: CHECKED BY: 06/05/2020 DATE: **REVISIONS:**

PAVING. GRADING & DRAINAGE TYPICAL SECTIONS AND DETAILS



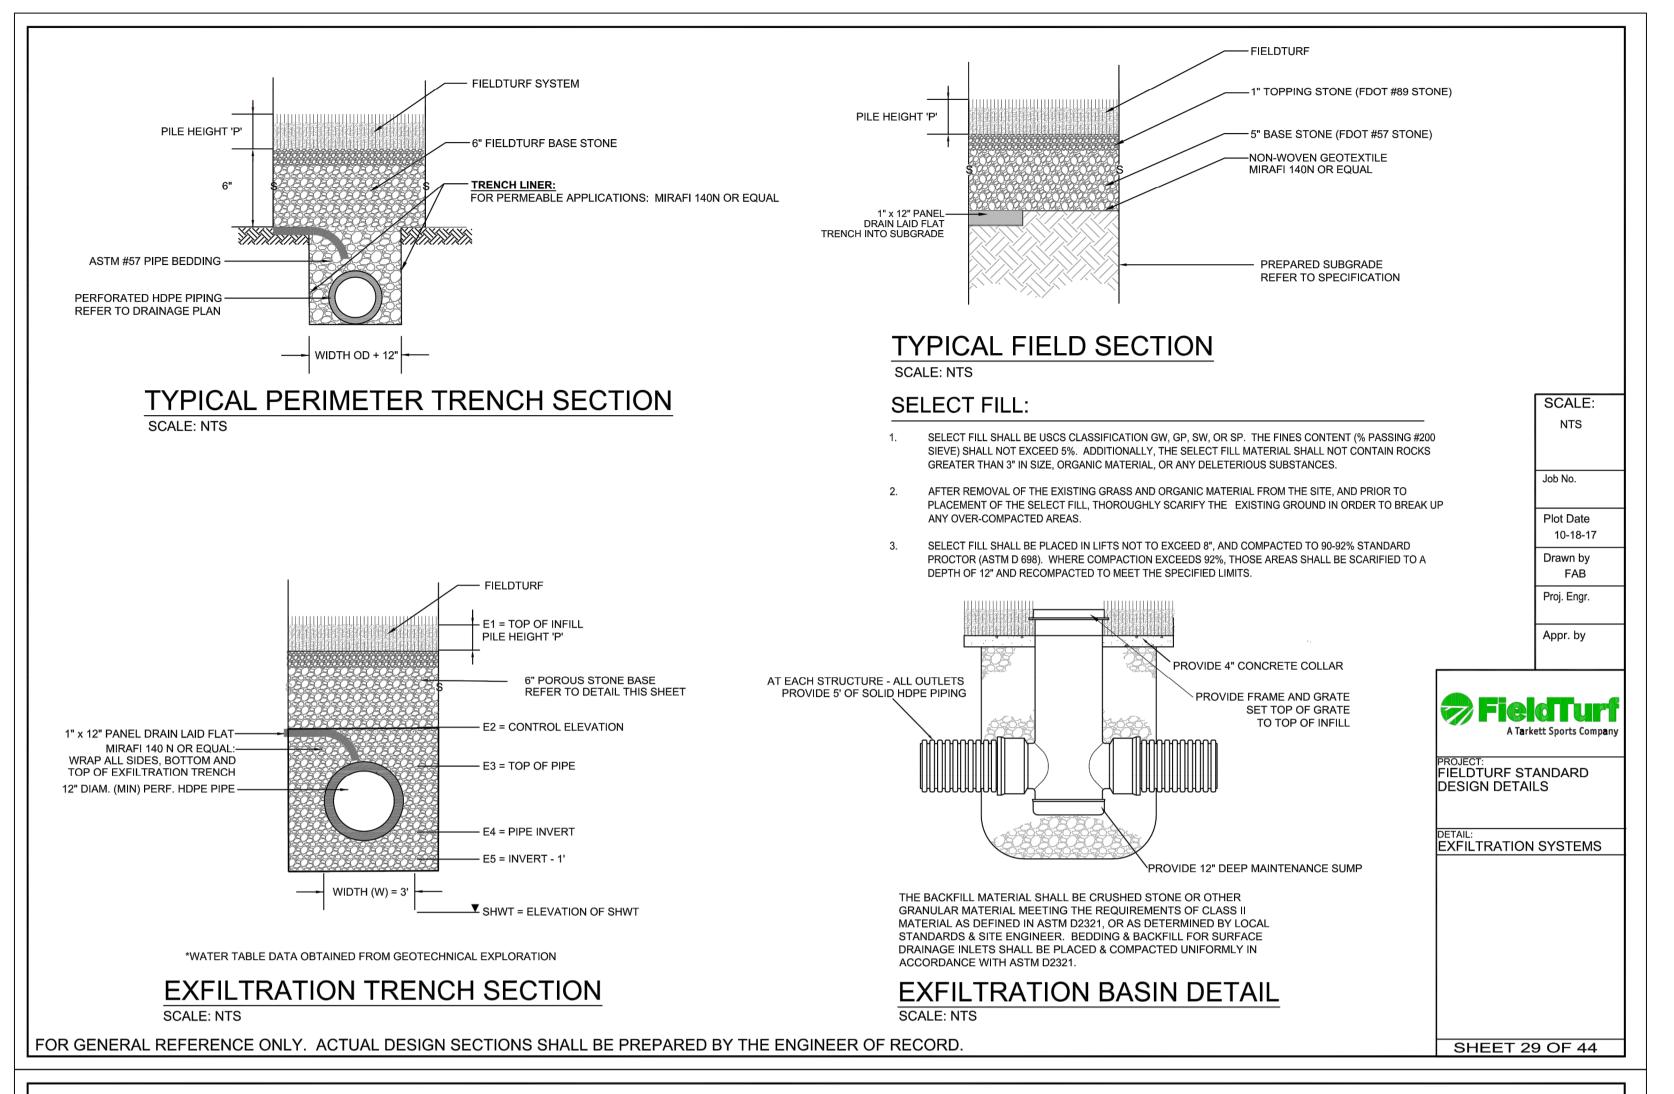

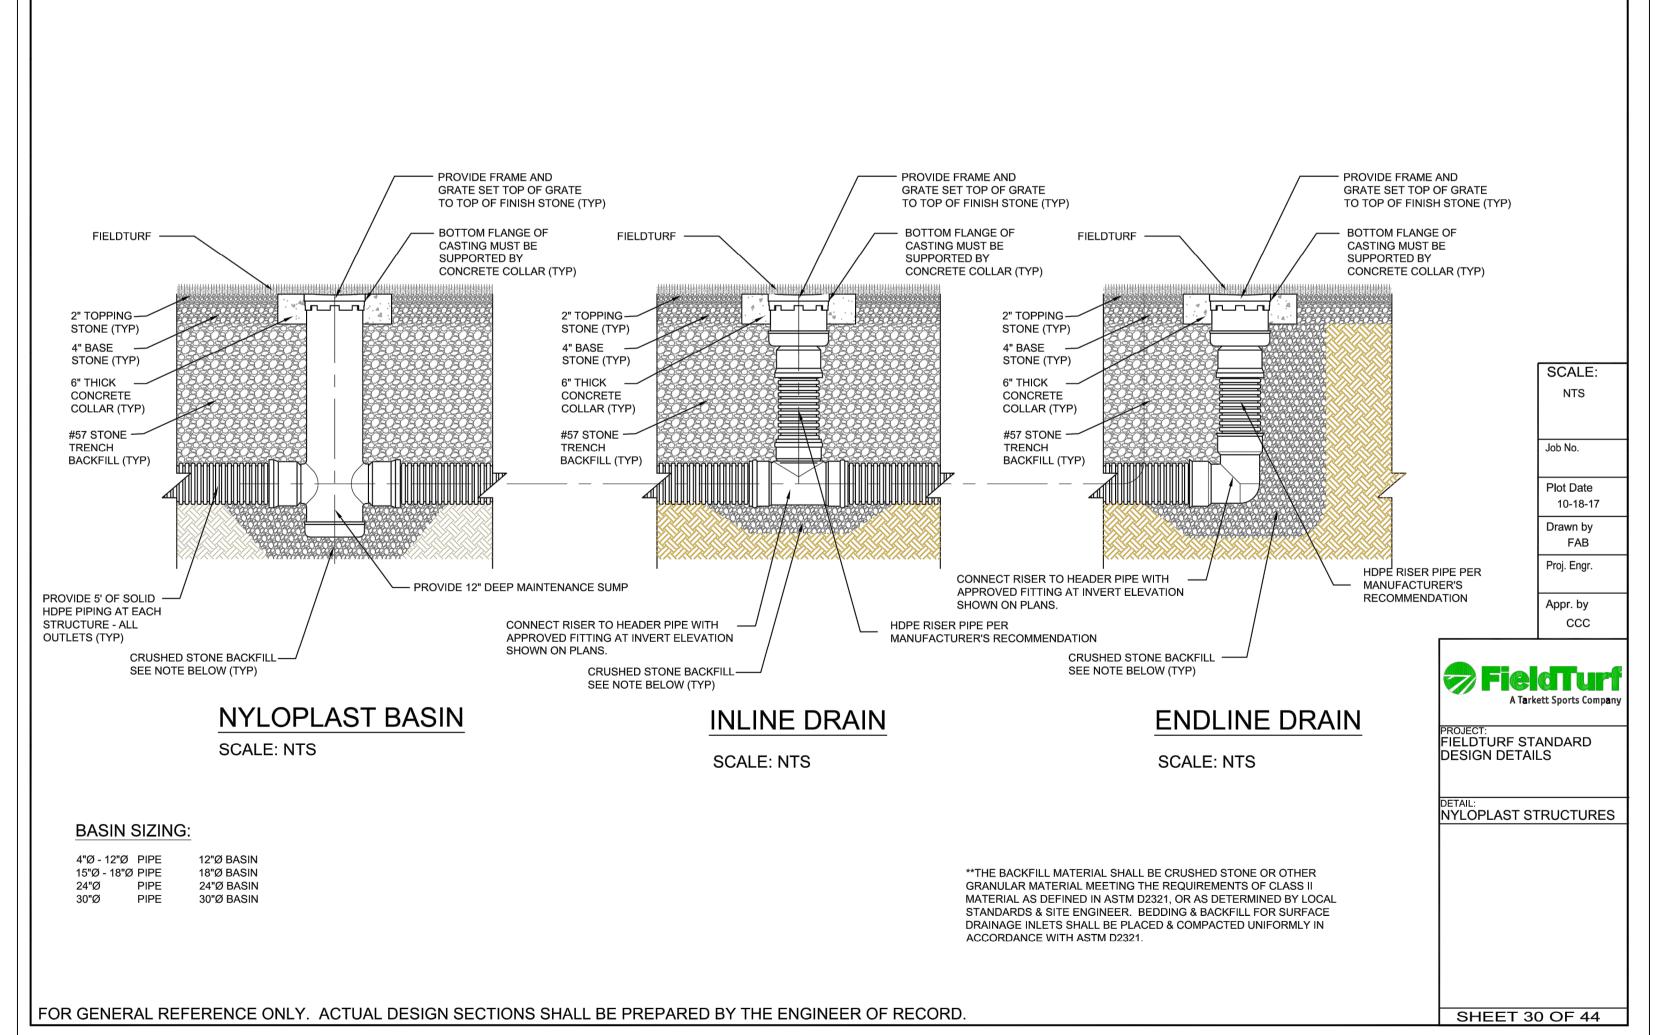


PATRICIARY signed by signed by PATRICIAF RAMUDO PATRICIAF RAMUDO Date:

2020.06.05

10:42:07

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ARCHITECTS

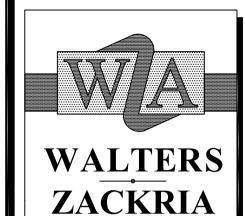5813 N. ANDREWS WAY,
FORT LAUDERDALE, FL 33309

PHONE: (954) 522-4123 FAX: (954) 522-4128

www.wza-architects.com

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CITY OF POMPANO BEACH
MITCHELL MOORE PARK
IMPROVEMENTS


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DATE: 06/05/2020
REVISIONS:


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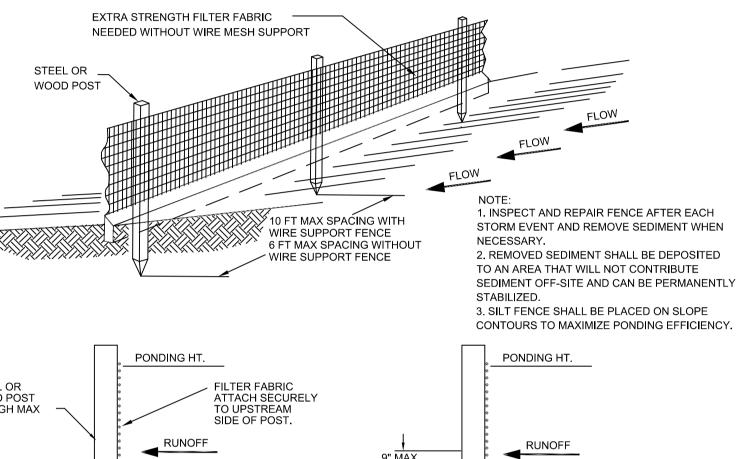
PAVING, GRADING & DRAINAGE DETAILS







GENERAL NOTES:

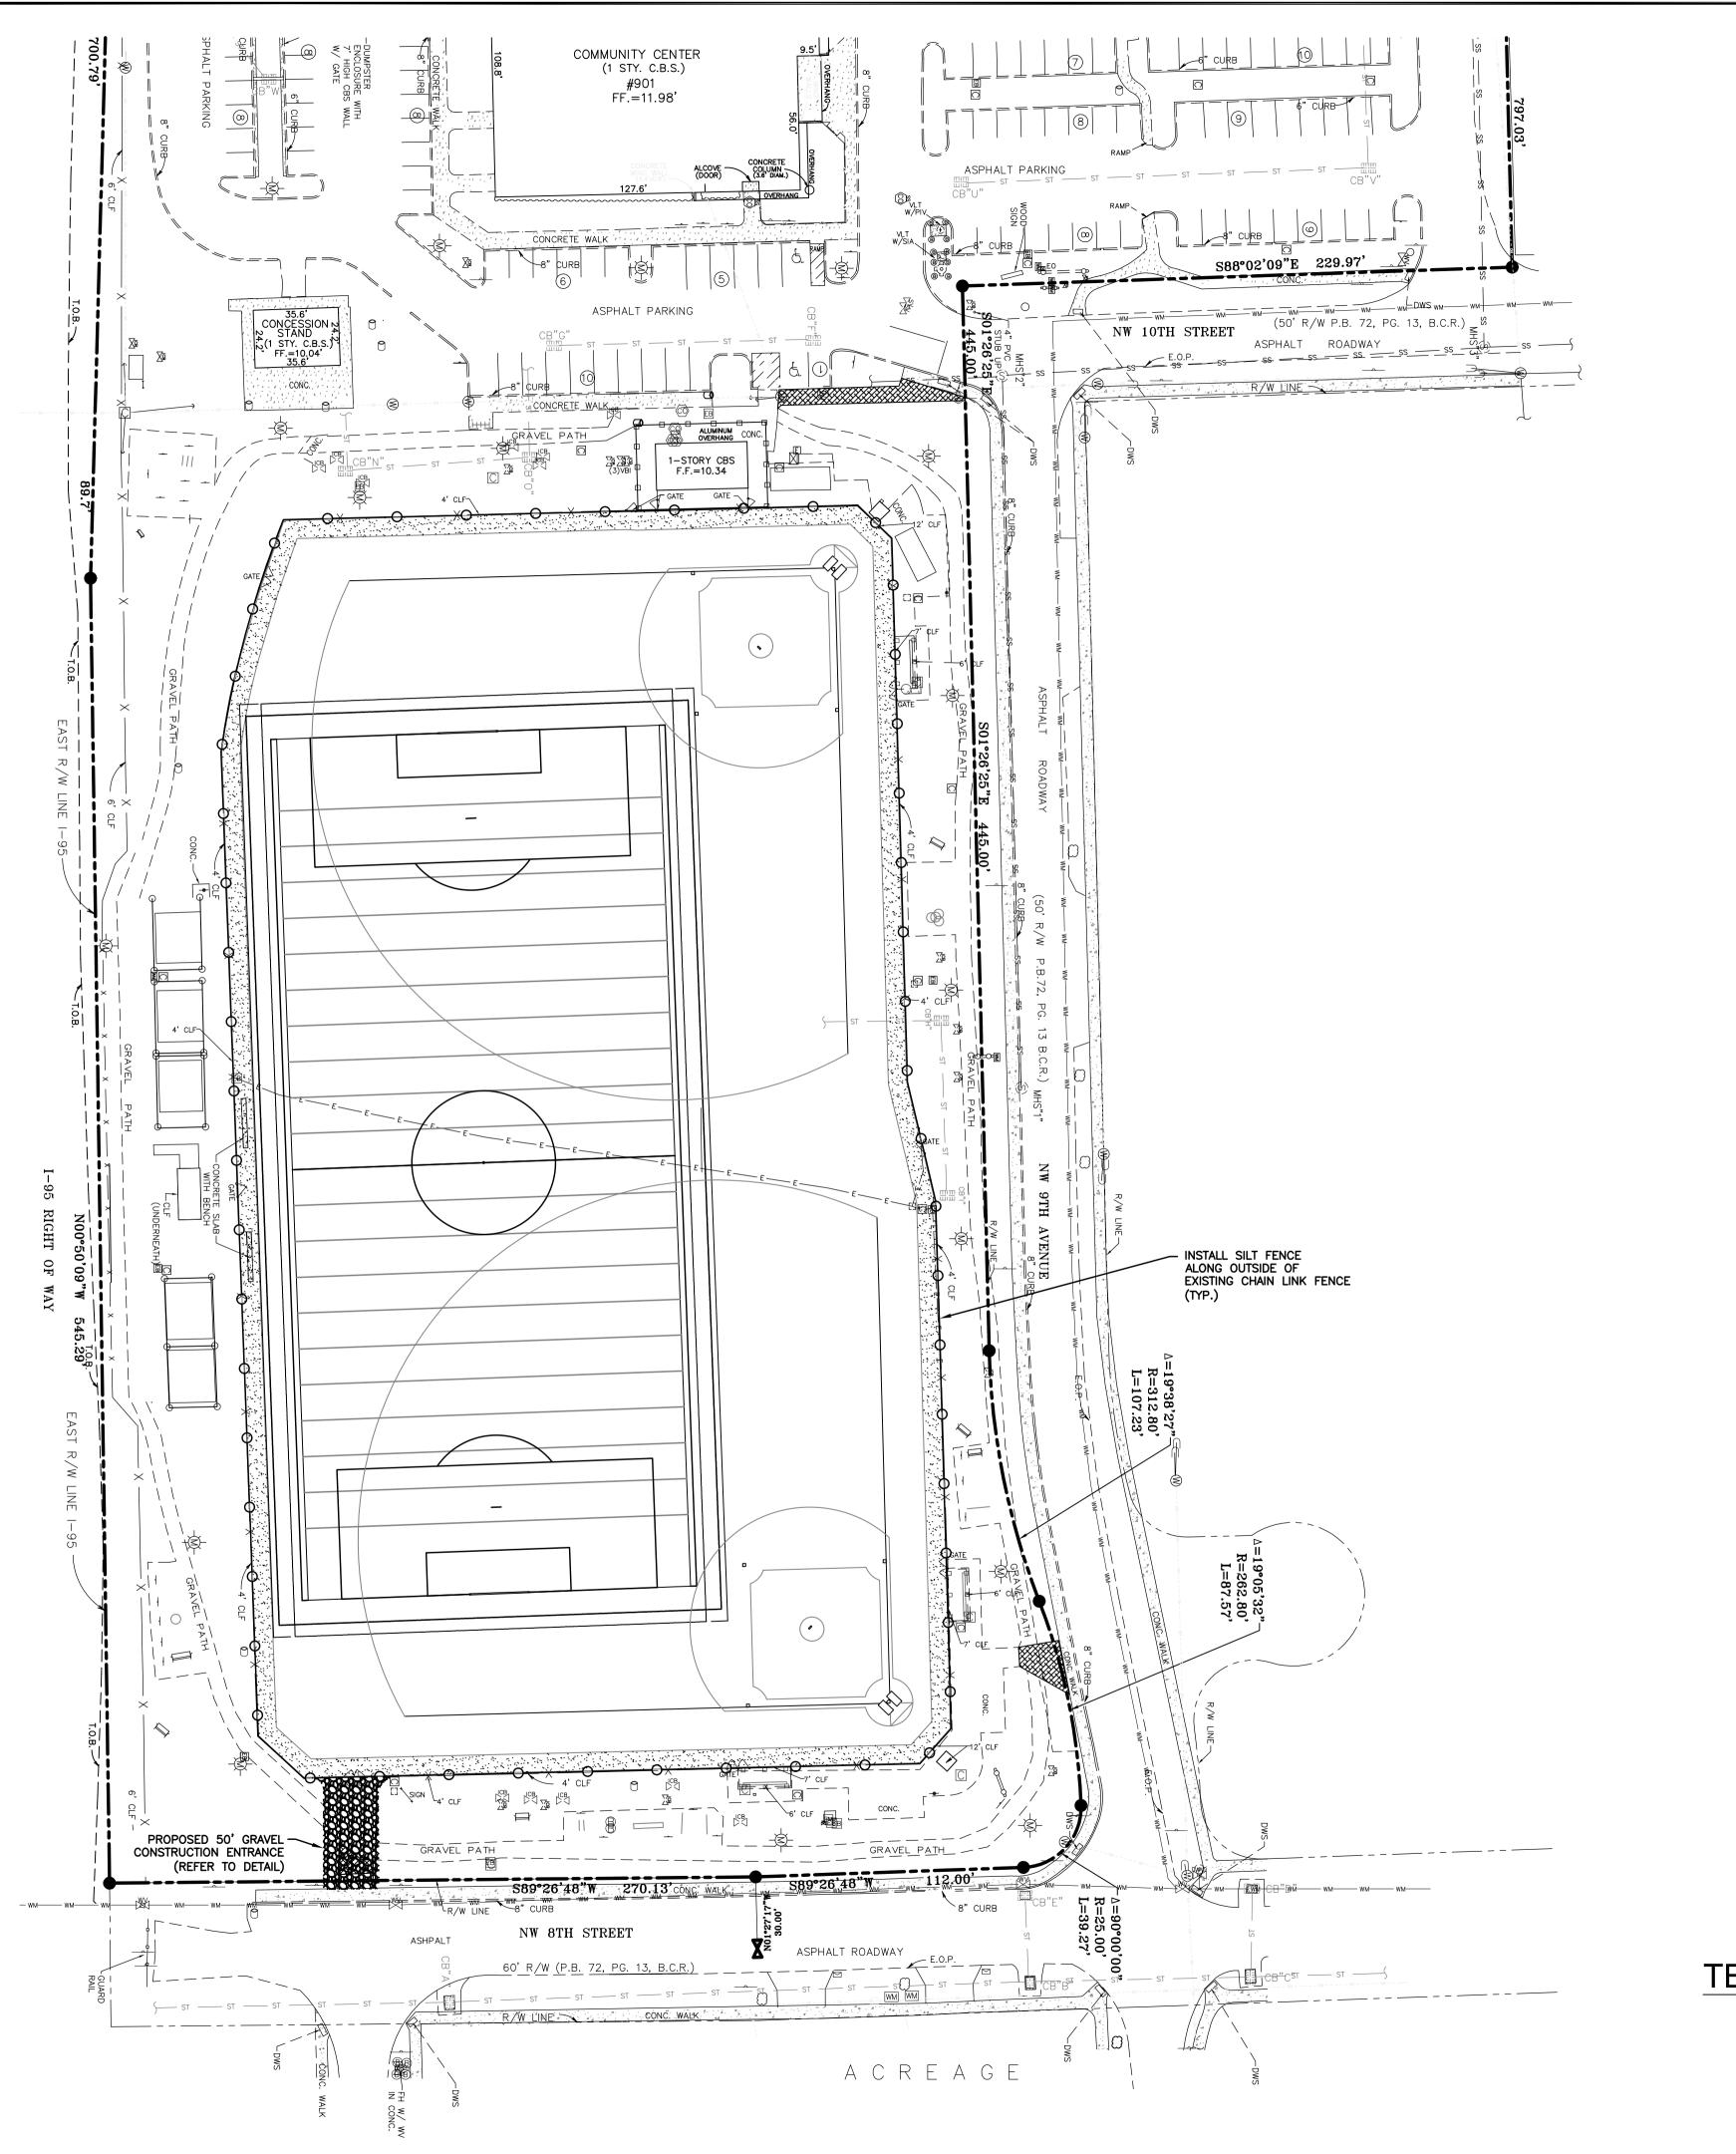1. CONSTRUCTION ACTIVITIES AND OPERATIONS SHALL BE MAINTAINED DURING AND AFTER ALL CONSTRUCTION, DEVELOPMENT EXCAVATION OR ALTERATION OPERATIONS, STRUCTURAL AND NON-STRUCTURAL BEST MANAGEMENT PRACTICES WITH THE INTENT TO REDUCE POLLUTANTS AND SEDIMENT IN STORMWATER RUNOFF. REFERENCE CITY ORDINANCE 53.16 (A)(1).

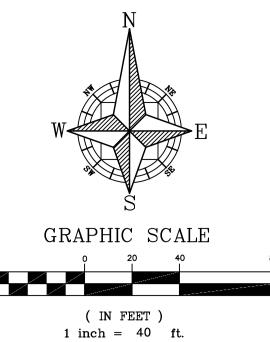


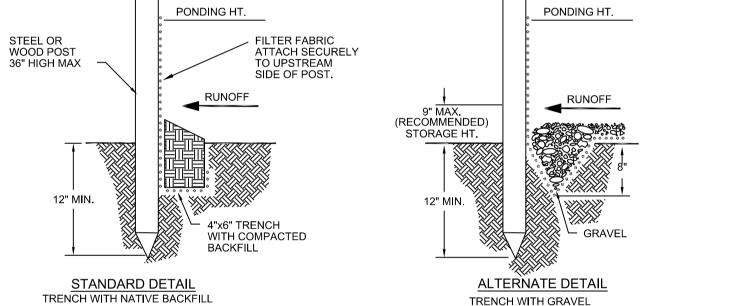


SILT FENCE DETAIL

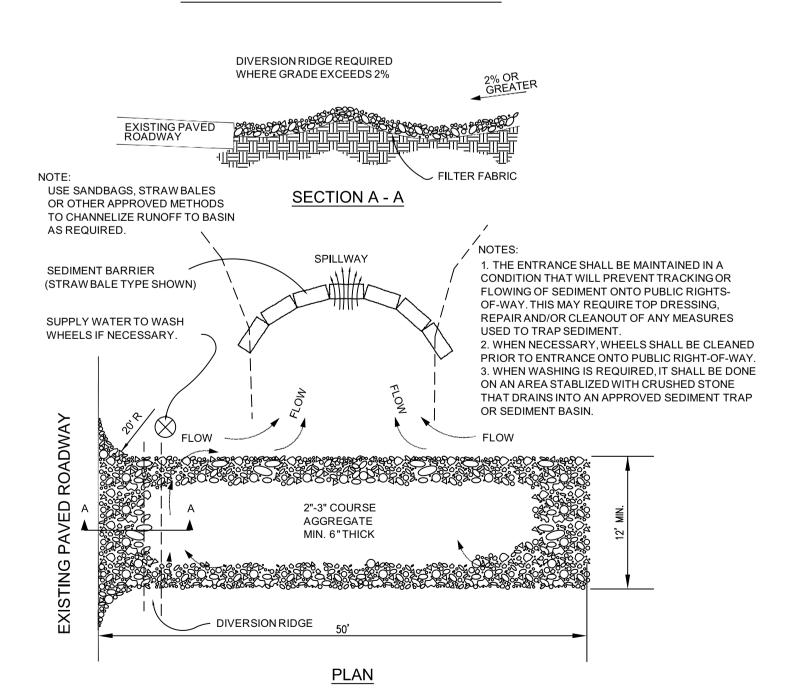

TEMPORARY GRAVEL CONSTRUCTION ENTRANCE/EXIT

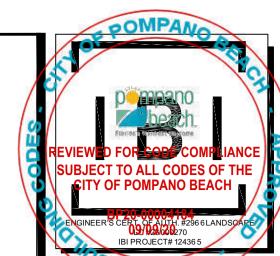

PATRI Digitally signed by PATRICIAF RAMUDO Date: 2020.06.05

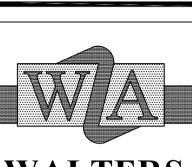

WALTERS ZACKRIA

ARCHITECTS

5813 N. ANDREWS WAY,

FORT LAUDERDALE, FL 33309

PHONE: (954) 522-4123

FAX: (954) 522-4128

www.wza-architects.com

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ARCHITECT OF ANY DISCREPANCIES
PRIOR TO EXECUTION OF WORK.

CHELL MOORE PARK
IMPROVEMENTS
861 NW 9TH AVENUE

DRAWN BY: CMP
CHECKED BY: PFR
DATE: 06/05/2020

REVISIONS:

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EROSION CONTROL

GENERAL ELECTRICAL NOTES (GENERAL NOTES ARE PROVIDED AS A BASIC DESCRIPTION OF THE EXTENT AND QUALITY EXPECTED IN THIS PROJECT. IF A CONFLICT EXISTS BETWEEN THESE GENERAL NOTES AND THE REMAINDER OF THE CONTRACT DOCUMENTS THE SPECIFICATIONS. PLANS AND DETAILS WILL GOVERN.) THE ENTIRE INSTALLATION SHALL BE IN ACCORDANCE WITH THE FOLLOWING CODES AND STANDARDS: 29. ALL FUSES SHALL BE CURRENT LIMITING, PER U.L., RATED 600V., UON. FLORIDA STATE FIRE MARSHALL'S RULE 69A-3.012 FAC AND NON-TIME DELAY FUSES IN MAIN SWITCHES AND SWITCHES FEEDING PAN TIME DELAY FUSES FOR MOTOR AND A/C CIRCUITS. RULE CHAPTER 69A-60 FLORIDA ADMINISTRATIVE CODE (FAC) AND FLORIDA STATUTE SECTION 633.022. 30. ALL DISCONNECT SWITCHES SHALL BE SIZED BY NEC REQUIREMENTS TO ACCO A. NEPA 70: NATIONAL ELECTRICAL CODE (2014 EDITION) SERVED, INCLUDING REQUIRED FUSES U.O.N. SWITCHES SHALL BE HORSEPOWE B. NFPA 72: NATIONAL FIRE ALARM CODE (2013 EDITION) HORSEPOWER, HEAVY DUTY TYPE. . NFPA 99: HEALTH CARE FACILITIES (2015 EDITION) 31. CONTRACTOR SHALL VERIFY CIRCUIT PROTECTIVE DEVICE RATING FOR EQUIPMEN INSTALLATION. . NFPA 110: STANDARD FOR EMERGENCY AND STANDBY POWER SYSTEMS (2013 EDITION) . NFPA 780: STANDARD FOR THE INSTALLATION OF LIGHTNING PROTECTION SYSTEMS (2014 EDITION) 32. FURNISH AND INSTALL DISCONNECT SWITCHES AND WIRING FOR AIR CONDITION MANUFACTURER RECOMMENDATIONS. CONTROLS ARE TO BE SUPPLIED BY AIR IN ADDITION, THE INSTALLATION SHALL ALSO BE IN ACCORDANCE WITH THE FOLLOWING CONTRACTOR AND CONNECTED. PROVIDE ALL CONTROL WIRING FOR A/C SENSO G. FLORIDA BUILDING CODE 2017 6th EDITION (FBC) H. THE GUIDELINES FOR DESIGN AND CONSTRUCTION OF HEALTH CARE FACILITIES UNITS. COORDINATE WITH A/C CONTRACTOR FOR WIRING DIAGRAMS AND EXACT FGI GUIDFLINFS, 2014 FDITION) 33. ALL ELECTRICAL EQUIPMENT SHALL BE RAINTIGHT WHERE EXPOSED TO THE WE FLORIDA FIRE PREVENTION CODE (2015 EDITION) CONDUITS CONNECTED TO SUCH EQUIPMENT SHALL BE LIQUID TIGHT. AS A MINIMUM, ALL EQUIPMENT SHALL MEET APPLICABLE STANDARDS, FOR THE TYPE OF 34. EQUIPMENT SHALL BE OF MATERIALS SUITABLE FOR AND NEMA RATED FOR TH EQUIPMENT AND INTENDED USE, OF THE FOLLOWING: WHICH THEY ARE TO BE INSTALLED. A. AMERICAN NATIONAL STANDARDS INSTITUTE (ANSI) 35. ALL CONNECTIONS TO GROUND RODS SHALL BE MADE WITH U.L. APPROVED V UNLESS NOTED OTHERWISE. THE CONTRACTOR SHALL FORM A GROUNDING B. ILLUMINATING ENGINEERS SOCIETY (IES) C. AMERICAN SOCIETY FOR TESTING AND MATERIALS (ASTM) AS PER NEC 250-50. . NATIONAL ELECTRICAL MANUFACTURER'S ASSOCIATES.(NEMA) 36. OUTLET IN DRY LOCATIONS BOXES SHALL BE PRESSED STEEL, IN WET OR DAM E. NOTE: THESE STANDARDS ARE SUBORDINATE TO CODES AND STANDARDS SET BY U.L. BE CAST ALLOY WEATHER-RESISTANT OUTLET WITH THREADED HUBS AND IN O ALL ELECTRICAL EQUIPMENT, DEVICES, WIRE, ETC., SHALL BE LISTED, FOR INTENDED USE, WITH AREAS IT SHALL BE IN A SPECIAL ENCLOSURE. PROPER PLASTER RINGS SHA UNDERWRITER'S LABORATORIES INC. (U.L.), WHERE STANDARDS HAVE BEEN ESTABLISHED BY U.L. OUTLET BOXES. PROPER COORDINATION BETWEEN ELECTRICAL SUBCONTRACTOR CONTRACTOR FOR PLASTER RING INITIATION WILL BE REQUIRED. NO "GOOF" CONTRACTOR TO PROVIDE ALL LABOR, MATERIALS AND SUPERVISION NECESSARY TO ACCOMPLISH ALLOWED. ALL OUTLET BOXES SHALL BE SECURELY FASTENED. THE WORK AS SHOWN AND/OR NOTED ON THE DRAWINGS. THE CONTRACTOR SHALL VISIT THE JOB SITE AND VERIFY ALL CONDITIONS, LOCATIONS,

WHEN ELECTRICAL BOXES ARE LOCATED IN VERTICAL FIRE RESISTIVE ASSEMBL FIRE/SMOKE AND SMOKE PARTITIONS). THEY SHALL BE INSTALLED WITHOUT DIMENSIONS AND COUNTS AS SHOWN OR NOTED ON THE DRAWINGS, PRIOR TO SUBMITTING BID. CLASSIFICATION. ALL OF THE FOLLOWING CONDITIONS SHALL BE MET: IT SHALL BE THE RESPONSIBILITY OF THE CONTRACTOR TO PROVIDE ALL LABOR. MATERIALS AND ALL ELECTRICAL BOXES SHALL BE METALLIC SUPERVISION NECESSARY TO ACCOMPLISH THE WORK AS SHOWN AND/OR NOTED ON THE PLANS.

B. BOX OPENING SHALL OCCUR ONLY ON ONE SIDE OF FRAMING SPACE. BOX OPENING SHALL NOT EXCEED 10322.56 SQUARE MM (16SQUARE IN D. ALL CLEARANCES BETWEEN OUTLET BOX AND GYPSUM BOARD SHALL BE WITH JOINT COMPOUND (OR OTHER APPROVED MATERIAL). E. PROVIDE A WALL AROUND OUTLETS LARGER THAT 10322.56 SQUARE MM THE INTEGRITY OF THE WALL RATING SHALL BE MAINTAINED. F. THE TOTAL AGGREGATE SURFACE AREA OF THE BOXES SHALL NOT EXCEED (100 SQUARE INCHES) PER 9.29 SQUARE METERS (100 SQUARE FEET)

G. OUTLET BOXES LOCATED ON OPPOSITE SIDES OF FIRE RESISTIVE ASSEMBLE SEPARATED BY A MINIMUM HORIZONTAL DISTANCE OF 609 6MM (24 INCHE H. OUTLET BOXES SHALL BE SECURELY FASTENED TO WALL FRAMING MEMBER I. THE OPENING IN THE GYPSUM BOARD FACING SHALL BE CUT NOT TO EXC INCH) BETWEEN THE EDGES OF THE OUTLET BOX AND THE EDGES OF THE SMOKE DETECTORS SHALL BE PROVIDED NO CLOSER THAN 36" FROM SUPPLY

CONTRACTOR SHALL PROVIDE A TYPE WRITTEN DIRECTORY OF EACH PANELBOA DIRECTORY IS NOT ACCEPTABLE, EXCEPT SPARE AND SPACES SHALL BE HAND 40. PROVIDE A 4" STEEL REINFORCED CONCRETE HOUSEKEEPING PAD UNDER ALL ELECTRICAL EQUIPMENT. 41. A. WORKING CLEARANCES FOR ELECTRICAL EQUIPMENT SHALL BE IN COMPLIA B. THE EXCLUSIVELY DEDICATED SPACE EXTENDING FROM FLOOR TO STRUCTUE

WIDTH AND DEPTH OF THE PANELBOARD OR SWITCHBOARD MUST BE CLEAR (EQUIPMENT FOREIGN TO THE ELECTRICAL EQUIPMENT OR ARCHITECTURAL ACCORDANCE WITH NEC 408. 42. METER CANS, HUBS, & LUGS FOR SAME ARE TO BE FURNISHED & INSTALLED

CONTRACTOR TO VERIFY SPECIFIC TYPE OF METER CAN TO BE USED WITH F.F 43. A. PROVIDE A PERMANENT SIGN ON THE MAIN ELECTRICAL ROOM DOOR TO TH THE SERVICE DISCONNECTS ARE LOCATED INSIDE. B. SIGNS SHALL BE PLACED AT THE MAIN DISCONNECT EQUIPMENT INDICATING

44. THE EQUIPMENT GROUNDING TERMINAL BARS OF THE NORMAL AND EMERGENC' SYSTEM PANELBOARDS SERVING THE SAME BUILDING SHALL BE BONDED TOGE INSULATED, CONTINUOUS, COPPER CONDUCTOR NOT SMALLER THAN NUMBER (THE ELECTRICAL CONTRACTOR SHALL FURNISH A COMPLETE SET OF AS-BUILT SHOWING ALL CHANGES AND DEVIATIONS TO THE ARCHITECT/ENGINEER PRIOR

LOCATION OF ON-SITE EMERGENCY POWER SOURCES.

THE PROJECT. 46. ARCHITECTURAL AND/OR ENGINEERING EXPENSES THAT ARE INCURRED DUE TO SUBSTITUTIONS REQUESTED BY THE CONTRACTOR SHALL BE PAID FOR BY THAT 47. FOR TELEPHONE SYSTEMS:

A. PROVIDE GROUNDING FOR ALL TELEPHONE OUTLETS AND EQUIPMENT PER R THE TELEPHONE COMPANY B. COORDINATE INSTALLATION OF ALL TELEPHONE OUTLETS, RACEWAYS, ENCLOSE BACKBOARDS WITH TELE CO. C. VERIFY LOCATION OF TELEPHONE SERVICE WITH TELEPHONE COMPANY. PR CONDUIT TO BLDG. FROM SERVICE POINT PER TELCO. INSTRUCTIONS, INCLUD COSTS IN BID. E. VERIFY LOCATION OF TELEPHONE SERVICE WITH TELEPHONE COMPANY PRIO BID. INCLUDE ALL ASSOCIATED COSTS IN BID F. USE EXTERIOR GRADE 3/4" PLYWOOD BACKBOARDS FOR MOUNTING TELEPH

AND TERMINAL STRIPS. PAINT BOARD ON ALL SIDES AND EDGES WITH TWO CC FIRE RETARDANT PAINT. 48. INDUSTRIAL CONTROL TYPE TRANSFORMERS SHALL BE PROVIDED WITH FINGERS PRIMARY FUSE PROTECTION AS REQUIRED PER NEC 450-3. MOUNT TRANSFOR

JUNCTION BOX ABOVE ACCESSIBLE CEILINGS OR ELECTRICAL ROOMS. DWELLING UNITS: ALL 120-VOLT SINGLE-PHASE, 15&20A, BRANCH CIRCUITS OR DEVICES INSTALLED IN DWELLING UNIT KITCHENS, FAMILY ROOMS, DINING I ROOMS, PARLORS, LIBRARIES, DENS, BEDROOMS, SUNROOMS, RECREATION ROO HALLWAYS, LAUNDRY AREAS, OR SIMILAR ROOMS OR AREAS SHALL BE PROTECT TECHNOLOGY IN ACCORDANCE WITH NEC 210.12(A) 1-6.

PROVIDE U.L. LISTED COMPOUND APPLIED TO BACK OF "BACK TO BACK" BOXE WHERE THE BOXES ARE LESS THAN 609.6MM (24 INCHES) APART MEASURED CONTRACTOR SHALL PROVIDE TYPED, UPDATED PANEL DIRECTORIES ON ALL PA AFFECTED AT THE COMPLETION OF THE JOB.

FOR RECEPTACLES IN DAMP AND WET LOCATIONS THE CONTRACTOR SHALL PR OV., 15A. AND 20A. RECEPTACLES THAT ARE LISTED AS WEATHER RESISTANT WITH NEC ARTICLE 406.8. 53. SERVICE EQUIPMENT IN OTHER THAN DWELLING UNITS SHALL BE LEGIBLY MARI WITH THE MAXIMUM AVAILABLE FAULT CURRENT, THE FIELD MARKING(S) SHALL

THE FAULT CURRENT CALCULATION WAS PERFORMED AND BE OF SUFFICIENT D WITHSTAND THE ENVIRONMENT INVOLVED. 54. VOLTAGE DROP 1. CONDUCTORS FOR ALL FEEDERS SHALL BE INCREASED FROM SIZES INDICAT PREVENT VOLTAGE DROP EXCEEDING 2%. 2. CONDUCTORS FOR ALL BRANCH CIRCUITS SHALL BE INCREASED FROM SIZE

DRAWINGS TO PREVENT VOLTAGE DROP EXCEEDING 3%. FROM THE FURTHES 3. DETERMINING CONDUCTOR SIZES SHALL BE BASED ON 80% OF THE BREAKI 4. FOR DETERMINATION OF WIRE SIZE FOR BID PURPOSES: * INCREASE WIRE BY 1 WIRE SIZE FOR RUNS 60 FT. TO 100 FT.

* INCREASE WIRE BY 2 WIRE SIZES FOR RUNS 100 FT. TO 150 FT.

* INCREASE WIRE BY 3 WIRE SIZES FOR RUNS FROM 150 FT. TO 230 FT. **GENERAL LIGHTING NOTES:**

	SYMBOL
NELS.	A
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IING SYSTEM AS PER CONDITIONING CORING AND CONTROL T MOUNTING LOCATIONS.	H⊗ 1
EATHER. ALL FLEX HE ENVIRONMENT IN	
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MP LOCATIONS SHALL	
OTHER CLASSIFIED ALL BE USED WITH OR AND GENERAL	
RINGS SHALL BE JES, (CLASSIFIED AS	
AFFECTING THE FIRE	\$ \$
NCHES). COMPLETELY FILLED	\$3
(16 SQUARE INCHES).	\$ _B \$ _k
D 64516 SQUARE MM LIES SHALL BE 'S).	\$ _F
RS. DEED 3.175MM (1/8 E OPENING.	\$P \$ex
ARD. HAND WRITTEN OWRITTEN IN PENCIL.	\$s \$m \$d
FLOOR MOUNTED ANCE WITH NEC 110.26	\$30
RAL CEILING WITH A OF ALL PIPING, DUCTS, APPURTENANCES IN	\$.
BY CONTRACTOR. P.L. PRIOR TO BID.	♥a,b
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ES IN RATED WALLS HORIZONTALLY. ANELS THAT ARE	\bigoplus_{Ewc}
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RKED IN THE FIELD . INCLUDE THE DATE DURABILITY TO	 ⊕
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ES INDICATED ON ST DEVICE. ER	#
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	√ 5 <i>Y</i>
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NUMBERS. FILES OF THE USB DRIVE 10	2100

ELECTRICAL SYMBOL LEGEND

LIGHT FIXTURE DESIGNATION.

LIGHTING FIXTURE, SURFACE MOUNTED

EXIT LIGHT FIXTURE. DIRECTION ARROWS AS SHOWN

(SHADED QUADRANT INDICATES FACE(S) OF FIXTURE)

BRANCH CIRCUIT OR, W/EMERG. 90 MIN. BATTERY PACK.

BRANCH CIRCUIT OR, W/EMERG. 90 MIN. BATTERY PACK.

BRANCH CIRCUIT OR, W/EMERG. 90 MIN. BATTERY PACK.

EMERGENCY BATTERY WALL PACK WITH TWIN HEADS

TOGGLE SWITCH 120/277V. 20 AMP., (M.H. = 48" A.F.F.)

FAN SWITCH 120/277V. 20 AMP, (HORSEPOWER RATED)

30-MINUTE ROTATABLE TIMER SWITCH (M.H. = 48" A.F.F.)

TOGGLE SWITCH 120/277V. 20 AMP., WITH PILOT LIGHT,

TOGGLE SWITCH 120/277V. 20 AMP. EXPLOSION-PROOF,

SINGLE PHASE MANUAL MOTOR STARTER, (M.H.=48" A.F.F.)

SPEED SWITCH 120/277V. 20 AMP. U.O.N. ,(M.H. = 48" A.F.F.)

SINGLE POLE SWITCH (48" A.F.F.) (SUBSCRIPT INDICATES ITEM

(a, b) OR (2) INDICATES TWO POLE SWITCH - WSD-PDT-2P

DIMMER SWITCH 120/277V. 20 AMP., (M.H.=48" A.F.F.) (1500 WATTS

WALL MOUNTED - OCCUPANCY SENSOR SWITCH, (M.H.=48"A.F.F.) MFGR./MODEL#

CEILING MOUNTED OCCUPANCY SENSOR - LIGHTING CIRCUIT CONTROLLER.

SENSOR - LIGHTING CIRCUIT CONTROLLER. SENSOR SWITCH/#CM-PDT-10.

CONTRACTOR SHALL PROVIDE ALL SWITCHPACKS AND CONDUCTORS AS

IT IS THE SOLE RESPONSIBILITY OF THE CONTRACTOR TO PROVIDE

AND INSTALL A COMPLETE AND FULLY FUNCTIONAL LIGHTING CONTROL

SYSTEM IN ACCORDANCE WITH THE PLANS, DETAILS, INTENT OF THE

CEILING MOUNTED DUAL TECHNOLOGY EXTENDED RANGE OCCUPANCY

WALL MOUNTED - OCCUPANCY SENSOR (M.H.=96"A.F.F.)

REQUIRED FOR LAYOUTS AND CONTROLS SHOWN ON PLANS.

DESIGN AND SPECIFICATIONS SHOWN ON THESE PLANS.

EXTERIOR LIGHT FIXTURE WITH ARMS AS SHOWN ON DRAWINGS

LUORESCENT WALL MOUNTED FIXTURE WITH WALL OUTLET BOX

LIGHTING FIXTURE, WALL MOUNTED

WALL MOUNTED EXIT LIGHT FIXTURE

2 X 2 FLUORESCENT LIGHT FIXTURE

2 X 4 FLUORESCENT LIGHT FIXTURE

1 X 4 FLUORESCENT LIGHT FIXTURE

LUORESCENT STRIP FIXTURE

(M.H.=48"A.F.F.)

(M.H.=48"A.F.F.)

CONTROLLED)

UNLESS OTHERWISE INDICATED)

SENSOR SWITCH/#WSD-PDT

MFGR./MODEL#WV-PDT

POWER PACK

THREE-WAY DIMMER SWITCH (48" A.F.F.)

PANIC SWITCH, MUSHROOM TYPE, (M.H.=48" A.F.F.)

LV INDICATES LOW VOLTAGE - WSD-PDT-LV

MFGR./MODEL# (SENSOR SWITCH/#CM-PDT)

DESCRIPTION

LIGHTING FIXTURE (HID, FLUORESCENT OR INCANDESCENT), RECESSED MTD.

DIAGONAL SHADING DENOTES LIGHT FIXTURE CONNECTED TO EMERGENCY

DIAGONAL SHADING DENOTES LIGHT FIXTURE CONNECTED TO EMERGENCY

DIAGONAL SHADING DENOTES LIGHT FIXTURE CONNECTED TO EMERGENCY

TOGGLE SWITCH 120/277V. 20 AMP. ,(M.H. = 48" A.F.F.) , 3-WAY

TOGGLE SWITCH 120/277V. 20 AMP., (M.H. = 48" A.F.F.), 4-WAY

TOGGLE SWITCH 120/277V. 20 AMP. KEYSWITCH, (M.H. = 48" A.F.F.)

LIGHTING CONTROL BY-PASS SWITCH, (MAX. 2 HOUR OVER-RIDE).

(REFER TO LIGHTING FIXTURE SCHEDULE)

SYMBOL

Φ	BASIC MATERIALS DUPLEX RECEPTACLE, 20 AMP., 125V., (M.H.=18"A.F.F.) FLOOR OUTLET BOX AND DUPLEX RECEPTACLE 20 AMP., 125V., WITH		110 CD	A M W	OMBINATION AUDIBLE/VIS LARM HORN (SPEAKER)/ ITD.) MOUNT AT 80" A.F (HICHEVER IS LOWER. (P DENOTES WEATHERPRO	/ FLASHING S .F. OR 6" BE	STROBE LIGHT (WALL ELOW CEILING
	APPROPRIATE FLANGE. CEILING OUTLET BOX AND DUPLEX RECEPTACLE 20A, 125V.),	(15/75 (ISUAL SIGNALING UNIT - BO" TO BOTTOM) (NO A	UDIO DEVICE)	
•	DUPLEX RECEPTACLE, 20 AMP., 125V., TOP HALF SWITCHED, M.H. = 18" A.F.F. UNLESS OTHERWISE NOTED	Ш	(S) ^b	Ε	HOTO-ELECTRIC SMOKE = ELEVATOR = IONIZATION	DETECTOR	
•	DUPLEX RECEPTACLE, 20 AMP., 125V., ISOLATED GROUND AND SURGE PROTECTED, (M.H.=18"A.F.F.)	Ш	3	DD R	UCT MOUNTED SMOKE DEMOTE TEST AND HEAVY = RETURN		
φ	SINGLE RECEPTACLE, 20 AMP., 125V., COORDINATE M.H. WITH EQUIPMENT.		\mathbb{S}_{R}	Т	= SUPPLY YPICAL 120V. RESIDENTI, OUNDER BASE AND BAT		
$\Phi_{\sf EWC}$	SIMPLEX RECEPTACLE (16" A.F.F.) (EWC DENOTES ELECTRIC WATER COOLER. COORDINATE WITH EWC INSTALLER FOR MOUNTING HEIGHT)		So	M T	YPICAL 120V. RESIDENTI. ETECTOR/CARBON MONC	AL TYPE COM	IBO SMOKE
 	TWO DUPLEX RECEPTACLES WITH COMMON COVER 20A., 125V.,(18" A.F.F.)	Ш	S		ND BATTERY BACK-UP. RE ALARM SPEAKER (WA	LL OR CEILING	G MOUNTED)
•	TWO DUPLEX RECEPTACLES WITH COMMON COVER 20A., 125V.,(42" A.F.F.)			∇_{F} F	TREFIGHTER'S PHONE JAC	cK .	
→ "	DUPLEX RECEPTACLE, 20 AMP., 125V., MOUNT ABOVE COUNTER @42"AFF.		Ū _{R/F}		EAT DETECTOR, FIXED T THERWISE INDICATED	EMPERATURE	(135°) UNLESS
>	SPECIAL PURPOSE OUTLET e.g. RANGE OUTLET, COORD. W/ EQUIPT.	Ш	\rightarrow \lambda		TRE ALARM FLOW SWITCH CONTRACTOR)	H (FURNISHE	D BY SPRINKLER
' Ш	GFCI DUPLEX RECEPTACLE, 20 AMP., 125V., (M.H.=18"A.F.F.)	Ш		Ĭ F	FIRE ALARM TAMPER SWI	TCH (FURNIS	HED BY SPRINKLER
" #	GFCI DUPLEX RECEPTACLE, 20 AMP., 125V., MTD. ABOVE COUNTER (VERIFY		MD		MOTION SENSOR - CEILIN	IG MOUNTED	
	HEIGHT) 30 AMP., 125V., TWIST LOCK RECEPTACLE FOR FLOOR POLISHING MACHINE	Ш	M FAC		MONITOR MODULE FIRE ALARM CONTROL PAI	NEL – ADDRE	SSABLE
<u> </u>	JUNCTION BOX, MOUNTING AS SHOWN		RAP	F	FIRE ALARM REMOTE ANN	UNCIATOR PAI	NEL - FLUSH MOUNTED
	POWER POLE	Ш	FATC	F	FIRE ALARM TERMINAL CA	BINET	
(5)	ELECTRIC MOTOR, NUMBER INDICATES HORSEPOWER	\perp	-E	WL F	TREFIGHTER'S ELEVATOR	WARNING LIGH	I T
	MAGNETIC MOTOR STARTER OR CONTACTOR,	NO	OTE: SOME	SYMBO	DLS SHOWN ON THIS LEG	END MAY NO	T PERTAIN TO THIS PROJEC
	COMBINATION MAGNETIC MOTOR STARTER, SIZE AS NOTED	ΙГ			ABBREVIA	ATIONS	
	DISCONNECT SWITCH, SIZE AS NOTED # OF BOLES ENCLOSURE TYPE:	۱⊢			, (55)(21)	1	
	AMP RATING/FRAME NEMA 3R— FOR EXTERIOR	A.			COUNTER	EX	EXISTING
, , , , , , , , , , , , , , , , , , ,	NEMA 1— FOR INTERIOR	Ш	A.F.	ARC FA		ER	EXISTING RELOCATED
3 <u>100</u> ′	\ <u></u>			A DOVE	FINICUED FLOOD	G.F.L	GROUND FAULT INTERRUPTER
3100′	FUSE SIZE (* DENOTES AS PER MANUFACTURER)				FINISHED FLOOR SHOW WINDOW ROPT	G.F.I.	GROUND FAULT INTERRUPTER
	FUSE SIZE (* DENOTES AS PER MANUFACTURER) LIGHTING CONTROL TIME CLOCK	A.S	S.W.	ABOVE	SHOW WINDOW RCPT.	G.F.I. L.C. M.H.	GROUND FAULT INTERRUPTER LOCKABLE COVER MOUNTING HEIGHT
	FUSE SIZE (* DENOTES AS PER MANUFACTURER)	A.S	S.W. B.F.C.	ABOVE BELOW		L.C.	LOCKABLE COVER
	FUSE SIZE (* DENOTES AS PER MANUFACTURER) LIGHTING CONTROL TIME CLOCK PHOTOCELL, MOUNTED ON ROOF FACING NORTH SHUNT-TRIP BUTTON - FLUSH MOUNTED UNLESS OTHERWISE NOTED	A.S	S.W. B.F.C. B.F.G.	ABOVE BELOW BELOW	SHOW WINDOW RCPT. FINISHED CEILING	L.C. M.H.	LOCKABLE COVER MOUNTING HEIGHT
	FUSE SIZE (* DENOTES AS PER MANUFACTURER) LIGHTING CONTROL TIME CLOCK PHOTOCELL, MOUNTED ON ROOF FACING NORTH		S.W. B.F.C. B.F.G. B. CL	ABOVE BELOW BELOW CIRCUIT	SHOW WINDOW RCPT. FINISHED CEILING FINISHED GRADE BREAKER LINE	L.C. M.H. N N.F. NL	LOCKABLE COVER MOUNTING HEIGHT NEW DEVICE NON FUSED NIGHT LIGHT
	FUSE SIZE (* DENOTES AS PER MANUFACTURER) LIGHTING CONTROL TIME CLOCK PHOTOCELL, MOUNTED ON ROOF FACING NORTH SHUNT-TRIP BUTTON - FLUSH MOUNTED UNLESS OTHERWISE NOTED		S.W. B.F.C. B.F.G. B. CL D	ABOVE BELOW CIRCUIT CENTER DEDICA PROVID	SHOW WINDOW RCPT. FINISHED CEILING FINISHED GRADE BREAKER LINE TED FOR COMPUTER, E DEDICATED GROUND	L.C. M.H. N N.F. NL RE	LOCKABLE COVER MOUNTING HEIGHT NEW DEVICE NON FUSED NIGHT LIGHT EXISTING TO BE REMOVED
	FUSE SIZE (* DENOTES AS PER MANUFACTURER) LIGHTING CONTROL TIME CLOCK PHOTOCELL, MOUNTED ON ROOF FACING NORTH SHUNT—TRIP BUTTON — FLUSH MOUNTED UNLESS OTHERWISE NOTED PLUG—IN STRIP WITH RECEPTACLES, 18" O.C. UNLESS OTHERWISE INDICATED CABLE TRAY GROUND OR GROUND ROD AS NOTED	C.E	S.W. B.F.C. B.F.G. B. CL D	ABOVE BELOW BELOW CIRCUIT CENTER DEDICA PROVID AND N	SHOW WINDOW RCPT. FINISHED CEILING FINISHED GRADE BREAKER LINE TED FOR COMPUTER, E DEDICATED GROUND EUTRAL	L.C. M.H. N N.F. NL RE T.C.	LOCKABLE COVER MOUNTING HEIGHT NEW DEVICE NON FUSED NIGHT LIGHT EXISTING TO BE REMOVED TERMINAL CABINET
	FUSE SIZE (* DENOTES AS PER MANUFACTURER) LIGHTING CONTROL TIME CLOCK PHOTOCELL, MOUNTED ON ROOF FACING NORTH SHUNT—TRIP BUTTON — FLUSH MOUNTED UNLESS OTHERWISE NOTED PLUG—IN STRIP WITH RECEPTACLES, 18" O.C. UNLESS OTHERWISE INDICATED CABLE TRAY GROUND OR GROUND ROD AS NOTED CONDUIT TURNING UP		S.W. B.F.C. B.F.G. B. CL D	ABOVE BELOW BELOW CIRCUIT CENTER DEDICA PROVID AND N	SHOW WINDOW RCPT. FINISHED CEILING FINISHED GRADE BREAKER LINE TED FOR COMPUTER, E DEDICATED GROUND EUTRAL ED GROUND (ORANGE	L.C. M.H. N N.F. NL RE T.C. T.S.	LOCKABLE COVER MOUNTING HEIGHT NEW DEVICE NON FUSED NIGHT LIGHT EXISTING TO BE REMOVED TERMINAL CABINET TIME SWITCH
	FUSE SIZE (* DENOTES AS PER MANUFACTURER) LIGHTING CONTROL TIME CLOCK PHOTOCELL, MOUNTED ON ROOF FACING NORTH SHUNT—TRIP BUTTON — FLUSH MOUNTED UNLESS OTHERWISE NOTED PLUG—IN STRIP WITH RECEPTACLES, 18" O.C. UNLESS OTHERWISE INDICATED CABLE TRAY GROUND OR GROUND ROD AS NOTED CONDUIT TURNING UP CONDUIT TURNING DOWN	C.E	S.W. B.F.C. B.F.G. B. CL D	ABOVE BELOW BELOW CIRCUIT CENTER DEDICA PROVID AND N ISOLATI DEVICE PROVID	SHOW WINDOW RCPT. FINISHED CEILING FINISHED GRADE BREAKER LINE TED FOR COMPUTER, E DEDICATED GROUND EUTRAL ED GROUND (ORANGE) E EMERGENCY	L.C. M.H. N N.F. NL RE T.C. T.S. U.O.N.	LOCKABLE COVER MOUNTING HEIGHT NEW DEVICE NON FUSED NIGHT LIGHT EXISTING TO BE REMOVED TERMINAL CABINET TIME SWITCH UNLESS OTHERWISE NOTEI
	FUSE SIZE (* DENOTES AS PER MANUFACTURER) LIGHTING CONTROL TIME CLOCK PHOTOCELL, MOUNTED ON ROOF FACING NORTH SHUNT—TRIP BUTTON — FLUSH MOUNTED UNLESS OTHERWISE NOTED PLUG—IN STRIP WITH RECEPTACLES, 18" O.C. UNLESS OTHERWISE INDICATED CABLE TRAY GROUND OR GROUND ROD AS NOTED CONDUIT TURNING UP CONDUIT TURNING DOWN CONDUIT STUB	C.E	S.W. B.F.C. B.F.G. B. CL D	ABOVE BELOW BELOW CIRCUIT CENTER DEDICA PROVID AND N ISOLATI DEVICE PROVID BATTER CONNE	SHOW WINDOW RCPT. FINISHED CEILING FINISHED GRADE BREAKER LINE TED FOR COMPUTER, E DEDICATED GROUND EUTRAL ED GROUND (ORANGE) CE EMERGENCY Y PACK W/FIXTURE, CT AHEAD OF ALL	L.C. M.H. N N.F. NL RE T.C. T.S. U.O.N.	LOCKABLE COVER MOUNTING HEIGHT NEW DEVICE NON FUSED NIGHT LIGHT EXISTING TO BE REMOVED TERMINAL CABINET TIME SWITCH UNLESS OTHERWISE NOTED WEATHER PROOF ENCLOSUR
	FUSE SIZE (* DENOTES AS PER MANUFACTURER) LIGHTING CONTROL TIME CLOCK PHOTOCELL, MOUNTED ON ROOF FACING NORTH SHUNT—TRIP BUTTON — FLUSH MOUNTED UNLESS OTHERWISE NOTED PLUG—IN STRIP WITH RECEPTACLES, 18" O.C. UNLESS OTHERWISE INDICATED CABLE TRAY GROUND OR GROUND ROD AS NOTED CONDUIT TURNING UP CONDUIT TURNING DOWN	C.E	S.W. B.F.C. B.F.G. B. CL D	ABOVE BELOW BELOW CIRCUIT CENTER DEDICA PROVID AND N ISOLATI DEVICE PROVID BATTER	SHOW WINDOW RCPT. FINISHED CEILING FINISHED GRADE BREAKER LINE TED FOR COMPUTER, E DEDICATED GROUND EUTRAL ED GROUND (ORANGE) CE EMERGENCY Y PACK W/FIXTURE, CT AHEAD OF ALL	L.C. M.H. N N.F. NL RE T.C. T.S. U.O.N.	LOCKABLE COVER MOUNTING HEIGHT NEW DEVICE NON FUSED NIGHT LIGHT EXISTING TO BE REMOVED TERMINAL CABINET TIME SWITCH UNLESS OTHERWISE NOTED
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	LIGHTING CONTROL TIME CLOCK PHOTOCELL, MOUNTED ON ROOF FACING NORTH SHUNT—TRIP BUTTON — FLUSH MOUNTED UNLESS OTHERWISE NOTED PLUG—IN STRIP WITH RECEPTACLES, 18" O.C. UNLESS OTHERWISE INDICATED CABLE TRAY GROUND OR GROUND ROD AS NOTED CONDUIT TURNING UP CONDUIT TURNING DOWN CONDUIT STUB CONDUIT CONTINUED	C.E	S.W. B.F.C. B.F.G. B. CL D	ABOVE BELOW BELOW CIRCUIT CENTER DEDICA PROVID AND N ISOLATI DEVICE PROVID BATTER CONNE	SHOW WINDOW RCPT. FINISHED CEILING FINISHED GRADE BREAKER LINE TED FOR COMPUTER, E DEDICATED GROUND EUTRAL ED GROUND (ORANGE) CE EMERGENCY Y PACK W/FIXTURE, CT AHEAD OF ALL	L.C. M.H. N N.F. NL RE T.C. T.S. U.O.N.	LOCKABLE COVER MOUNTING HEIGHT NEW DEVICE NON FUSED NIGHT LIGHT EXISTING TO BE REMOVED TERMINAL CABINET TIME SWITCH UNLESS OTHERWISE NOTED WEATHER PROOF ENCLOSUR TRANSFORMER.
NOTE: SOME S TO THE BEST COMPLY WITH STANDARDS AS	LIGHTING CONTROL TIME CLOCK PHOTOCELL, MOUNTED ON ROOF FACING NORTH SHUNT—TRIP BUTTON — FLUSH MOUNTED UNLESS OTHERWISE NOTED PLUG—IN STRIP WITH RECEPTACLES, 18" O.C. UNLESS OTHERWISE INDICATED CABLE TRAY GROUND OR GROUND ROD AS NOTED CONDUIT TURNING UP CONDUIT TURNING DOWN CONDUIT STUB CONDUIT CONTINUED	C.E	S.W. B.F.C. B.F.G. B. CL D	ABOVE BELOW BELOW CIRCUIT CENTER DEDICA PROVID AND N ISOLATI DEVICE PROVID BATTER CONNE SWITCH	SHOW WINDOW RCPT. FINISHED CEILING FINISHED GRADE BREAKER LINE TED FOR COMPUTER, E DEDICATED GROUND EUTRAL ED GROUND (ORANGE) E EMERGENCY Y PACK W/FIXTURE, CT AHEAD OF ALL ES.	L.C. M.H. N N.F. NL RE T.C. T.S. U.O.N. WP. XFMR.	LOCKABLE COVER MOUNTING HEIGHT NEW DEVICE NON FUSED NIGHT LIGHT EXISTING TO BE REMOVED TERMINAL CABINET TIME SWITCH UNLESS OTHERWISE NOTED WEATHER PROOF ENCLOSUR TRANSFORMER.
NOTE: SOME S TO THE BEST COMPLY WITH STANDARDS AS	FUSE SIZE (* DENOTES AS PER MANUFACTURER) LIGHTING CONTROL TIME CLOCK PHOTOCELL, MOUNTED ON ROOF FACING NORTH SHUNT—TRIP BUTTON — FLUSH MOUNTED UNLESS OTHERWISE NOTED PLUG—IN STRIP WITH RECEPTACLES, 18" O.C. UNLESS OTHERWISE INDICATED CABLE TRAY GROUND OR GROUND ROD AS NOTED CONDUIT TURNING UP CONDUIT TURNING DOWN CONDUIT STUB CONDUIT CONTINUED SYMBOLS SHOWN ON THIS LEGEND MAY NOT PERTAIN TO THIS PROJECT. OF THE ENGINEER'S KNOWLEDGE, THE PLANS AND SPECIFICATIONS THE APPLICABLE MINIMUM BLDG. CODES AND APPLICABLE FIRE—SAFETY TO DETERMINED BY THE LOCAL AUTHORITY IN ACCORDANCE WITH SECTION	C.E	S.W. B.F.C. B.F.G. B. CL D	ABOVE BELOW BELOW CIRCUIT CENTER DEDICA PROVID AND N ISOLATI DEVICE PROVID BATTER CONNE SWITCH	SHOW WINDOW RCPT. FINISHED CEILING FINISHED GRADE BREAKER LINE TED FOR COMPUTER, E DEDICATED GROUND EUTRAL ED GROUND (ORANGE) E EMERGENCY Y PACK W/FIXTURE, CT AHEAD OF ALL ES.	L.C. M.H. N N.F. NL RE T.C. T.S. U.O.N. WP. XFMR.	LOCKABLE COVER MOUNTING HEIGHT NEW DEVICE NON FUSED NIGHT LIGHT EXISTING TO BE REMOVED TERMINAL CABINET TIME SWITCH UNLESS OTHERWISE NOTED WEATHER PROOF ENCLOSUR TRANSFORMER. DETAIL SHEET NUMBER
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SYSTEMS SYMBOL LEGEND

CALL BACK PUSH BUTTON

SECURITY SYSTEM KEYPAD

AIR HANDLING UNIT SHUT-DOWN RELAY

POWER ON INDICATOR WITH KEYED RESET

ERVICE AND DISTRIBUTION

(SEE PANEL SCHEDULE FOR DETAILS)

TRANSFORMER, SIZE AS NOTED

AUTOMATIC TRANSFER SWITCH

INTERCOM SYSTEM SPEAKER

C = ABOVE THE COUNTER

CONNECTION, SEE SPECS.

SECURITY SYSTEM KNOX BOX

P = PUBLIC PAY (48" A.F.F.)

W = WALL MOUNTED (18" A.F.F.)

DATA/TELEPHONE PORT - CEILING MOUNTED

DATA/TELEPHONE PORT - FLOOR MOUNTED

JACKS IN SINGLE-GANG BOX. (18" A.F.F.)

SECURITY SYSTEM CARD READER, SEE SPECS.

RE ALARM/DETECTION SYSTEM

FIRE ALARM MANUAL PULL STATION 48" A.F.F.

SECURITY SYSTEM CABLES IN CONDUIT, SEE SPECS.

EXISTING EQUIPMENT TO REMAIN

CLOCK

DESCRIPTION

ELECTRICAL BRANCH CIRCUIT PANELBOARD, RECESS MOUNTED.

ELECTRICAL BRANCH CIRCUIT PANELBOARD, SURFACE

PHONE/COMPUTER RACEWAY SYSTEM

COMPUTER/TELEPHONE OUTLET WITH (2) 8-CONDUCTOR

RJ-45 JACKS IN A SINGLE-GANG BOX MOUNTED AT 18"

TELEVISION SIGNAL WALL OUTLET (M.H. = 18" A.F.F.) WITH

B-CONDUCTOR RJ-45 JACK AND F-TYPE RG6 COAX JACK IN

TELEVISION SIGNAL WALL OUTLET F-TYPE RG6 COAX JACK &

COMPUTER/TELEPHONE OUTLET (2) 8-CONDUCTOR RJ-45

SECURITY SYSTEM CAMERA, PROVIDE POWER AND SIGNAL

SECURITY SYSTEM MONITORS AND RECORDERS, SEE SPECS.

SECURITY SYSTEM JUNCTION BOX AT ACCESSIBLE LOCATION.

SECURITY SYSTEM HIDDEN PUSH BUTTON FOR DOOR STRIKE

RELEASE, COORDINATE INSTALLATION WITH FURNITURE OR

SECURITY SYSTEM SPEAKER WITH INTEGRAL MICROPHONE

COMBINATION AUDIBLE/VISUAL SIGNALING UNIT - FIRE

MOUNTED. (SEE PANEL SCHEDULE FOR DETAILS)

NEW EQUIPMENT OR WORK OF THIS PROJECT

TELEPHONE/COMPUTER TERMINAL BOARD "TTB"

CIRCUIT BREAKER, TYPE AND SIZE AS PER DRAWINGS.

SYMBOL

		ELECTRICAL INDEX		
		DRAWING	\triangle	Γ
1	E-1.00	INDEX, SYMBOL LEGEND AND NOTES		
2	E-2.00	PROPOSED SITE PLAN - ELECTRICAL		
3	E-3.00	PROPOSED SITE PLAN - PHOTOMETRICS		
4	E-4.00	ELECTRICAL DETAILS		
5	E-	-		
6	E-	-		

SHOP DRAWING REQUIREMENTS

CONTRACTOR SHALL SUBMIT 6 COPIES OF COMPLETED SHOP DRAWINGS, TOGETHER AT ONE TIME AND MUST COME THROUGH THE ARCHITECT. ALL SUBMITTALS SHALL BE MADE WITHIN 30 DAYS OF NOTICE TO PROCEED

SUBSTITUTIONS SHALL BE LIMITED TO ONE OF THE ALTERNATES LISTED IN THE CONSTRUCTION

ALL SUBMITTALS MUST CLEARLY INDICATE EXACTLY WHICH ITEMS ARE BEING PROPOSED FOR USE. IF NOT, THE SUBMITTAL SHALL BE REJECTED.

DOCUMENTS. PRODUCTS CONSIDERED TO BE EQUAL SHALL BE REVIEWED AND ACCEPTED BY THE ENGINEER, ARCHITECT AND OWNER (10) DAYS PRIOR TO BID DATE. THE CONTRACTOR ASSUMES ALL DESIGN RESPONSIBILITY AND ALL FINANCIAL RISKS FOR PROCEEDING PRIOR TO SHOP DRAWINGS PROCESSING, AND ON ANY ITEM OR WORK THAT IS

AT VARIANCE TO THE CONSTRUCTION DOCUMENTS. SHOP DRAWINGS AND SUBMITTALS FOR EACH ITEM SHALL BE REVIEWED NO MORE THAN

TWICE. A THIRD SUBMITTAL ON AN ITEM MUST BE ACCOMPANIED BY A PURCHASE ORDER FROM THE CONTRACTOR OR IT SHALL BE REJECTED. CIRCUMSTANCES NECESSITATING A REVISION TO THE PERMITTED DOCUMENTS NOT

PROCESSED PRIOR TO INSTALLATION MAY NOT BE ACCEPTED. IF ACCEPTED IT MUST BE LEGIBLE, ACCURATE AND ACCOMPANIED BY A PURCHASE ORDER ORDER FROM THE CONTRACTOR. THE REVISION SHALL BE CHARGED TO THE CONTRACTOR AND DELIVERED TO HIM ON A C.O.D. BASIS. SUBSTITUTIONS FROM THE BASE DESIGN OR VARIATIONS TO THE PERMITTED CONTRACT DOCUMENTS, WHETHER RESULTING FROM PROCESSED SHOP DRAWINGS OR NOT, THAT RESULT

IN REQUIREMENTS IN LETTERS OF AUTHORIZATION AND/OR PERMIT CONTRACT DOCUMENT CHANGES MANDATED BY THE AUTHORITY HAVING JURISDICTION WILL NOT BE MADE BY THIS OFFICE UNLESS ACCOMPANIED BY A PURCHASE ORDER FROM THE CONTRACTOR, AND RELEASED ON A C.O.D. BASIS.

CONTRACTOR SHALL SUBMIT 5 COPIES OF EQUIPMENT LAYOUTS OF ALL ELECTRICAL SPACES, ROOMS, ETC. TO THE ENGINEER FOR APPROVAL PRIOR TO ORDERING EQUIPMENT OR INSTALLING CONDUITS, ETC. THE LAYOUTS SHALL CONSIST OF PLAN VIEWS AT A SCALE OF 1/2" = 1'0" AND ELEVATIONS FOR EACH SUCH SPACE OR ROOM, ETC.

George George Sanjuan approving this Sanjua document Location: Fort Lauderdale, Fl Date: 2020.06.05 10:05:26 -04'00'

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GEORGE SANJUAN, P.E. FLORIDA LICENSE #46100



ARCHITECTS 5813 N. ANDREWS WAY, FORT LAUDERDALE, FL 33309

> PHONE: (954) 522-4123 FAX: (954) 522-4128

www.wza-architects.com Abbas H. Zackria, FL AR 91520

CORPORATE NAME: WALTERS ZACKRIA ASSOCIATES, PLLC REGISTERED IN THE DIMENSIONS TAKE PRECEDENCE OVER SCALED DIMENSIONS. THESE DRAWINGS ARE THE PROPERTY OF WALTERS ZACKRIA ASSOCIATES, PLLC, AND SHA NOT BE REPRODUCED WITHOUT WRITTEN PERMISSION FROM A PRINCIPAL OF TH FIRM OR BE LIABLE FOR THE FULLEST LEGAL RECOURSE. CONTRACTOR SHAL VERIFY ALL EXISTING CONDITIONS AND ARCHITECT OF ANY DISCREPANCIES PRIOR TO EXECUTION OF WORK.

DRAWN BY: CHECKED BY: 06/05/2020

REVISIONS:

INDEX, SYMBOL LEGEND AND NOTES

- CONTRACTOR SHALL COMPLY WITH 2014 FBC SECTION R404.1. MINIMUM OF 75% OF THE PERMANENTLY INSTALLED LIGHTING FIXTURES SHALL BE HIGH-EFFICIENCY LAMPS.
- REFER TO ARCHITECTURAL REFLECTED CEILING PLAN FOR EXACT LOCATION OF LIGHT FIXTURES 3. COORDINATE TYPE OF CEILING FOR EACH FIXTURE WITH ARCHITECTURAL REFLECTED CEILING

10,000 HOUR LIFE, ELECTRONIC BALLAST, UNLESS OTHERWISE NOTED.

ELECTRICAL CONTRACTOR SHALL NOT SCALE DRAWINGS. CONTRACTOR SHALL REFER TO

IT SHALL BE UNDERSTOOD THAT ALL WORK PERFORMED SHALL BE DONE BY A LICENSED

ALL REQUIREMENTS SET FORTH BY ANY LOCAL ORDINANCE AND GOVERNING AUTHORITIES.

LIABILITY AND PROPERTY DAMAGE FOR THE DURATION OF THE WORK.

FOR EQUIPMENT TO BE PLACED IN PROPER WORKING ORDER

AND REMOVE SAME AT COMPLETION OF PROJECT.

APPROVED SHOP DRAWINGS ARE RETURNED TO HIM.

ALUMINUM CONDUCTORS ARE NOT PERMITTED.

SHALL BE SCHEDULE 40 PVC

THE CONDUIT AS SPECIFIED.

NO TIE HANDLES PERMITTED.

FIELD, UNLESS OTHERWISE NOTED.

WHICH MAY HAVE BEEN DAMAGED THEREBY.

NOTED OTHERWISE.

ARCHITECTURAL PLANS AND ELEVATIONS FOR EXACT LOCATIONS OF ALL EQUIPMENT UNLESS

CONTRACTOR AND IN A FIRST-CLASS WORKMANLIKE MANNER. SAID CONTRACTOR SHALL MEET

THE CONTRACTOR SHALL PROVIDE ALL REQUIRED INSURANCE FOR PROTECTION AGAINST PUBLIC

PERIOD OF NOT LESS THAN ONE YEAR FROM DATE OF ACCEPTANCE, UNLESS INDICATED OR

CONTRACTOR SHALL GUARANTEE ALL MATERIALS AND WORKMANSHIP FREE FROM DEFECTS FOR A

IT SHALL NOT BE THE INTENT OF THESE PLANS AND/OR SPECIFICATIONS TO SHOW EVERY MINOR

DETAIL OF CONSTRUCTION. THE CONTRACTOR SHALL BE EXPECTED TO FURNISH AND INSTALL ALL

ITEMS FOR A COMPLETE ELECTRICAL SYSTEM AND PROVIDE FOR ALL REQUIREMENTS NECESSARY

ALL DAMAGES TO BUILDING SURFACES, EQUIPMENT, ETC. CAUSED DURING THE PERFORMANCE OF

SUBMITTING BID. CONTRACTOR TO VERIFY AVAILABLE SERVICE VOLTAGE AND PHASES WITH

B. PROVIDE TEMPORARY ELECTRICAL SERVICE FOR USE BY ALL TRADES DURING CONSTRUCTION

CONTRACTOR SHALL KEEP ALL AREAS IN WHICH WORK IS BEING PERFORMED. FREE FROM DEBRIS

AT ALL TIMES AND SAID AREAS SHALL BE LEFT BROOM CLEAN AT THE END OF EACH WORKING

IT SHALL BE THE RESPONSIBILITY OF THE ELECTRICAL CONTRACTOR FOR THE ADVANCE ORDERING

RESULTING IN ANY DOWN OR LAG TIME. THE CONTRACTOR SHALL NOT ORDER ANY ITEMS UNTIL

INSTALLING CONDUITS, ETC. LAYOUT SHALL CONSIST OF PLAN VIEWS (SCALED AS REQUIRED) AND

EQUIPMENT SHALL BE AS SPECIFIED ON PLANS: THE RESPONSIBILITY TO ACCEPT OR REJECT ANY

PROPOSED SUBSTITUTION REMAINS WITH THE PROJECT ENGINEER. THE CONTRACTOR MAY AT HIS

JUDGMENT USE ANY ARTICLE, DEVICE, PRODUCT, OR MATERIAL WHICH IN THE JUDGMENT OF THE

ALL CONDUCTORS SHALL BE COPPER, TYPE THHN/THWN EXCEPT WHERE OTHERWISE REQUIRED BY

J.L. OR CODES. MINIMUM WIRE SIZE SHALL BE #12 AWG, EXCLUDING CONTROL WIRING.

ALL CONDUCTORS SHALL BE IN CONDUITS. ALL CONDUITS SHALL BE GALVANIZED RIGID STEEL

RISERS ARE GALVANIZEÓ RIGID STEEL OR SCHEDULE 80 PVC, WHERE SUBJECT TO PHYSICAL

DAMAGE (b) ELECTRICAL METALLIC TUBING (EMT) MAY BE USED IN OR ON WALLS OR CEILINGS

TIGHT FLEXIBLE CONDUIT WHERE REQUIRED, (d) FLEXIBLE METALLIC CONDUIT WHERE REQUIRED IN

PERMITTED. ALL CONDUITS IN HAZARDOUS AREAS (PER NEC) SHALL MEET THE REQUIREMENTS

PPROVED FOR THE INTENDED USE. WARNING TAPE WHICH SAYS "WARNING BURIED ELECTRIC"

CONDUITS ARE NOT EXPOSED TO MECHANICAL DAMAGE OR ARE NOT UNDER PAVED AREAS, THEY

ALL CONDUIT RUNS ARE SHOWN DIAGRAMMATIC. EXACT ROUTING SHALL BE DETERMINED IN THE

COORDINATE WITH LOCATION OF EQUIPMENT IN A MANNER TO BE CLEAN AND FUNCTIONAL. THE

PARTITIONS, WALLS AND STRUCTURAL SLABS. CONTRACTOR TO VERIFY, PRIOR TO SUBMITTING BID,

REQUIRED BY SPECIFICATION). TWO AND THREE POLE CIRCUIT BREAKERS SHALL BE COMMON TRIP.

ALL CIRCUIT BREAKERS SHALL BE INVERSE TIME TYPE (THERMAL MAGNETIC OR SOLID STATE AS

CONTRACTOR SHALL INSTALL ONLY ONE CONDUIT PER HOLE AND SEAL THE OPENING AROUND

WHERE NOT SUBJECT TO MECHANICAL DAMAGE, DAMP OR CORROSIVE CONDITIONS, (c) LIQUID

DRY LOCATIONS ONLY. (e) MC CABLE WITH DEDICATED GREEN GROUNDING CONDUCTOR WHERE

FOR UNDERGROUND ELECTRICAL CONDUITS, PROVIDE PULL BOXES, SUCH THAT NO SINGLE CONDUIT RUN HAS BENDS IN EXCESS OF 360. PULL BOXES SHALL BE SUITABLE AND

HALL BE PLACED IN TRENCHES ABOVE ALL UNDERGROUND ELECTRIC CONDUITS. WHERE

CONDUITS PASS UNDERNEATH PAVED AREAS, THEY SHALL BE PVC. WHERE UNDERGROUND

WIREWAYS SHALL BE SIZED AS REQUIRED, PER NEC, UNLESS OTHERWISE NOTED (UON).

WATERTIGHT AFTER UTILITIES HAVE BEEN INSTALLED. LOCATION OF CORED HOLES SHALL

PROVIDE FIRE RETARDANT U.L. APPROVED SEALANT ON ALL PENETRATIONS OF FIRE RATED

LOCATIONS OF ALL SUCH FIRE RATED PARTITIONS. WALL AND STRUCTURAL SLABS.

UNLESS NOTED AS EXISTING, ALL EQUIPMENT, WIRING, DEVICES, ETC. SHALL BE NEW.

WHERE CORE DRILLING OF FLOOR/WALLS IS REQUIRED. CONTRACTOR SHALL SEAL OPENINGS

(GRS) EXCEPT THAT: (a) PVC CONDUITS MAY BE USED UNDERGROUND PROVIDED ELBOWS AND

OF LONG LEAD ITEMS, AS TO NOT INTERFERE WITH THE PRODUCTION OF OTHER TRADES

ELECTRICAL CONTRACTOR SHALL SUBMIT (6 COPIES) EQUIPMENT LAYOUT OF ALL ELECTRICAL

SPACES, ROOMS, ETC., TO ENGINEER FOR APPROVAL PRIOR TO ORDERING EQUIPMENT OR

CONTRACTOR SHALL SUBMIT AT ONE TIME, SIX (6) SETS OF LOOSE-LEAF BOUND BOOKS,

INDEXED WITH ALL PRODUCTS, MATERIALS, LIGHTING FIXTURES, LAMPS, WIRING DEVICES,

SWITCHGEAR, ETC. CLEARLY HIGHLIGHTING ALL EQUIPMENT QUANTITIES AND DETAILS.

THE CONTRACTOR SHALL BE RESPONSIBLE FOR REPAIRING TO ORIGINAL CONDITIONS, ANY AND

CORRECTION OF ANY DEFECTS SHALL BE COMPLETED WITHOUT ADDITIONAL CHARGE OR DELAYS

AND SHALL INCLUDE REPLACEMENT OR REPAIR OF ANY OTHER PHASE OF THE INSTALLATION

A. VERIFY LOCATION OF POWER SERVICE TERMINATION WITH POWER COMPANY PRIOR TO

POWER COMPANY PRIOR TO BID AND PROVIDE BID ALLOWANCE FOR ALTERNATES.

FOR FLECTRIC POWER SYSTEM, COORDINATE POWER SERVICE WITH POWER COMPANY

CONTRACTOR SHALL PAY FOR ALL PERMITS, FEES, INSPECTIONS, AND TESTING COSTS.

16. COORDINATE ALL ELECTRICAL SITE WORK WITH ALL OTHER TRADES CONTRACTORS.

ELEVATIONS (DIMENSIONED) FOR EACH SUCH SPACE, ROOM, ETC.


ENGINEER EXPRESSED IN WRITING ARE EQUAL TO THAT SPECIFIED.


- PLANS AND PROVIDE FIXTURE TRIM AS REQUIRED. 4. ALL COMPACT FLUORESCENT DOWNLIGHTS SHALL USE LAMPS WITH 3500K TEMPERATURE, MINIMUM
- PROVIDE APPROVED FIRE RATED ENCLOSURES FOR ALL LIGHT FIXTURES LOCATED IN FIRE RATED
- 6. FIXTURES IN AREAS WITHOUT CEILINGS, OR IN MECHANICAL AND ELECTRICAL ROOMS SHALL BE MOUNTED WITH 1 ½"X1 ½"KINDORF CHANNEL SUPPORT SUSPENDED FROM ROOF STRUCTURE WITH THREAD RODS. FIXTURES SHALL BE MOUNTED 10'-0" A.F.F.
- ALL ACRYLIC LENSED FIXTURES SHALL HAVE A LENS THICKNESS OF .125 INCHES MINIMUM. HALF SHADED FIXTURES DENOTE EMERGENCY FIXTURES EITHER WITH 1100 LUMEN EMERGENCY
- BATTERY PACK OR ON LIFE SAFETY CIRCUIT LIGHTING FIXTURE SCHEDULE IS PREDICTED ON PERFORMANCE AND IS DESIGNED TO MEET CERTAIN AESTHETIC CRITERIA. ALL ALTERNATIVE SELECTIONS MUST BE SUBMITTED FOR PRIOR APPROVAL TEN (10) DAYS PRIOR TO BID DATE.
- ALL BALLASTS SHALL HAVE MINIMUM POWER FACTOR OF 0.90. ALL BALLASTS FOR METAL HALIDE 20. AND HIGH PRESSURE SODIUM FIXTURES SHALL BE CONSTANT WATTAGE TYPE WITH +/-5% LAMP WATTS FOR +/-10% NOMINAL LINE VOLTAGE VARIATION.
- PROVIDE LAMPS WITH FIXTURES, VERIFY LAMP TYPE WITH MANUFACTURER. FLUORESCENT LUMINAIRES THAT UTILIZE DOUBLE-ENDED LAMPS AND CONTAIN BALLAST(S) OR MULTIWIRE BALASTED LUMINAIRES SHALL CONTAIN AN INTEGRATED INTERNAL DISCONNECT AND TO 23. BE COMPLIED WITH NEC 410.130(G).
- ALL OPENINGS FOR LIGHT FIXTURES IN CEILINGS SHALL BE PROTECTED IN A MANNER (PER ALL GOVERNING CODES) THAT WILL PROVIDE THE SAME RATING AS THE CEILING. (THIS APPLIES TO ALL FIRE RATED CEILINGS).
- FOR EMERGENCY EXIT SIGNS AND EMERGENCY BATTERY PACKS MAKE CONNECTION AHEAD OF ALL 24. SWITCHES AND CONTROLS.
- PROVIDE A FUSE HOLDER AND FUSE (BUSSMAN HEB AND FNQ OR EQUAL). IN THE PRIMARY SIDE OF EACH UNGROUNDED CONDUCTOR FOR ALL BALLASTS AT THE HAND HOLE OF EACH EXTERIOR POLE MOUNTED LIGHTING FIXTURE OR J-BOX FOR WALL OR GROUND MOUNTED FIXTURE.

- PROVIDE WIND LOAD RATED LIGHT POLES WITH 170 MPH MINIMUM WIND SPEE EXPOSURE C WITH IMPORTANCE FACTOR OF 1.0, AND PROVIDE PHOTOMETRICS SUBMITTALS. CONTRACTOR TO VERIFY VOLTAGES OF ALL LIGHT FIXTURES PRIOF
- PHOTOMETRICS ARE BASED ON MANUFACTURER'S INFORMATION AND CATALOG ALTERNATIVE MANUFACTURERS MUST PROVIDE THE IESNA FORMAT ELECTRONIC INDEPENDENT TEST LAB REPORTS FOR THE PROPOSED FIXTURES ON CD OR USB DRIVE 10 WORKING DAYS PRIOR TO BID. (SPECIFIER) WILL CONFIRM THAT THE PHOTOMETRIC CRITERIA HAS BEEN MET. AND IF ALTERNATE IS APPROVED WILL ISSUE AN ADDENDUM. MANUFACTURERS NOT LISTED ON THE PLANS OR IN AN ADDENDUM WILL NOT BE ACCEPTED.
- TO CONFIRM THAT THE SPECIFIED PHOTOMETRIC CRITERIA HAS BEEN MET, A COMPUTER DISK CONTAINING AN IES FILE FOR THE PROPOSED ALTERNATE MUST BE SUBMITTED TO (SPECIFIER) FOR EVALUATION NO LESS THAT 10 DAYS PRIOR TO BID. ANY ACCEPTABLE ALTERNATE MUST BE
- APPROVED IN WRITING PRIOR TO BID DATE. CONTRACTOR MUST BID PROJECT USING SPECIFIED LIGHTING FIXTURES AS BASE BID (NO EXCEPTIONS). IF ALTERNATE FIXTURES ARE PROPOSED, THEY MUST BE BID AS AN ALTERNATE BID MUST INCLUDE: A) TOTAL DOLLAR CREDIT TO OWNER IF ALTERNATE IS ACCEPTED. B) LINE ITEM CREDIT FOR EACH ALTERNATE FIXTURE PROPOSED.
- C) CATALOG SUBMITTAL DATA FOR EACH ALTERNATE FIXTURE PROPOSED IF THERE IS A DISCREPANCY BETWEEN A FIXTURE DESCRIPTION AND GENERAL NOTES, AND THE CATALOG NUMBER LISTED, THE FIXTURE DESCRIPTION AND GENERAL NOTES SHALL GOVERN.

COORDINATE FIXTURE TYPES WITH ARCHITECTURAL DRAWINGS.

- INTERNALLY ILLUMINATED EXIT SIGNS SHALL NOT EXCEED 5 WATTS PER SIDE. RECESSED LUMINAIRES INSTALLED IN THE BUILDING THERMAL ENVELOPE SHALL BE SEALED TO LIMIT AIR LEAKAGE BETWEEN CONDITIONED AND UNCONDITIONED SPACES. ALL RECESSED LUMINAIRES SHALL BE IC-RATED AND LABELED AS MEETING ASTM E 283 WHEN TESTED AT 75 Pg PRESSURE DIFFERENTIAL WITH NO MORE THAN 2.0 CFM OF AIR MOVEMENT FROM THE CONDITIONED SPACE T THE CEILING CAVITY. ALL RECESSED LUMINAIRES SHALL BE SEALED WITH A GASKET OR CAULK BETWEEN THE HOUSING AND THE INTERIOR WALL OR CEILING COVERING.
- ALL EXTERIOR PARKING LIGHTING SHALL MEET IES ILLUMINATION STANDARDS AND LOCAL CODE REQUIRED FOOTCANDLE LEVELS. ILLUMINATION LEVELS SHALL BE MEASURED WITH A FOOTCANDLE METER AT COMPLETION OF THE PROJECT BY A REGISTERED PROFESSIONAL ENGINEER AND SAID ENGINEER SHALL ISSUE A LETTER ATTESTING TO COMPLIANCE WITH ALL CODE REQUIREMENTS.

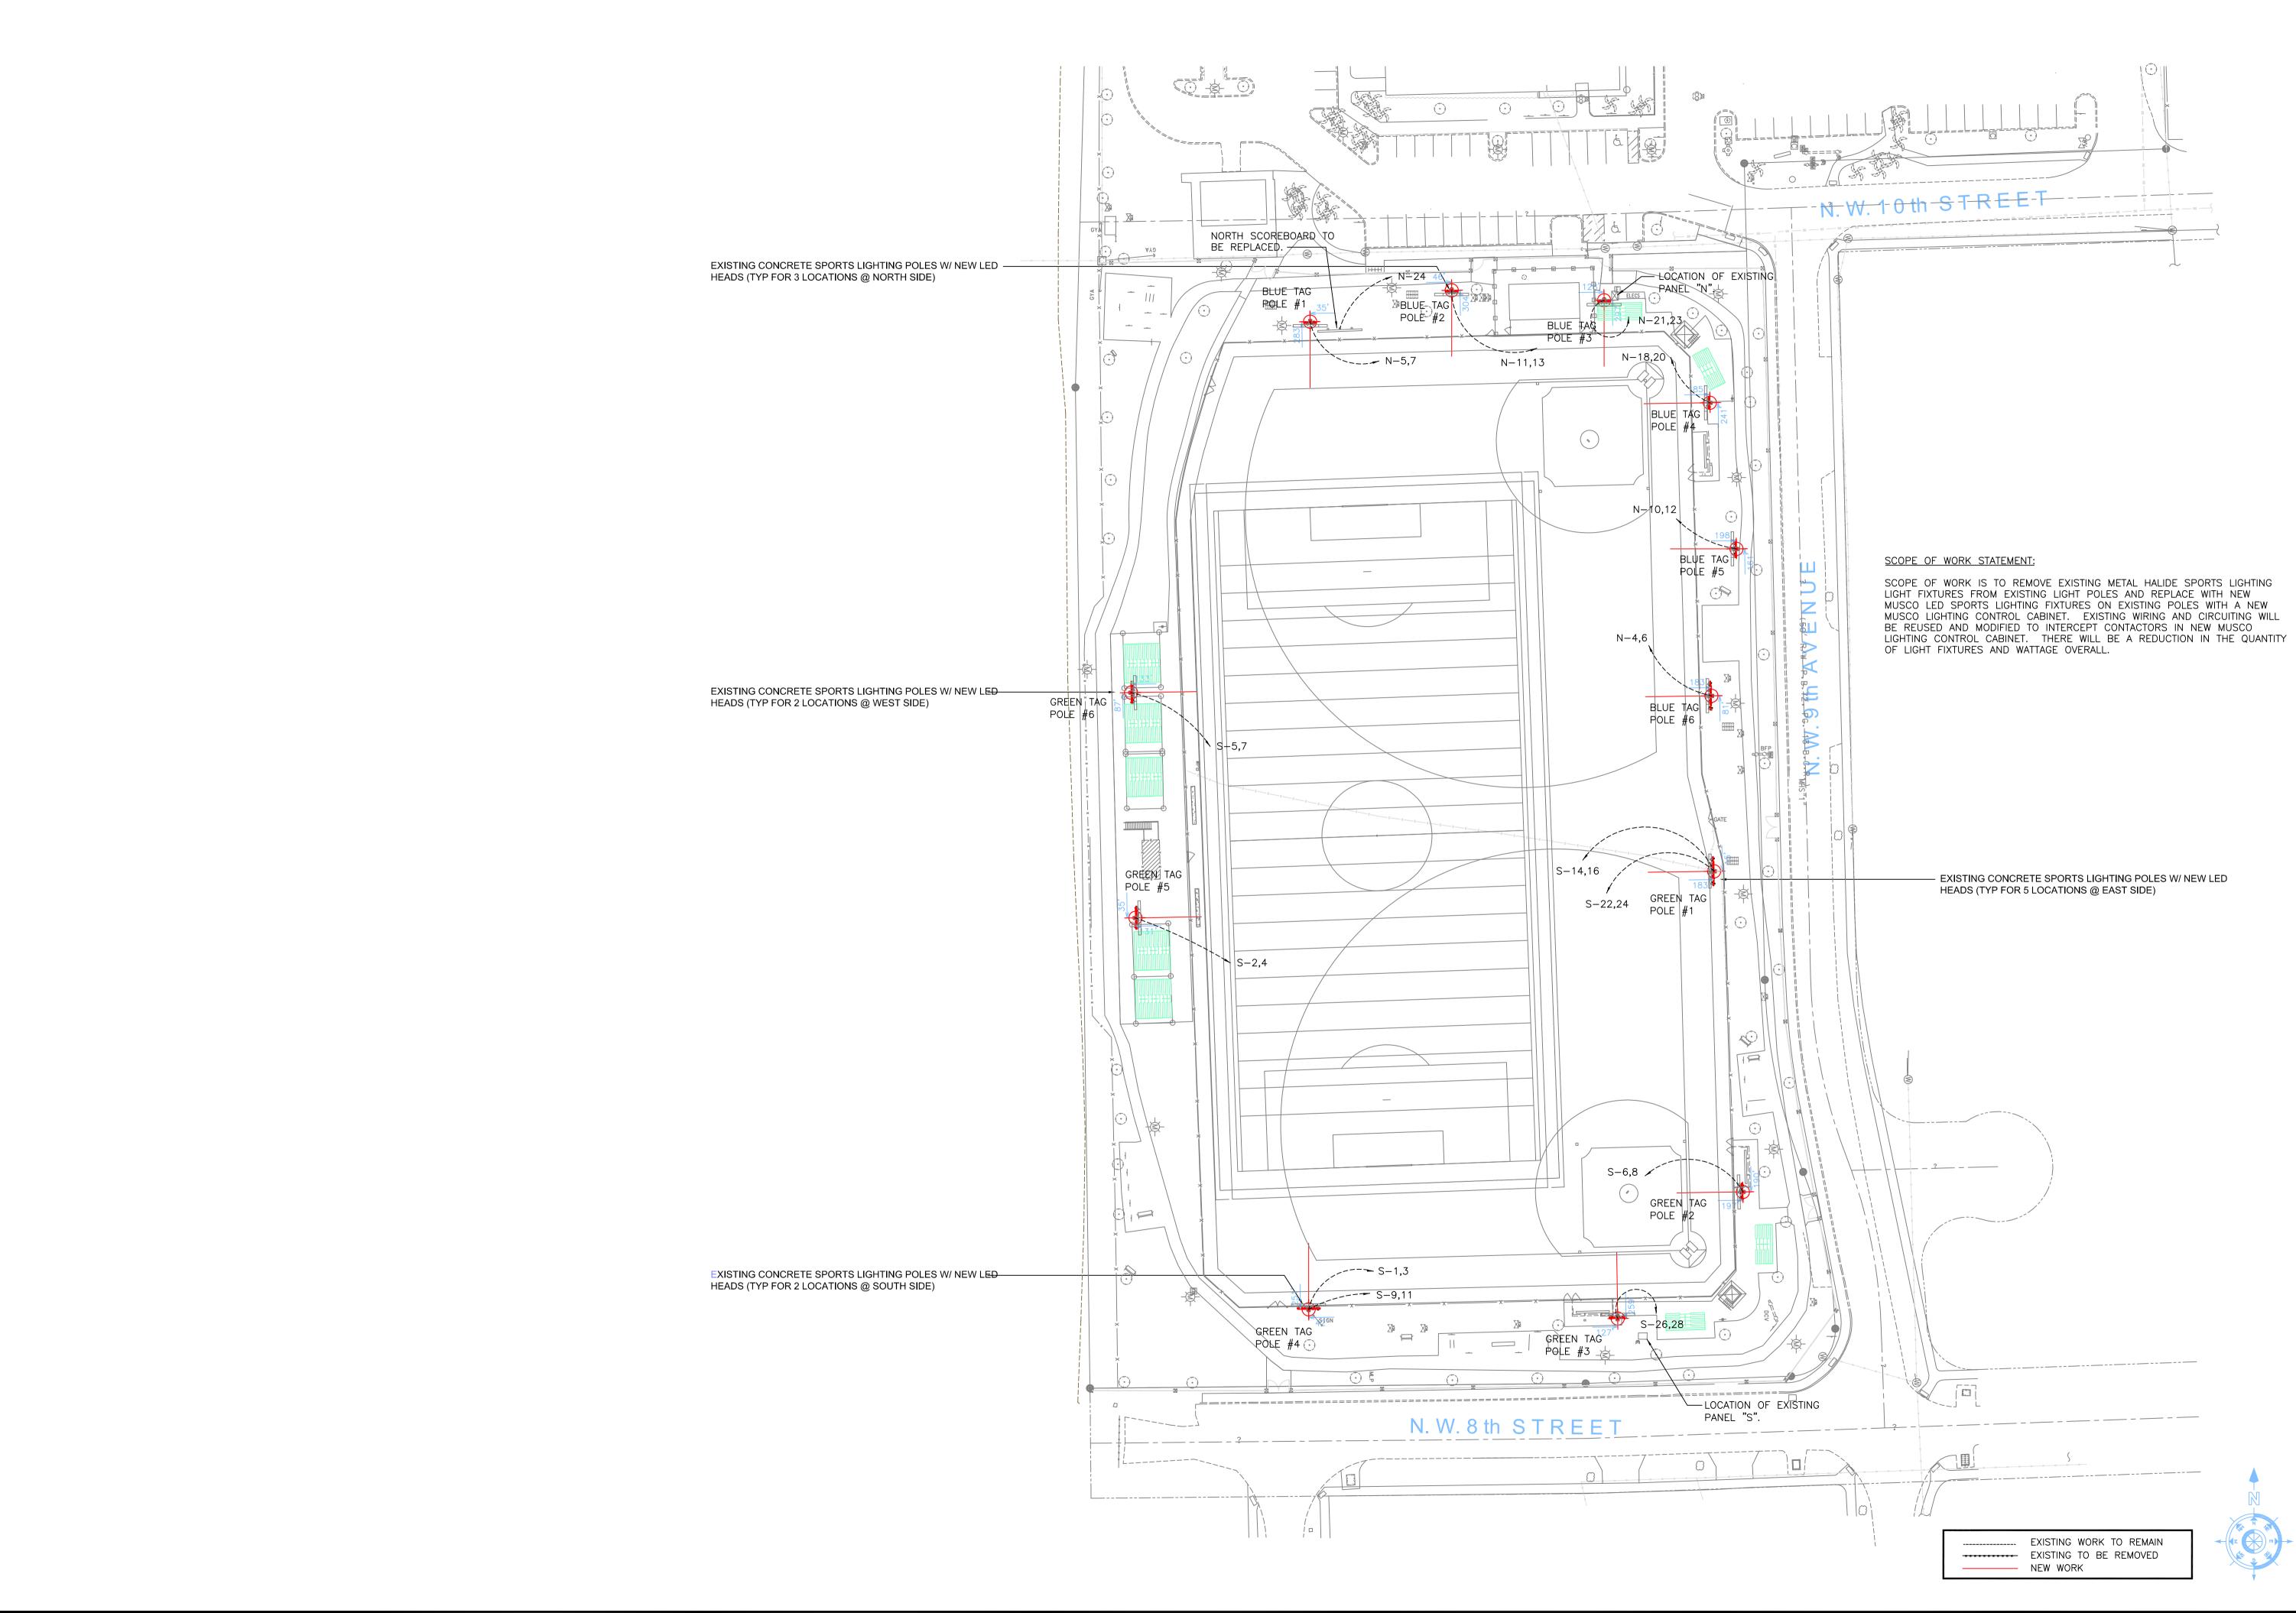

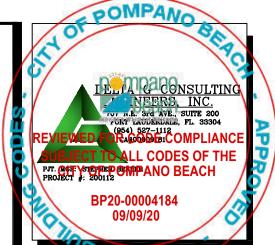

Digitally signed by George George Sanjuan Reason: I am approvingthis Sanjua document Location: Fort Lauderdale, Fl Date: 2020.06.05 10:06:05 -04'00'

> GEORGE SANJUAN, P.E. FLORIDA LICENSE #46100



WALTERS ZACKRIA

ARCHITECTS

5813 N. ANDREWS WAY, FORT LAUDERDALE, FL 33309 PHONE: (954) 522-4123 FAX: (954) 522-4128


www.wza-architects.com Abbas H. Zackria, FL AR 91520

Florida Registration: AA26000970 CORPORATE NAME: WALTERS ZACKRIA ASSOCIATES, PLLC REGISTERED IN THE STATE OF FLORIDA. WRITTEN DIMENSIONS TAKE PRECEDENCE OVER SCALED DIMENSIONS. THESE DRAWINGS ARE THE PROPERTY OF WALTERS ZACKRIA ASSOCIATES, PLLC, AND SHALL NOT BE REPRODUCED WITHOUT WRITTEN PERMISSION FROM A PRINCIPAL OF THE FIRM OR BE LIABLE FOR THE FULLEST LEGAL RECOURSE. CONTRACTOR SHALL VERIFY ALL EXISTING CONDITIONS AND DIMENSIONS AND NOTIFY THE ARCHITECT OF ANY DISCREPANCIES PRIOR TO EXECUTION OF WORK.

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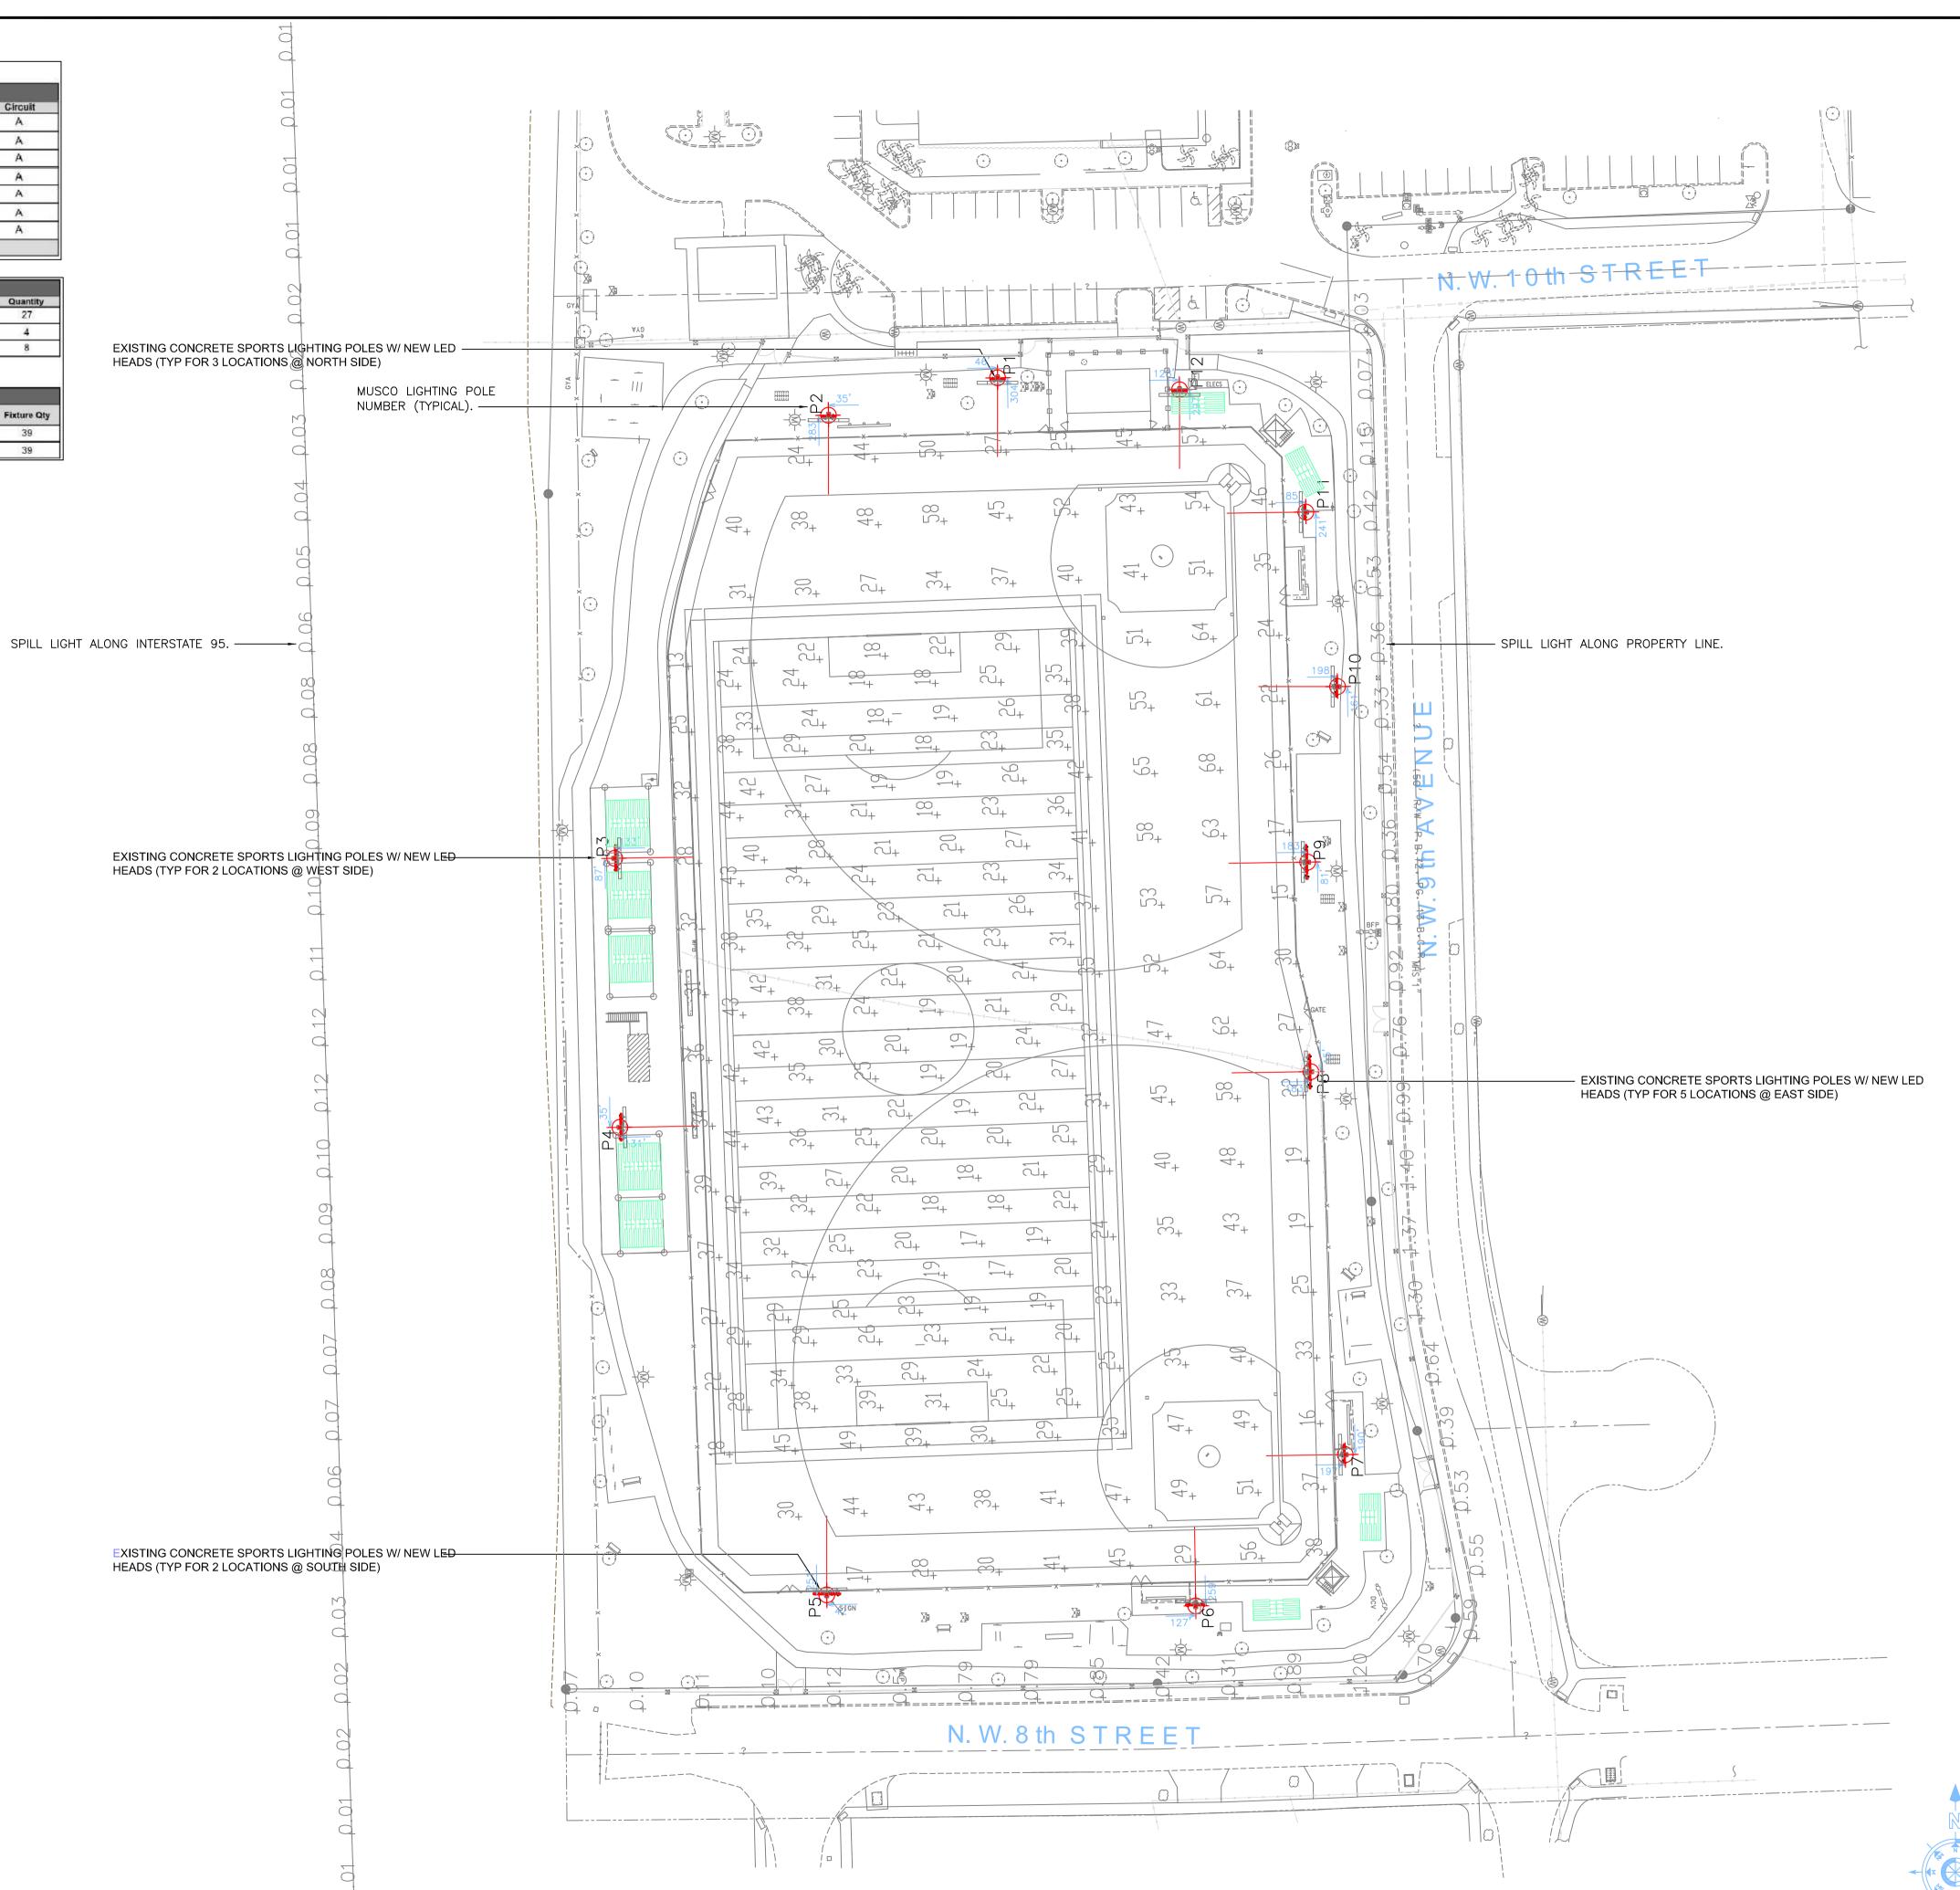
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ixture Type Summary									
Туре	Source	Wattage	Lumens	L90	L80	L70	Quantity		
TLC-LED-1500	LED 5700K - 75 CRI	1430W	160,000	>81,000	>81,000	>81,000	27		
TLC-LED-900	LED 5700K - 75 CRI	890W	89,600	>81,000	>81,000	>81,000	4		
TLC-LED-1200	LED 5700K - 75 CRI	1170W	136,000	>81,000	>81,000	>81,000	8		


Light Level Summary

6:41	61.14.14.14			Illumination			C1 14	Fi-1 01
Grid Name	Calculation Metric	Ave	Min	Max	Max/Min	Ave/Min	Circuits	Fixture Qty
Area Grid	Horizontal	34	13	68	5.22	2.62	А	39
Multipurpose	Horizontal Illuminance	27.4	17	44	2.54	1.61	A	39

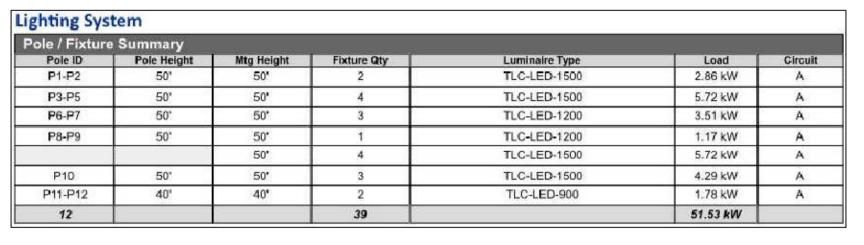

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Date: 2020.06.05 10:06:30 -04'00' GEORGE SANJUAN, P.E. FLORIDA LICENSE #46100

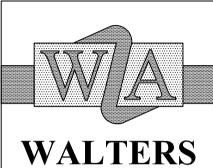

ZACKRIA **ARCHITECTS**

> 5813 N. ANDREWS WAY, FORT LAUDERDALE, FL 33309 PHONE: (954) 522-4123

FAX: (954) 522-4128 www.wza-architects.com Abbas H. Zackria, FL AR 91520

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E3.00

PROPOSED SITE PLAN - ELECTRICAL

PROPOSED SITE PLAN -PHOTOMETRICS


BLUE TAG POLE IDENTIFIER - NORTH ELECTRICAL SERVICE

POLE IDENTIFIER	QUANTITY OF EXISTING 1500 WATT METAL LAMPS TO BE REMOVED	WATTAGE OF NEW REPLACEMENT MUSCO LED SPORTS LIGHTING
BLUE TAG POLE NUMBER #1	5 x 1,610 WATTS = 8,050 WATTS	2,860 WATTS
BLUE TAG POLE NUMBER #2	$5 \times 1,610 \text{ WATTS} = 8,050 \text{ WATTS}$	2,860 WATTS
BLUE TAG POLE NUMBER #3	$5 \times 1,610 \text{ WATTS} = 8,050 \text{ WATTS}$	1,780 WATTS
BLUE TAG POLE NUMBER #4	$5 \times 1,610 \text{ WATTS} = 8,050 \text{ WATTS}$	1,780 WATTS
BLUE TAG POLE NUMBER #5	$5 \times 1,610 \text{ WATTS} = 8,050 \text{ WATTS}$	4,290 WATTS
BLUE TAG POLE NUMBER #6	$5 \times 1,610 \text{ WATTS} = 8,050 \text{ WATTS}$	6,890 WATTS
	-48,300 WATTS	+20,460 WATTS

48,300 WATTS REMOVED + 20,460 WATTS ADDED = -27,480 WATT REDUCTION

OF LOAD ON NORTH ELECTRICAL SERVICE

	ATION: SEE XISTING	SITE PLAN □ NEW				PA	NE		"N" S(H	EDI	<u>JLE</u>					SPEC: SQU ■ COPPER E			
скт.		DESCRIPTION	wire	GRD.	COND.	POLE/ TRIP	ΑР	VA HASE			VA HASE	POLE/ TRIP	COND.	GRD.	WIRE	~RE	LOAD DE	SCRIPTI	ON	СК
3	SPARE		-	-	_	2/100	<u> </u>	<u> </u>			7 4	2 /50	_	<u>–</u> Е	_		SPACE BLUE TAG POL	- NII IN 4	DED 6	4
	BLUE TAG	POLE NUMBER 1	E	E	E	2/50	1 Δ	3.4	·,,,,,,,,,,,,,,,,,,,,,,,,,,,,,,,,,,,,,	_	3.4	2/50	E	<u> </u>	Ε		BLUE TAG POL	E NUM	BEK 6	- 6
7	BEGE TAG	TOLL HOMBLIC	-	-	_	2,00				1.4		_	_	_	_	S	SPACE			1
9	SPACE		_	_	-	_	_	2.1				2/50	Е	Е	Е	E	BLUE TAG POL	E NUM	BER 5	1
-	BLUE TAG	POLE NUMBER 2	E	E	E	2/50				1.4	2.1									1
13		_					1.4	_				-	_	_			SPACE			1
	RECEPTACL EXISTING C		E	E	E	20	1 0			0.2	_	20 2/50	E E	E	E		EXISTING CIRCU BLUE TAG POL		DED 4	1
	SPACE	IRCUIT	E	E	E _	20	1.0	0.4			0.4	2/30	C.	Ε	Ε		SLUE TAG POL	L NUM	DER 4	2
		POLE NUMBER 3	E	E	Е	2/50	0.9	<u> </u>			0.4	_	_	_	_	5	SPACE			2
23				-	_	_, -,				0.9	_	20	E	Е	Е		COREBOARD			2
		NTROL CABINET	12	12	1/2"	20*	1.0	_				_	_	_	_		SPACE			2
	SPACE		_	_	-	_				_	_	_	_	_	_		SPACE			2
$\overline{}$	SPACE			-		TOTAL	_	1.6			<u> </u>	_	_	_	_		SPACE			3
ALL FI NOT M	EEDER CALCULA IORE THAN 4 C	TIONS ARE BASED ON: THE ONDUCTORS IN A RACEWAY	HN/THWN C		KVA IS AMPERES			1.6	21.4 KV 89.2 AM	Ά	.8		t type Iunt trii	_	RC FAI		(TS) TIME SWI T (OB) DEDICATI		NTROL ISOLATE	D GR
				ESTIMA	TED DEI	MAND LO	DAD=		XXX AN	PS		POLE TRIP TYP								
RAT	ED VOLTAGE	= 120/240 VOLTS	1 PHA	SE	3 WIF	RE	E Q	PT. G	RD. 🗆 ISC	L. GF	RD.	MAIN	S:] M.L.O.		BREAKER :	2	225	
FEE	EDER IS:	■ CABLE							BUSWAY			BRAN	CH POLE	S: 30	В	RANC	H BREAKERS=	1	O KAIC	
MOL	JNTING:	SURFACE	☐ FLUS	H	☐ FRE	E STAND	ING] KEYED D	OOR		BUS F	RATING:	225	а В	RACIN	NG =	1	O KAIC	
NEU	TRAL BUS IS	: □HALF SIZE	■ FULL	SIZE	□ K F	ATED (1.	5)] K RATED (2.0)		GROU	ND BAR		EQUIPM	ENT I	□ ISOLATED	□вс	TH	
ENC	LOSURE :	NEMA 1	☐ NEM.	3R	☐ NEI	AA 4X	CLA	ASS () DIV	()		FEED	LOCATI	ON: 🔼	TOP	ı	□ ВОТТОМ	☐ FE	ED THRU	
PAN	EL TYPE :	□FUSED	□ св ғ	☐ CB PLUG IN ■ CB BOLT IN									FROM:		NORMAL		☐ EMERGENCY	□ UN	INTERRUF	² TAB
			NOTE	: E = * =			UIT	BRFA	KER TO	MAT	CH F	XISTIN	IG TYF	PF						

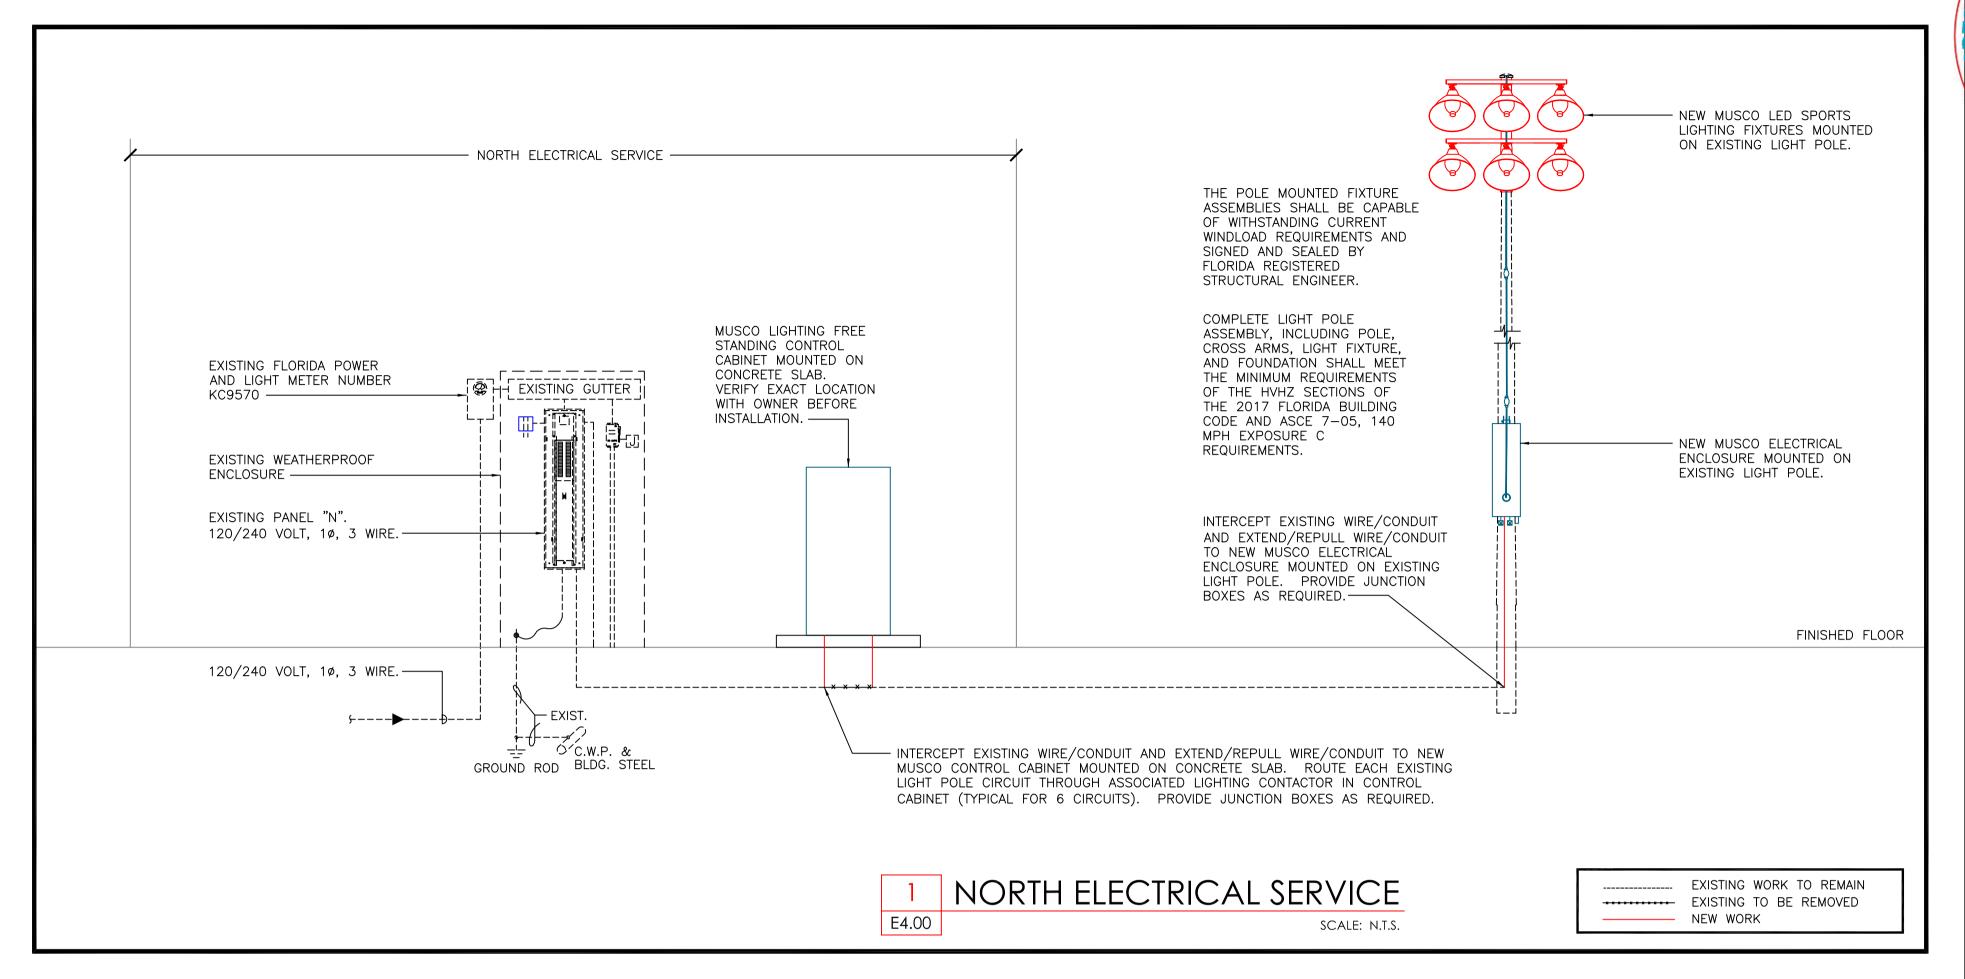


<u>GREEN TAG POLE IDENTIFIER - SOUTH ELECTRICAL SERVICE</u>

OF LOAD ON SOUTH ELECTRICAL SERVICE

POLE IDENTIFIER	QUANTITY OF EXISTING 1500 WATT METAL LAMPS TO BE REMOVED	WATTAGE OF NEW REPLACEMENT MUSCO LED SPORTS LIGHTING
GREEN TAG POLE NUMBER #1	9 x 1,610 WATTS = 14,490 WATTS	6,890 WATTS
GREEN TAG POLE NUMBER #2	4 x 1,610 WATTS = 6,440 WATTS	3,510 WATTS
GREEN TAG POLE NUMBER #3	4 x 1,610 WATTS = 6,440 WATTS	3,510 WATTS
GREEN TAG POLE NUMBER #4	9 x 1,610 WATTS = 14,490 WATTS	5,720 WATTS
GREEN TAG POLE NUMBER #5	6 x 1,610 WATTS = 9,660 WATTS	5,720 WATTS
GREEN TAG POLE NUMBER #6	7 x 1,610 WATTS = 11,270 WATTS	5,720 WATTS
	-62,790 WATTS	+31,070 WATTS
62,790 WATTS REMOVED + 31,07	70 WATTS ADDED = $-31,720$ WATT RE	DUCTION

LOCATION: SEE	SITE PLAN				PA	NE	<u>.</u> "	'S" S	CHE	EDU	JLE				SPEC: SIEMENS TYPE P ■ COPPER BUS □ ALUMINUI	
		WIRE	GRD.	COND.	POLE/ TRIP		VA HASE			VA HASE	POLE/ TRIP	COND.	GRD.	WIRE	LOAD DESCRIPTION	CI
1 GREEN TAG	G POLE NUMBER 4	E	E	E	2/40	2.8	2.8		2.8	2.8	2/50	E	E	E	GREEN TAG POLE NUMBER 5	
5 GREEN TA	G POLE NUMBER 6	E	E	E	2/50	2.8	1.8		2.8	1.8	2/40	E	E	E	GREEN TAG POLE NUMBER 2	Ŧ
9 GREEN TA	G POLE NUMBER 4	E	Е	Е	2/40		0.8			1.0	20 20	E E	E E	E E	PHOTO BACKSTOP #1	
13 BACKSTOP 15 BACKSTOP	#2	E E	E E	E E	20 20	1.0	3.4		1.0		2/40	Ē	Ē	Ē	GREEN TAG POLE NUMBER 1	7
17 SPARE	#-O		_	-	2/40		1.2			1.2	2/20	Е	Ε	E	WALKWAY LIGHTS	+
21 SCOREBOA 23 SPARE	RD	E -	E -	E -	20 2/40	1.0			_		2/40	E	Ε	E	GREEN TAG POLE NUMBER 1 TO BECOME SPARE	
25 27 EXISTING (CIRCUIT	E	E	E	20	-	1.8		0.8	1.8	2/40	E	E	E	GREEN TAG POLE NUMBER 3	
31 SPACE	NTROL CABINET	12 —	12 -	1/2"	20* -	1.0	_				_ _		_	-	SPACE SPACE	\perp
33 SPACE 35 SPACE			_	_	_	<u> </u>	_		//////////////////////////////////////	<u>—</u>	_ _	_	-	_	SPACE SPACE	+
37 SPACE 39 SPACE			_	_	_ _	<u> </u>	_			//////////////////////////////////////	_ _		_	_ _	SPACE SPACE	
41 SPACE	ATIONIC ADE. DACED ON THE		_		– BTOTAL	_ 	 D.4). 4	- CIRCUIT	– T TYPE	- · Æ /	- ARC FAI	SPACE ULT (TS) TIME SWITCH CONTROL	I
	ATIONS ARE BASED ON: THE CONDUCTORS IN A RACEWAY	IN/IHWN CO.	TOTAL	KVA IS AMPERES	i IS			39.8 I 165.8 i			ST) SH	FAULT (B) DEDICATED (G) ISOLATEI	D (
			ESTIMA	TED DE	MAND LO	DAD=		XXX /	AMPS						POLE TRIP	T
RATED VOLTAG	E= 120/240 VOLTS	1 PHAS	SE .	3 WIF	RE	EQ F	PT. G	RD. 🗆 IS	SOL. GF	RD.	MAIN]M.L.O.	■ BREAKER: 225	_
FEEDER IS								IBUSWAY				CH POLE			RANCH BREAKERS= 10 KAIC	_
MOUNTING:	SURFACE	☐ FLUSH	1	☐ FRE	E STAND	ING		KEYED	DOOR			RATING:	225		RACING = 1 O KAIC	_
NEUTRAL BUS I	S: HALF SIZE	■ FULL	SIZE K RATED (1.5) K RATED (2.0)							GROU	ND BAR	:	EQUIPM	ENT 🗆 ISOLATED 🗀 BOTH		
ENCLOSURE :	■ NEMA 1	☐ NEMA	3R	☐ NE	MA 4X	CLA	ASS () DI	V ()		FEED	LOCATI	ON:	TOP	☐ BOTTOM ☐ FEED THRU	
PANEL TYPE :	□FUSED	☐ CB PI	UG IN	■ CB	BOLT IN						FED	FROM:		NORMAL	□ EMERGENCY □ UNINTERRUP	'TA

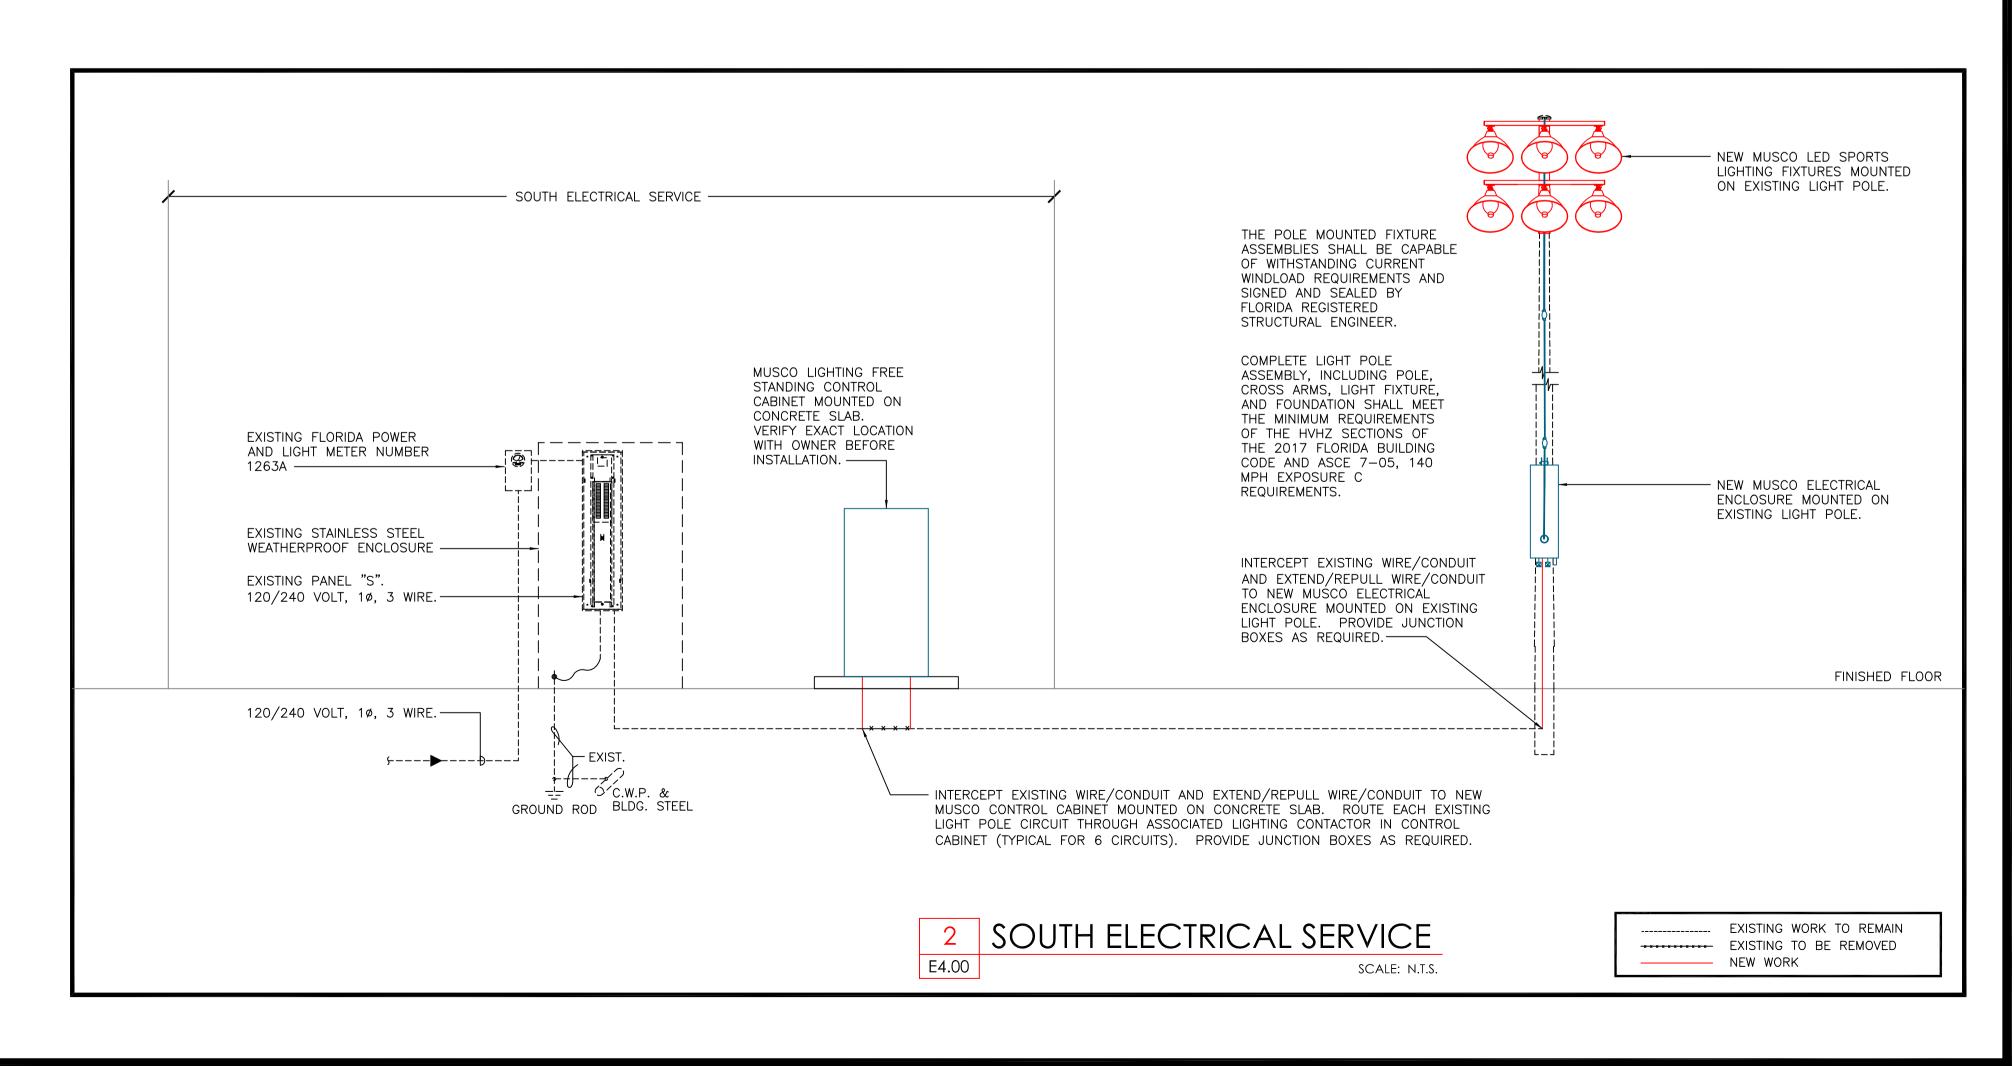

Digitally signed by George

George Sanjuan Reason: I am Sanjua approvingti Location: Fort Lauderdale, Fl Date: 2020.06.05 10:06:59 -04'00' GEORGE SANJUAN, P.E.



FLORIDA LICENSE #46100

5813 N. ANDREWS WAY, FORT LAUDERDALE, FL 33309 PHONE: (954) 522-4123

FAX: (954) 522-4128 www.wza-architects.com

ARCHITECTS

Abbas H. Zackria, FL AR 91520 CORPORATE NAME: WALTERS ZACKRIA ASSOCIATES, PLLC REGISTERED IN THE STATE OF FLORIDA. WRITTEN DIMENSIONS TAKE PRECEDENCE OVER SCALED DIMENSIONS. THESE DRAWINGS

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LEGAL RECOURSE. CONTRACTOR SHALL VERIFY ALL EXISTING CONDITIONS AND DIMENSIONS AND NOTIFY THE ARCHITECT OF ANY DISCREPANCIES PRIOR TO EXECUTION OF WORK.

BEACH PARK ANO MO

DRAWN BY: GSJ CHECKED BY: 06/05/2020 REVISIONS:

ELECTRICAL DETAILS

STRUCTURE			TVDE	DIDECTION
NUMBER	RIM ELEVATION	INVERT	IYPE	DIRECTION
CB "A"	7.85'	1.65'	48" RCP	EAST
	7.00	1.65'	48" RCP	WEST
		3.94'	12" RCP	NORTH
CB "B"	7.84'	1.59'	48" RCP	EAST
		1.69'	48" RCP	WEST
		4.32'	12" RCP	NORTH
CB "C	8.07'	1.72'	48" RCP	EAST
		1.87'	48" RCP	WEST
CB "D"	7.93'	4.63'	12" RCP	SOUTH
CB "E"	7.92'	4.37'	12" RCP	SOUTH
CB "F"	9.99'	5.29'	18" RCP	WEST
CB "G"	10.04	5.27'	18" RCP	EAST
CB "H"	0.00'	5.96'	6" PVC	WEST
	9.26'	N/A	N/A	BAFFLE (SOUTH)
CB "I"	9.21'	5.00'	18" PVC	NORTH
		6.52'	6" PVC	EAST
CB "J"	9.64'	N/A	48" RCP 12" RCP 48" RCP 48" RCP 12" RCP 48" RCP 48" RCP 12" RCP 12" RCP 12" RCP 12" RCP 12" RCP 18" RCP 18" RCP 18" RCP 18" RCP	BAFFLE (SOUTH)
		6.27'		EAST
CB "K"	9.67'	N/A		BAFFLE (NORTH)
CB "L"	9.92'	6.92'		SOUTH
CB "M"	9.90'	6.87		NORTH
CB IVI	9.90	5.85		SOUTH
CB "N"	8.85'	N/A		
		·		BAFFLE (EAST)
CB "O"	9.57'	5.97		NORTH
		N/A		BAFFLE (WEST)
MHS "1"	9.30'	4.73'		NORTH
		3.68'		SOUTH
MHS "2"	9.33'	3.63'		EAST
		4.73'		WEST
		3.27		NORTH
MHS "3"	9.54'	3.11'	8" CLAY	EAST
		3.16'	8" CLAY	WEST
MHS "4"	9.47'	4.27'	8" CLAY	NORTH
WII 13 +	5.47	4.20'	8" CLAY	SOUTH
		5.28'	8" CLAY	NORTH
MHS "5"	9.72'	5.22'	8" PVC	SOUTH
		5.35'	10" PVC	WEST
CB "P"	9.23'	N/A	N/A	BAFFLE (SOUTH)
05 "0"	0.043	4.55'	15" RCP	SOUTH
CB "Q"	9.21'	N/A	N/A	BAFFLE (NORTH)
CB "R"	8.96'	5.20'		NORTH
		5.03'		SOUTH
CB "S"	8.99'	N/A		BAFFLE (WEST)
CB "T"	9.84'	N/A		BAFFLE (EAST)
CB "U"	9.98'	N/A		BAFFLE (EAST)
UD U	3.30			
CB "V"	9.16'	3.94'		15" RCP
		N/A		BAFFLE (WEST)
DMH "A"	10.09'	N/A	N/A	BAFFLE (NORTHEAST)
	10.03	N/A	N/A	BAFFLE (SOUTHEAST)
CB "W"	9.46'	N/A	N/A	BAFFLE (NORTHWEST)
		N/A	N/A	BAFFLE (SOUTHWEST)
CB "X"	9.48'	•	·	` ` ` ` ` ` ` ` ` ` ` ` ` ` ` ` ` ` ` `
CB "X"	9.40	N/A	N/A	BAFFLE (NORTHEAST)

CB	Y	8.56	N/A		
GEND					·
A/C	AIR CONDI	TIONER		L	ARC LENGTH
B.C.R.	BROWARD	COUNTY RECORDS		LB	LICENSED BUSINESS
BFP	BACK FLO	W PREVENTER		MHD	MANHOLE DRAINAGE
ALF	ALUMINUM	FENCE		MHS	MANHOLE SANITARY
BR	BIKE RACK	<		MF	METAL FENCE
СВ	CATCH BAS	SIN		N/A	NOT AVAILABLE
CBS	CONCRETE	BLOCK STUCCO		N/D	NAIL AND DISK
СМВ	CITY OF M	IIAMI BEACH		NAVD 88	NORTH AMERICAN VER
CINL	CURB INLE	ΞT		NGVD 29	NATIONAL GEODETIC VE
CLF	CHAIN LINE	K FENCE		N/D	NAIL AND DISC
CONC.	CONCRETE			O.R.B	OFFICIAL RECORDS BO
CMP	CORRUGAT	ED METAL PIPE		PIV	POST INDICATOR VALVE
CO	CLEANOUT			P.B.	PLAT BOOK
DMH	DRAINAGE	MANHOLE		PG.	PAGE
DCV	DETECTOR	CHECK VALVE		P.S.M.	PROFESSIONAL SURVEY
DWS	DETECTABL	E WARNING SURFACE		R	RADIUS
EB	ELECTRIC	BOX		R/W	RIGHT-OF-WAY
EO	ELECTRICAL	L OUTLET		SIA	SIAMESE CONNECTOR
ELEV.	ELEVATION			SIRC	SET IRON ROD & CAP
EPB	ELECTRIC	PANEL BOX		SND	SET NAIL AND DISK
FC	FIRE CONN			тов	TOP OF BANK
F.F.	FINISHED F			TOS	TOE OF SLOPE
FIR	FOUND IRC				
FIRC		ON ROD AND CAP		TYP.	TYPICAL
FND		IL AND DISK		USC+GS	UNITED COAST AND GE
F.D.O.T		EPARTMENT OF TRANSPORT	ATION	UNK.	UNKNOWN
FPL		OWER & LIGHT		UTD	UNABLE TO DETERMINE
GR	GUARD RA			VLT	VAULT
GT	GREASE TE			WPB	WIRING PULL BOX
GYA	GUY WIRE			WV	WATER VALVE
HED		IE (TYPICAL)		WF	WOOD FENCE
ICB	IRRIGATION	CONTROL BOX		w/	WITH

тн		
BUSINESS		
DRAINAGE		
SANITARY		
ICE		
ABLE		
DISK		
EDICANI MEDTICAL DATUM		

SYMBOLS:

 $\bigoplus_{i \in \mathcal{I}} \mathcal{I}_i$

BACK FLOW PREVENTER

CONCRETE LIGHT POLE (SQUARE)

DETECTABLE WARNING SURFACE

CONCRETE POLE (SQUARE)

DRAINAGE MANHOLE

ELECTRIC BOX

FIRE HYDRANT

GUY ANCHOR

HEDGE

HANDICAP PARKING

IRRIGATION VALVE

MAIL BOX

IRRIGATION CONTROL BOX

METAL LIGHT POLE (ROUND)

METAL LIGHT POLE (SQUARE)

METAL POWER POLE (SQUARE) METAL POWER POLE (ROUND)

BREAST HEIGHT IN INCHES)

SIAMESE CONNECTION

SANITARY MANHOLE

PALM TREE (TREE SIZE NOTED AT

ELECTRIC METER

BOLLARD

CATCH BASIN

CENTER LINE

CLEANOUT


DELTA

RTICAL DATUM OF 1988 VERTICAL DATUM OF 1929

EYOR AND MAPPER

GEODETIC SURVEY

ID IDENTIFICATION IR IRON ROD K&S KEITH & SCHNARS

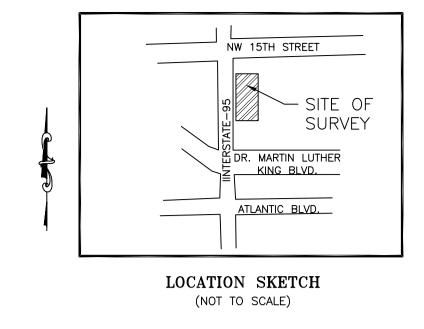

LEGAL DESCRIPTION:

A PARCEL OF LAND LYING IN SECTIONS 34 AND 35, TOWNSHIP 48 SOUTH, RANGE 42 EAST, BROWARD COUNTY, FLORIDA. SAID PARCEL BEING MORE PARTICULARLY DESCRIBED AS FOLLOWS:

COMMENCING AT THE WEST QUARTER CORNER OF SECTION 35, TOWNSHIP 48 SOUTH, RANGE 42 EAST, BROWARD COUNTY, FLORIDA; THENCE NORTH 01°27'17" WEST, ALONG THE WEST LINE OF SAID SECTION 35, A DISTANCE OF 30.00 FEET TO THE POINT OF BEGINNING; THENCE SOUTH 89°26'48" WEST, A DISTANCE OF 270.13 FEET TO A POINT ON THE EAST RIGHT OF WAY OF I-95; THENCE NORTH 00°50'09" WEST, ALONG SAID EAST RIGHT OF WAY LINE, A DISTANCE OF 545.29 FEET; THENCE NORTH 01°34'27" EAST, ALONG SAID EAST RIGHT OF WAY LINE, A DISTANCE OF 700.79 FEET: THENCE NORTH 00°51'43" WEST, ALONG SAID EAST RIGHT OF WAY LINE, A DISTANCE OF 211.12 FEET TO A POINT ON THE SOUTH RIGHT OF WAY OF THE F.E.C. RAILROAD; THENCE NORTH 88°47'09" EAST, ALONG SAID SOUTH RIGHT OF WAY LINE, A DISTANCE OF 225.00 FEET; THENCE NORTH 88°13'09" EAST ALONG SAID SOUTH RIGHT OF WAY LINE, A DISTANCE OF 333.41 FEET: THENCE SOUTH 01°26'39" EAST, A DISTANCE OF 797.03 FEET TO A POINT ON THE NORTH LINE OF A 50 FOOT RIGHT OF WAY (N.W. 10 th STREET); THENCE SOUTH 88°02'09" WEST, ALONG SAID NORTH RIGHT OF WAY LINE, A DISTANCE OF 229.97 FEET TO A POINT ON THE WEST LINE OF A 50 FOOT RIGHT OF WAY (N.W. 9th AVENUE) AS SHOWN ON "ANNIE LAURIE COURTS", ACCORDING TO THE PLAT THEREOF AS RECORDED IN PLAT BOOK 72, PAGE 13 OF THE PUBLIC RECORDS OF BROWARD COUNTY, FLORIDA; THENCE SOUTH 01°26'25" EAST, ALONG SAID WEST RIGHT OF WAY LINE, A DISTANCE OF 445.00 FEET TO A POINT OF CURVATURE OF A TANGENT CURVE CONCAVE TO THE EAST HAVING A RADIUS OF 312.80 FEET; THENCE CONTINUE ALONG SAID WEST RIGHT OF WAY LINE THROUGH A CENTRAL ANGLE OF 19°38'27". AN ARC DISTANCE OF 107.23 FEET TO A POINT OF REVERSE CURVATURE OF A TANGENT CURVE CONCAVE TO THE WEST HAVING A RADIUS OF 262.80 FEET: THENCE CONTINUE ALONG SAID WEST RIGHT OF WAY LINE, THROUGH A CENTRAL ANGLE OF 19°05'32", AN ARC DISTANCE OF 87.57 FEET TO A POINT OF COMPOUND CURVATURE OF A TANGENT CURVE CONCAVE TO THE

HAVING A RADIUS OF 25.00 FEET; THENCE CONTINUE ALONG SAID WEST RIGHT OF WAY LINE. THROUGH A CENTRAL ANGLE OF 90°00'00", AN ARC DISTANCE OF 39.27 FEET TO A POINT ON THE NORTH LINE OF A 60 FOOT RIGHT OF WAY (N.W. 8th STREET); THENCE SOUTH 87°58'16" WEST, A DISTANCE OF 112.00' TO THE POINT OF BEGINNING.

SAID LANDS LYING IN THE CITY OF POMPANO BEACH, BROWARD COUNTY, FLORIDA, CONTAINING 703,704 SQUARE FEET (16.2 ACRES) MORE OR LESS.

LINE TYPE

____ x ___ CHAIN LINK FENCE

GUARDRAIL

____ _ RIGHT OF WAY

_____TOB_____ TOP OF BANK

_____TOS_____ TOP OF SLOPE

____ - _ _ CENTER LINE

_____ D ____ UNDERGROUND DRAINAGE LINE

— E—— E— UNDERGROUND ELECTRIC LINE

--- IRR --- UNDERGROUND IRRIGATION LINE

----- s ----- UNDERGROUND SANITARY LINE

-----UNKNOWN UNDERGROUND LINE

SIGN POST

STAND PIPE

TRASH CAN

BREAST HEIGHT)

WATER METER

WATER VALVE

TREE (GUM-GUMBO) CAB (CABBAGE

WOOD LIGHT POLE (ROUND)

WOOD POWER POLE (ROUND)

PALM) (TREE SIZE NOTED IN INCHES AT

INDICATES APPROXIMATE DIRECTION. DOES NOT INDICATE TERMINOUS POINT


SURVEY NOT VALID WITHOUT SHEETS 2 & 3 BY: BENJAMIN B. HOYLE, P.S.M. FLORIDA REGISTRATION NO. 6769


SURVEYOR'S AND NOTES:

- 2. THIS ITEM HAS BEEN OFFICIALLY SIGNED AND SEALED BY BENJAMIN B. HOYLE ON THE DATE ADJACENT TO THE SEAL. PRINTED COPIES OF THIS DOCUMENT ARE NOT CONSIDERED SIGNED AND SEALED AND THE SIGNATURE MUST BE VERIFIED ON ANY ELECTRONIC COPIES.LANDS SHOWN HEREON WERE NOT ABSTRACTED FOR RIGHTS-OF-WAY, EASEMENTS, RESTRICTIONS, COVENANTS, OWNERSHIP, OR OTHER INSTRUMENTS OF
- 3. BEARINGS SHOWN HEREON ARE ON AN ASSUMED DATUM, WITH A REFERENCE BEARING OF SOUTH 89'26'48" WEST ALONG THE NORTH RIGHT OF WAY LINE OF NW 8TH STREET.
- 4. ADDITIONS AND/OR DELETIONS OF THIS SURVEY MAP, BY OTHER THAN THE SIGNING PARTY OR PARTIES IS PROHIBITED WITHOUT WRITTEN CONSENT OF THE SIGNING PARTY OR PARTIES,
- 5. THE "LAND DESCRIPTION" SHOWN HEREON WAS PROVIDED BY THE CLIENT.
- 6. UNDERGROUND FOUNDATIONS WERE NOT LOCATED OR SHOWN HEREON.
- 7. UNDERGROUND ENCROACHMENTS WERE NOT LOCATED OR SHOWN HEREON. 8. THERE IS NO EVIDENCE THAT UNDERGROUND ENCROACHMENTS EXIST: HOWEVER, NO SUBSURFACE
- INVESTIGATION WAS PERFORMED TO DETERMINE IF UNDERGROUND ENCROACHMENTS ARE PRESENT. 9. THIS SURVEY DOES NOT IDENTIFY THE LIMITS OR EXTENT OF POTENTIAL JURISDICTIONAL BOUNDARIES.
- 10. DISTANCES AND ELEVATIONS SHOWN HEREON ARE IN U.S. SURVEY FEET AND DECIMAL PORTIONS THEREOF, UNLESS SHOWN OTHERWISE.
- 11. THE EXPECTED HORIZONTAL ACCURACY OF THE FEATURES SHOWN HEREON IS ± 0.2 ' FOR THE LIMITS OF HARD SURFACES, SUCH AS ASPHALT, CONCRETE, CURBING, BUILDINGS, ETC. AND IS ±0.3' FOR GROUND SURFACE FEATURES, SUCH AS SURFACE FEATURES OF UTILITIES, ETC. AND IS ±0.4' FOR FEATURES PROTRUDING OUT OF THE GROUND, SUCH AS UTILITY POLES, FENCES, TREES, ETC.
- 12. OVERHEAD WIRES SHOWN HEREON ARE FOR DIRECTIONAL AND CONNECTIVITY PURPOSES ONLY AND DO NOT DEPICT THE ACTUAL LOCATION.
- 13. UNDERGROUND UTILITY LINES SHOWN HEREON WERE DESIGNATED ON THE GROUND BY BLOOD HOUND UNDERGROUND UTILITY LOCATORS ON 6/18/2019, AND ARE APPROXIMATE IN LOCATION. UNDERGROUND UTILITIES SHOULD BE FIELD VERIFIED PRIOR TO ANY CONSTRUCTION ACTIVITIES.
- 14. THE SYMBOLS SHOWN IN THE LEGEND AND ON THIS MAP MAY HAVE BEEN ENLARGED OR REDUCED FOR CLARITY, AND MAY NOT DEPICT THE ACTUAL SIZE OR SHAPE OF THE FEATURES. THE EXPECTED HORIZONTAL ACCURACY OF THE SYMBOLS SHOWN ON THIS MAP IS ±0.3' FROM THE CENTER OF THE SYMBOL, UNLESS OTHERWISE NOTED.
- 15. ELEVATIONS SHOWN HEREON ARE RELATIVE NORTH AMERICAN VERTICAL DATUM OF 1988 AND SAID ELEVATIONS ARE BASED ON BENCHMARKS SUPPLIED BY U.S.C. AND G.S. BENCHMARK # 0-22. A BRASS DISK AFFIXED ABOUT 8.5 MILES SOUTH-SOUTHWEST OF BOCA RATON, 6.2 MILES SOUTHEAST OF WEST DIXIE BEND, 1.0 MILES WEST-NORTHWEST OF POMPANO BEACH, IN SECTION 34, TOWNSHIP 48 SOUTH, RANGE 42 EAST. OWNERSHIP IS BROWARD COUNTY TRANSPORTATION DEPARTMENT TO REACH THE MARK FROM THE INTERSECTION OF WEST ATLANTIC BOULEVARD AND GO FOR 1 MILE TO THE JUNCTION OF NORTHWEST 15TH STREET ON THE LEFT, TURN LEFT ON NORTHWEST 15TH STREET AND GO WEST FOR 1.1 MILES TO THE MARK ON THE RIGHT, SET IN THE TOP OF A 10 INCH ROUND CONCRETE MONUMENT RECESSED 0.2 FEET BELOW THE GROUND AND 0.5 FEET BELOW THE LEVEL OF NORTHWEST 15TH STREET WITH AN ELEVATION OF 11.97 FEET (NAVD88). TO CONVERT FROM NAVD88 TO NGVD 29 ADD 1.575 FEET.
- 16. THE EXPECTED VERTICAL ACCURACY OF THE FEATURES SHOWN HEREON IS $[\pm 0.05]$ FOR HARD SURFACES, SUCH AS ASPHALT, CONCRETE, ETC. AND $[\pm 0.1]'$ / ± 0.3] FOR SOFT SURFACES, SUCH AS GRASS, DIRT, MUD, ETC.

PROPERTY IS DEPICTED TO THE BEST OF MY KNOWLEDGE, BELIEF, AND INFORMATION AS PREPARED UNDER MY DIRECTION ON JUNE 20, 2019. I FURTHER CERTIFY THAT THIS BOUNDARY AND TOPOGRAPHIC SURVEY MEETS THE STANDARDS OF PRACTICE SET FORTH BY THE FLORIDA BOARD OF PROFESSIONAL SURVEYORS AND MAPPERS IN CHAPTER 5J-17, FLORIDA ADMINISTRATIVE CODE, PURSUANT TO SECTION 472.027, FLORIDA STATUTES, SUBJECT TO THE QUALIFICATIONS NOTED HEREON.

> Digitally signed by Benjamin B. B. Hoyle Date: 2020.06.0416:00:47-04'00'

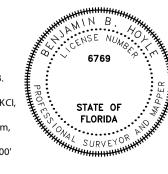

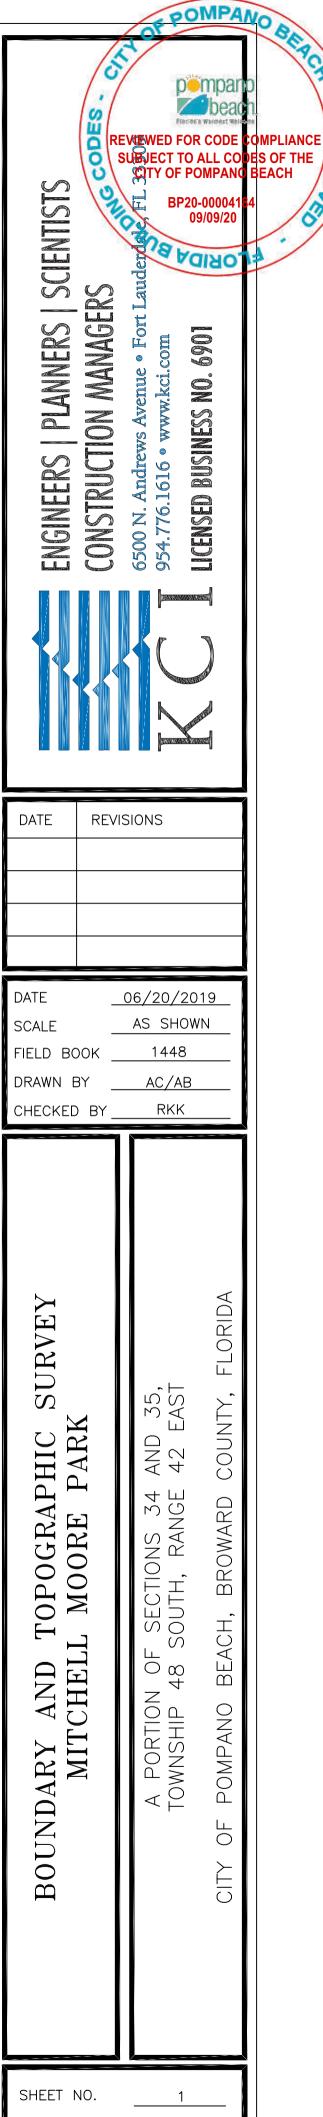

SHEETS

PROJECT NO.

511903570.00

CERTIFICATE:

I HEREBY CERTIFY THAT THE ATTACHED BOUNDARY AND TOPOGRAPHIC SURVEY OF THE HEREON DESCRIBED

KCI TECHNOLOGIES ENGINEERS, SURVEYORS AND PLANNERS

BY: BENJAMIN B. HOYLE, P.S.M.

