



LED ShoesBox Liget



60W-150W

180W-300W



TECHNICAL SPECIFICATIONS

Wattage	Input Voltage	Lumens	Size (L*W*H)	Net Weight
60W	AC100-240/100-277V	8000-8700LM	20.7" x 12.6" x 2.9"	6.4KG
90W	AC100-240/100-277V	12000-13000LM	20.7" x 12.6" x 2.9"	6.7KG
120W	AC100-240/100-277V	15000-16000LM	20.7" x 12.6" x 2.9"	6.7KG
150W	AC100-240/100-277V	18000-19000LM	20.7" x 12.6" x 2.9"	6.9KG
150W-HV	AC100-240/100-277V	18000-19000LM	20.7" x 12.6" x 2.9"	6.8KG
150W	AC100-240/100-277V	17500-18500LM	20.7" x 12.6" x 2.9"	7.0KG
180W	AC100-240/100-277V	20500-21500LM	30.7" x 13.4" x 3.4"	9.8KG
240W	AC100-240/100-277V	27000-28000LM	30.7" x 13.4" x 3.4"	9.8KG
300W	AC100-240/100-277V	40000-42000LM	30.7" x 13.4" x 3.4"	10.8KG

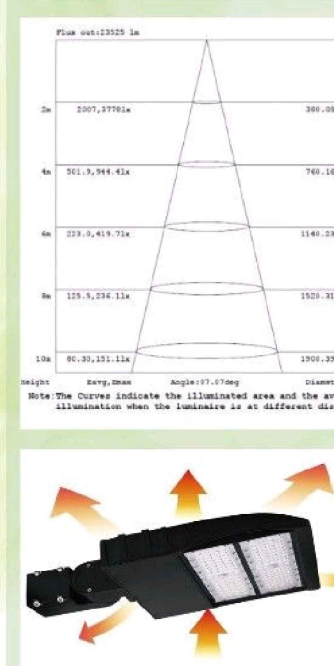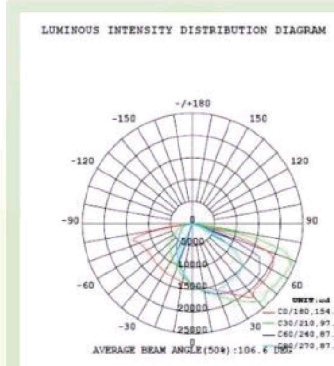


SNC OPTO ELECTRONIC CO.,LTD


Tel:+86-755-29683009
Fax:+86-755-29684853
www.snc-lighting.com
E-mail:sales@snc-led.com

Address: Building 21, Zhongdaan
Industry Park, No.172, Xiangshan
Road, Luotian Village, Songshan
Town, Baoao District, Shenzhen,
Guangdong, China

DIRECT MOUNT 12" FULL CUTOFF WALL PACK

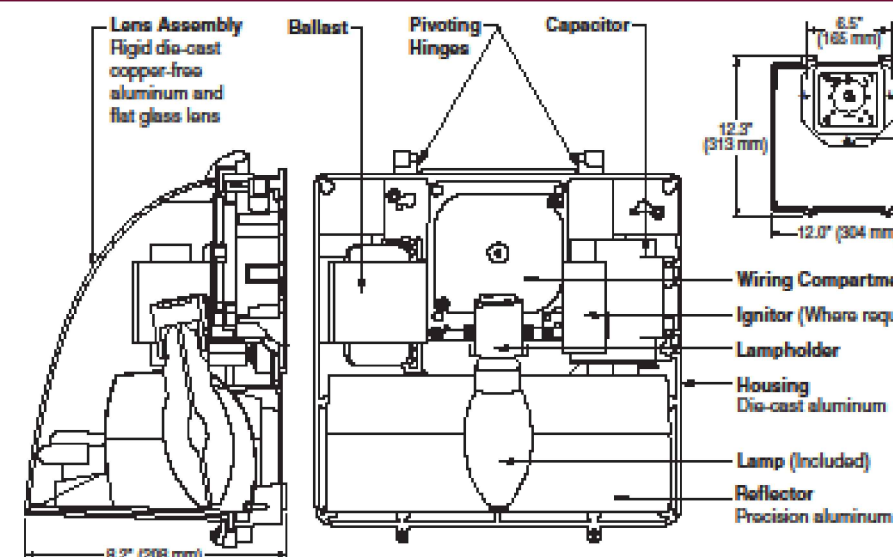

QWCO-12 SERIES

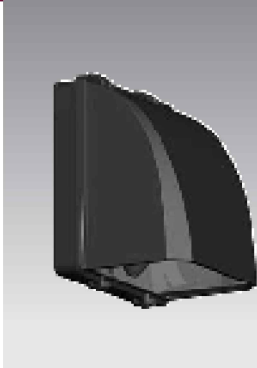

SPEC #	WATTAGE	CATALOG #
1	50W PSMH	MGWC0405-(a)(b)
2	70W PSMH	MGWC0407-(a)(b)
3	100W PSMH	MGWC0410-(a)(b)
4	150W PSMH	MGWC0615-(a)(b)
5	HIGH PRESSURE SODIUM	
6	50W HPS	MGWC0505-(a)(b)
7	70W HPS	MGWC0507-(a)(b)
8	100W HPS	MGWC0510-(a)(b)
9	150W HPS	MGWC0515-(a)(b)

Specify (a) Voltage & (b) Options.

GENERAL DESCRIPTION

Full Cutoff Wall Pack fixture for HID lamp, totally enclosed. Housing is seamless copper-free die-cast aluminum. Lens assembly consists of a hinged, rigid die-cast copper-free aluminum frame and clear borosilicate glass lens held securely inside. Lens frame is easily removable and allows for easy attachment and serviceability using top pivoting hinge. Complete silicone gasketing around lens and gasketing at mounting provide a watertight seal. A precision specular aluminum reflector provides forward throw with wide distribution to ensure wide fixture spacings and maximum light levels. Fixture design provides excellent IES Full Cutoff light distribution without glare. The optical chamber is sealed to reduce dirt and insect contamination. Furnished with E-coated, copper-free, lightweight mounting box designed for installation over standard 4-inch square or octagonal and single-gang J boxes and for conduit entry from top, sides and rear. Designed and approved for easy through-wiring. All fixtures use vertical-lamp position.

ELECTRICAL

Fixture includes clear, medium-base lamp. Pulse-rated porcelain enclosed, 4kv-rated screw-shell type lampholder. Lamp gasket included where required. Fixtures require a minimum 90°C temperature feed wire. All ballast assemblies are high-power factor and use the following circuit types:

120V Reactor

50 - 150W HPS

277V Reactor

150W PSMH

HX - High Reactance

50 - 150W PSMH; 50 - 150W HPS

LABELS

ANSI lamp wattage label supplied, visible during re-lamping. UL Listed in the US and Canada for wet locations.

(c) VOLTAGE SUFFIX KEY
0 120/277V (Standard 50W HPS)
1 120/208/240/277V (Standard PSMH; 70 - 150W HPS)
T 120/277/240V (Canada Only) (Standard PSMH; 70 - 150W HPS)
1 120V
2 277V
27 277V Reactor (150W PSMH Only)
5 240V
4 240V
5 480V (70 - 150W PSMH; 70 - 150W HPS)
6 347V (Canada Only)

Specify (a) Single Voltage - See Voltage Suffix Key

FINISH

Exclusive Colorfast DeltaGuard® finish features an E-coat epoxy primer with medium bronze ultra-durable powder topcoat, providing excellent resistance to corrosion, ultraviolet degradation and abrasion. The finish is covered by our seven-year limited warranty.

PATENTS

6,867,959; 7,354,177; D577,146; Patents Pending.

PHOTOMETRICS NOTES

☼ DENOTES FOOT CANDLE DESIGN PROJECTIONS THIS INSTALLATION AS WOULD READ WITH LIGHT METER ON A MOONLESS NIGHT

ALL LIGHT FIXTURES 400W METAL HALIDE ON 14' HIGH CONCRETE POLE OR BUILDING MOUNTED UNDER OVERHANG, DOWN FACING


SHADE ☼

☼ DENOTES POLE WITH LIGHT FIXTURE AND SHADE ATTACHMENT

☼ DENOTES BUILDING MOUNTED DOWN FACING LIGHT FIXTURE

☼☼ DENOTES BUILDING SIDE MOUNTED LIGHT FIXTURE WITH SHADE ATTACHMENT MOUNTED 4 FEET ABOVE GRADE

Luminaire Schedule					
Project: Project_1					
Symbol	Qty	Label	Arrangement	Lumens	LLF
☼	1	SA	SINGLE	40000	0.75
☼	13	SC	SINGLE	20500	0.75
Numeric Summary					
Project: Project_1					
Label	Avg	Max	Min	Avg/Min	Max/Min
ENTRY AREA	8.68	12.7	0.5	5.36	12.7
VEHICULAR COURT	5.43	14.5	0.5	4.86	14.5
BORDER SITE BOUNDARIES	0.16	0.6	0.0	0	0

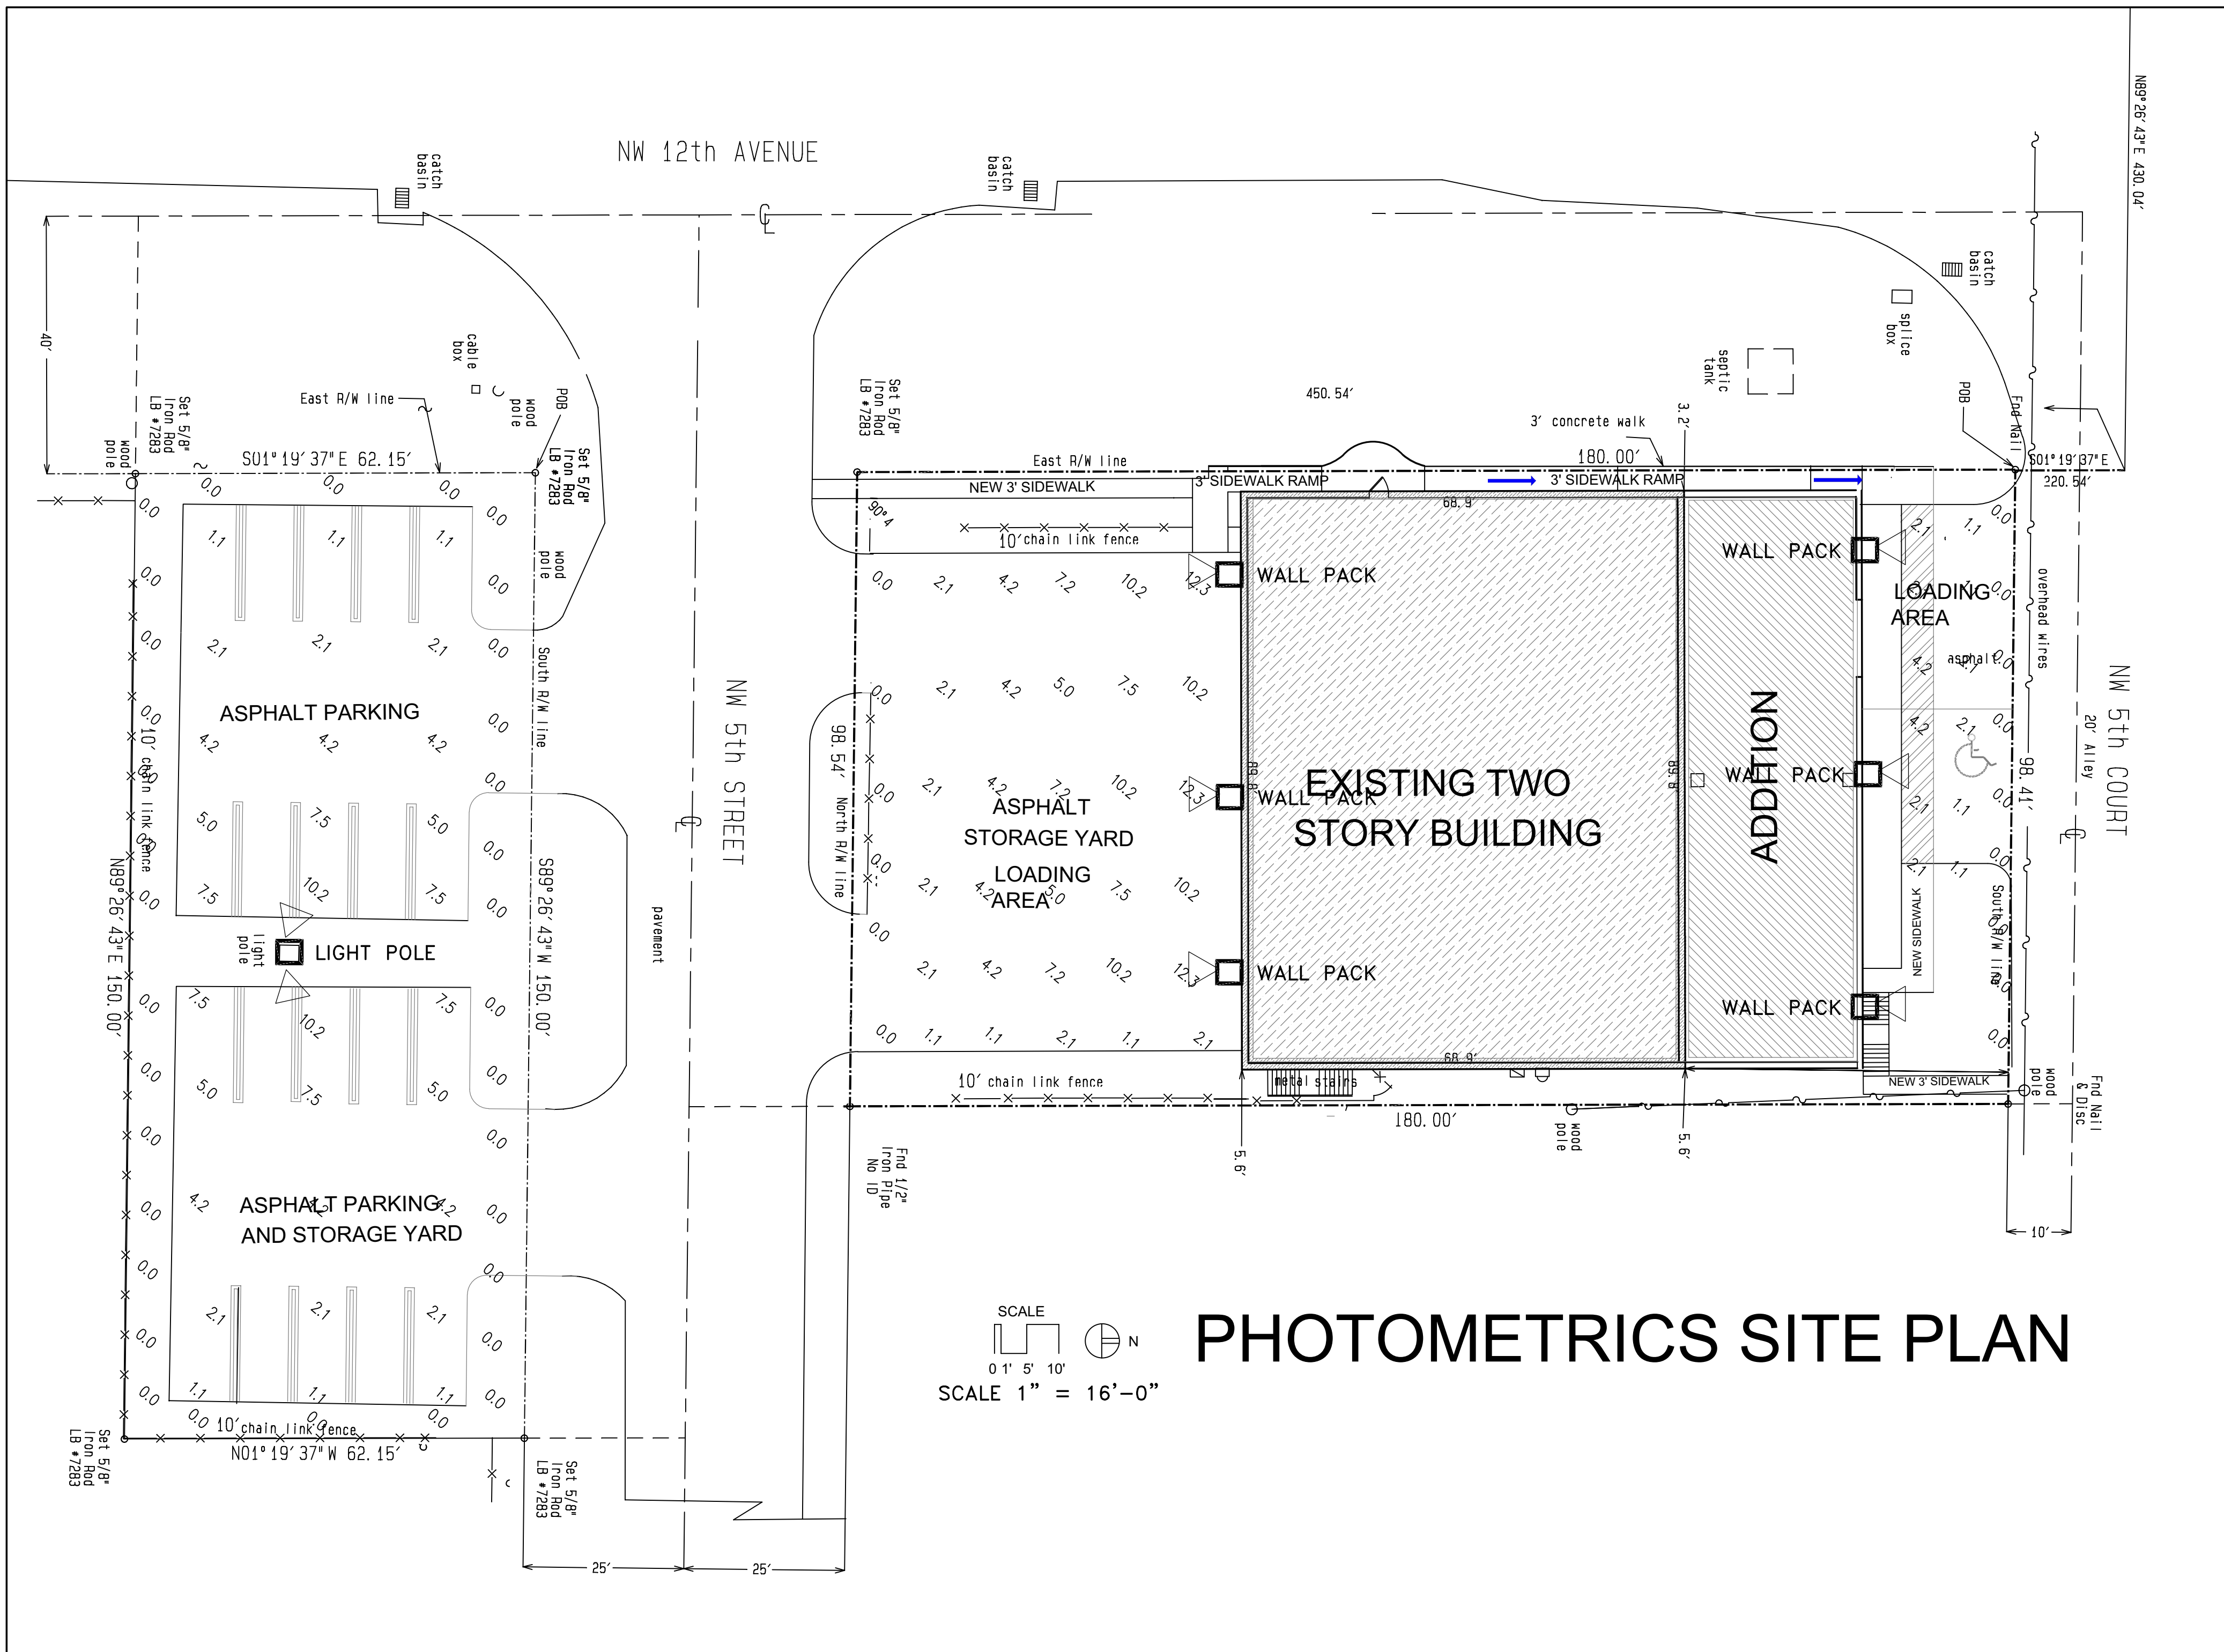


PHOTOMETRICS SITE PLAN

SCALE 1" = 16'-0"

© 2011 Road Lighting, Inc. - A Cree Company. All rights reserved. The information in this document is subject to change without notice.

8201 Washington Avenue • Racine, Wisconsin 53406-3772 • PHONE: (800) 236-7000 • FAX: (800) 236-7000 • WEB: www.roadlightingdirect.com

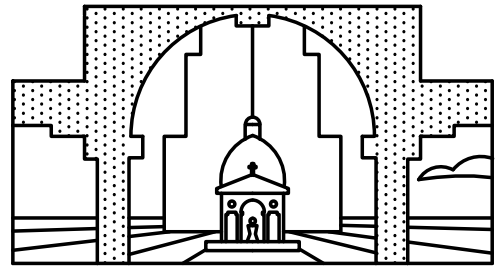

JAIME PLANA / LICENSE AR 9769

Jaime M. Plana
INTERNATIONAL CONSULTANTS, LLC
Architecture & Planning

1053 S.W. 12th Street
Boca Raton, Florida 33486
(561) 447-9344 / 827-5841

APPROVED	J.M. PLANA
DESIGNED	J.M. PLANA
DRAWN	S. PEREZ

REVISIONS

©COPYRIGHT 2024 JAIME M. PLANA
ARCHITECT, ALL RIGHTS RESERVED
NONE OF THE DESIGNS, DRAWINGS,
CALCULATIONS AND/OR DEPICTIONS
MAY BE REPRODUCED IN WHOLE OR
IN PART WITHOUT THE EXPRESS
WRITTEN AUTHORIZATION OF
JAIME M. PLANA, ARCHITECT

PROJECT

SITE PLAN

FOR EXISTING

STORAGE FACILITY

FOR

THERMOSET ROOFING CORP.

located at

500 NW 12 Street
Pompano Beach, FL.

SHEET CONTENTS

PHOTOMETRIC

SITE PLAN

ISSUED FOR

- REVIEW & COMMENTS
- BIDDING
- NOT FOR CONSTRUCTION
- PERMIT
- CONSTRUCTION

ISSUE DATE: 09 APR 24

PROJECT NUMBER: 24TS-SP-0

SHEET NUMBER: 1

DRC
PZ24-12000009
5/15/2024