

CONSOLIDATED USE TABLE P = PERMITTED PRINCIPAL USE S = USE ALLOWED AS A SPECIAL EXCEPTION A = PERMITTED ACCESSORY USE T = PERMITTED TEMPORARY USE Use Type Use-Specific Standards 155.4202.A Household Living Uses Dwelling, live/work Dwelling, multifamily 155.4202.C 155. 4202. G Dwelling, mixed-use Communication Uses elecommunications facility, collo-155. 4204. C cated on existing structure other 155. 4204. D than telecommunications tower P/A Child Care Facility 155. 4206. B HARBORSIDE AT HIDDEN HARBOUR Health Care Uses Medical office 155. 4209. A Specialty medical facility 155. 4209. B 155. 4209. C Urgent care facility 24 hours P/A 155. 4210. D Open Space Uses Park or plaza 155. 4214. A Animal Care Uses Animal grooming Pet shop 155. 4214. E Boat and Marine Sales and Boat dry storage facility P/A 155. 4215. B P/A 155. 4215. C Boat or marine parts sales without Boat or marine parts sales with 155. 4215. D Boat or marine repair and servicing 155. 4215. E P/A P/A 155. 4215. F Boat sales or rental Boat towing service 155. 4215. G 155. 4215. H Docking facility, barge Docking facility, commercial fishing P/A 155. 4215. I P/A 155. 4215. J Docking facility, recreational boat 155. 4215. K Yacht Club 155. 4215. L 155. 4217. M Commercial or Membership Other indoor commercial or mem-P/A Recreation/ Entertainment bership recreation/ entertainment BEATRIZ M. HERNANDEZ AR0094576 Eating and Drinking Estab- Bar or lounge P/A 155. 4218. A P/A 155. 4218. B P/A 155. 4218. E Specialty eating or drinking estab-155. 4218. F 155. 4220. B Professional office Bank or financial institution 155. 4221. C Retail Sales and Service Uses - Personal Services 155. 4221. K Personal services establishment 155. 4222. D Book or media shop Grocery or convenience store 155. 4222. F 155. 4222. G Drug store or pharmacy 155. 4222. H Farmers' market 155. 4222. M Beer or wine store 155. 4222. P Retail sales establishment, large Other retail sales establishment 155. 4222. R Visitor Accommodation Condo hotel 155. 4225. A Bed and breakfast inn 155. 4225. B 155. 4225. C Hotel or motel Typical Accessory Uses 155. 4303. H Drop-in child care Α 155. 4303. J Electric vehicle (EV) level 1, 2, or 3 Α 155. 4303. K / charging station 155. 4303. L 155. 4303. O Fence or wall Green roof 155. 4303. R Home based business Α 155. 4303. S 155. 4303. U Outdoor display of merchandise 155. 4303. V Outdoor seating, including sidewalk cafes (as accessory to eating and drinking establishments) 155. 4303. X Parking or storage of motor vehicles, recreational vehicles, boats, airboats, or trailers 155. 4303. Z Rainwater cistern or barrel Retail sales (as accessory uses) 155. 4303. BB 155. 4303. DD Small wind energy system 155. 4303. EE Solar energy collection system -/-/-AS SHOWN 155.4303. GG Swimming pool or spa or hot tub 155. 4303. JJ Mechanical Equipment and similar SHEET TITLE: 155.4303. KK Uncovered porches, decks, patios, terraces, or walkways 155.4303. MM Lighting fixtures, projecting or freestanding EET 1 Eating and drinking establishments 155.4303.PP (as an accessory use) 155. 4403. A Farmer's market (as a temporary

TABLEI		
LAND USE PLAN LIMITS		
Area 1	Marina Use (including boat storage, boat repair, and slips): 75,000 square feet and 15 wet slips	
Area 2	Private Park (Open to Public) / Parking	
Area 3	Multi-Family Residential: 300 units Commercial Development (including, but not limited to, boat sales, offices, showrooms, and related uses): 510,000 square feet	

TABLE II			
	Type and Mix of Uses		
Residential	Up to 300 Units Max.		
Commercial	Minimum of 65,000 square feet, including a minimum of 10,000 square feet of commercial uses vertically integrated in a mixed-use building fronting on Federal Highway		
Total Floor Area	Maximum of 650,000 square feet		

Intensity and Dimensional Standards			
i. Land area (acres)			
Gross Acres (to CL of ROW - to calc. for density)	9.96 Acres		
Gross Acres (including basin for park)	6.90 Acres		
Estimated Net Acres (upland area that excludes basin)	6.5 Acres		
ii. Type and mix of land uses*		<u> </u>	
Multi-Family Residential	300 Units max.		
Commercial Development (Including but not limited to: Boat sale, showrooms and related uses	10,000 to 510,00	10,000 to 510,000 SQ.FT.	
Marine Use (Including: Boat storage, boat repair and slips)	10,000 to 75,000	O SQ. FT./15 Slips	
*Refer to table III for list of additional approved Type of Uses	•	-	
iii. Maximum number of residential units/ Unit Square Footage Size (SF)	300 du's max		
	min	max	
1 Bedroom (multi-family)	580 SQFT	800 SF	
2 Bedroom (multi-family)	850 SQFT	1175 SF	
3 Bedroom (multi-family)	1,180 SQFT	1,350 SF	
iv. Maximum Commercial -Nonresidential floor area* (Exclusive of Garage)	510, 000 SQ.FT.		
Maximum Marina	75,000 SQ. FT., 15 Slips		
Minority/ Marina Use	Min. of 10% of to	tal floor area	
*Min. 10,000 SQ. FT. of Commercial Use to be vertically integrated in	into mixed use buildi	ing	
v. Minimum Lot Area	10,000 SQ. FT.		
vi. Minimum Lot Width	100 FT. FRONTAGE		
vii. Minimum Pervious (Calc. based on Net Acres)	20% (1.27 Acres)		
viii. Maximum Impervious area (Calc. based on Net Acres)	80% (5.23 Acres)		
ix Max. Building height	100 ft to 150 ft. Not to Exceed Airport Air Space Max. Height (See Exhibit K)		
x. Max. Individual building size	l		
Fronting Federal Highway (West of NE 23 rd Ave)	8 Stories Not to Exceed Airport Air Spac Max. Height Limits (See Exhibit K)		
	The state of the s) within first 50'-0" and of east property line / dential.	
Fronting NE 16 th ST (East of NE 23 rd Ave)	part manufacture promotes property in contrasted	s than 50'-0" of East Adjacent to residential.	
	8 Stories no less than 75'-0" of East Property Line / Adjacent to residential.		
Fronting NE 23 rd Ave (South of Caliban Canal)	Existing 1 Story [to remain	Dry Boat Storage Facility	

Intensity and Dimensional Standards ix. Setbacks North — Along North Property Lines	Min.	1,,		
ix. Setbacks North – Along North Property Lines	Min.			
North — Along North Property Lines		Max.		
Along NE 16th St.	7'-0"	63'-0"		
To 3 Story Garage	15'-0"	20'-0"		
East– Along East Property Lines				
To existing Dry Boat Storage facility	59'-0"	61'-O"		
Up to 3 Stories Residential	10'-0"	15'-0"		
Up to 6 Stories Residential	50'-0"	None		
Up to 8 Stories Residential	75'-0"	None		
Along 24th Terr to 3 Story Garage	12'-0"	20'-0"		
West-Along West Property Lines				
Along Federal Highway	5'-0"	30'-0"		
To 3 story Garage	10'-0"	20'-0"		
South Along South Property Lines				
To existing Dry Boat Storage Facility	91'-0"	95'-0"		
To 8 story Parking Garage	20'-0"	20'-0"		
Residential building to Face of bulkhead nose (Caliban Canal)	20'-0"	31'-O"		
Face of bulkhead nose to Property line	20'-0"	57'-0"		
To 3 story Garage	9'-0"	20'-0"		
East & West of N.E. 23Rd Ave	0'-0"	10'-0"		
Note: All Buildings' porches, stoops and balconies can project up whichever is less	to 7'-0" into setback	or up to ROW Line		
Additional Development Standards				
Access and Circulation	Standards as	As provided in Article 5: Development Standards as provided in Deviations/ Modifications Table V		

Additional Development Standards			
Access and Circulation	As provided in Article 5: Development Standards as provided in Deviations/ Modifications Table V		
Off-Street parking & loading	As provided in Master Parking Table VI		
Landscaping			
Tree Preservation	As provided in Article 5: Development		
Screening	Standards as provided in Deviations/		
Fences and Walls	Modifications Table V		
Exterior Lighting			
Commercial and mixed-use design	As provided in Article 5: Development Standards		
Sustainable Design	As provided in Section II.A.10 of PD-I Application		
Signage	As provided in Chapter 156. Sign Code		

Table VI				
Master Parking Plan				
Туре	Required	Required		
Dwelling, Multi-Family	1 BD	1 Space/ du		
	2 BD	2 Spaces/ du		
	3 BD	2 Spaces/ du		
Guest parking	10% of provided	10% of provided parking		
Handicap Parking	As provided in A	As provided in Article 5-ADA: 2% of total parking		
Restaurant	1 sp/ 4 seats	1 sp/ 4 seats		
Marine Showroom	1 sp / 500 sf	1 sp / 500 sf		
Marine Retail	1 sp/ 300 sf	1 sp/ 300 sf		
All other Uses as provided by in Table 155.5102.D.l: Minimum Number of Off-Street Parking spaces				
On street parallel parking stall size: 10'x26'				

TABLE V


Deviations/ Modifications

Туре	Code Section	ı	Description	Modification		Justification
Building Base Planting Standards	155.5203.e.3.a	Required shrubs shall be planted within three feet of the base of the building. If a street sidewalk is located between the base of the building and the street, required shrubs may be planted up to 15 feet from the base of the building.		planted within three feet of the base of the building. If a street sidewalk is located between the base of the building and the street, required shrubs may be		To accommodate Sidewalks abutting building.
Access, circulation, parking & loading Driving Aisle	155.5102.I.1	Required Aisle Width Dimensions 23'				To accommodate proposed site design and more efficient traffic circulation in garage.
Vehicle stacking	155.5101.G.8.B	Parking lot Entrance driveways		Min. 30 F stacking for 500 c off-street (as meas from RO	distance or more spaces sured	To accommodate proposed site design for vehicular access.
		For Units on 2 nd floor or higher of a building with non-residential use located on ground level: 1 space per Dwelling Unit (du)		None		Due to Urban
Dwelling, Multi- Family Parking	155.5102.D.I	1-2 BD	1.5 Space	1 BD	1 Space	Mixed-Use Settings parking demand shall be
		All other MF 3 BD	2 Spaces	2-3 BD Guest: 10		less.
Landscape between Vehicular Use Areas and Buildings	155.5203.D.5.A	Minimum landscaped area shall be eight feet for each story in the abutting building façade, up to 24 feet		Except w conflict w pedestrict sidewalk	vith an	To accommodate Sidewalks abutting building.
Required Buffer Types and Standards	155.5203.F3	Option 1: At Least 10' wide A wall or semi-opaque fence at least 6 feet high 1 Tree per 30 linear feet + a continuous hedge at least 4 feet high on the exterior side of the wall or fence 1 shrub per 10 linear feet on the interiror side of the wall or fence		Option 1: At Least A wall or opaque to least 6 feet high interior swall or feet	semi- fence at eet high lous least 4 on the ide of the	To accomodate proposed setbacks per Table IV Intensity and Dimensional Standards
Parking deck or Garage Standards	155.5605.c.1.d	The exposed top level of a parking structure shall be covered a minimum of 60% with a shade producing structure such as, but not limited to, a vined pergola or retractable canvas shade structure.		15% Min.		No Building shall be high enough to see top of garage.
Parking deck or Garage Standards	155.5605.c.3	If the deck or garage is accessed from a street, there shall be only one point of access to the garage area from that street.		Two (2) F Access	Points of	More Efficient Traffic Circulation for Residents and Commercial use respectively.

PD I MASTER PLAN



MAIOR SITE DIAN SURMITTAL N3/1 $\frac{1}{26}$

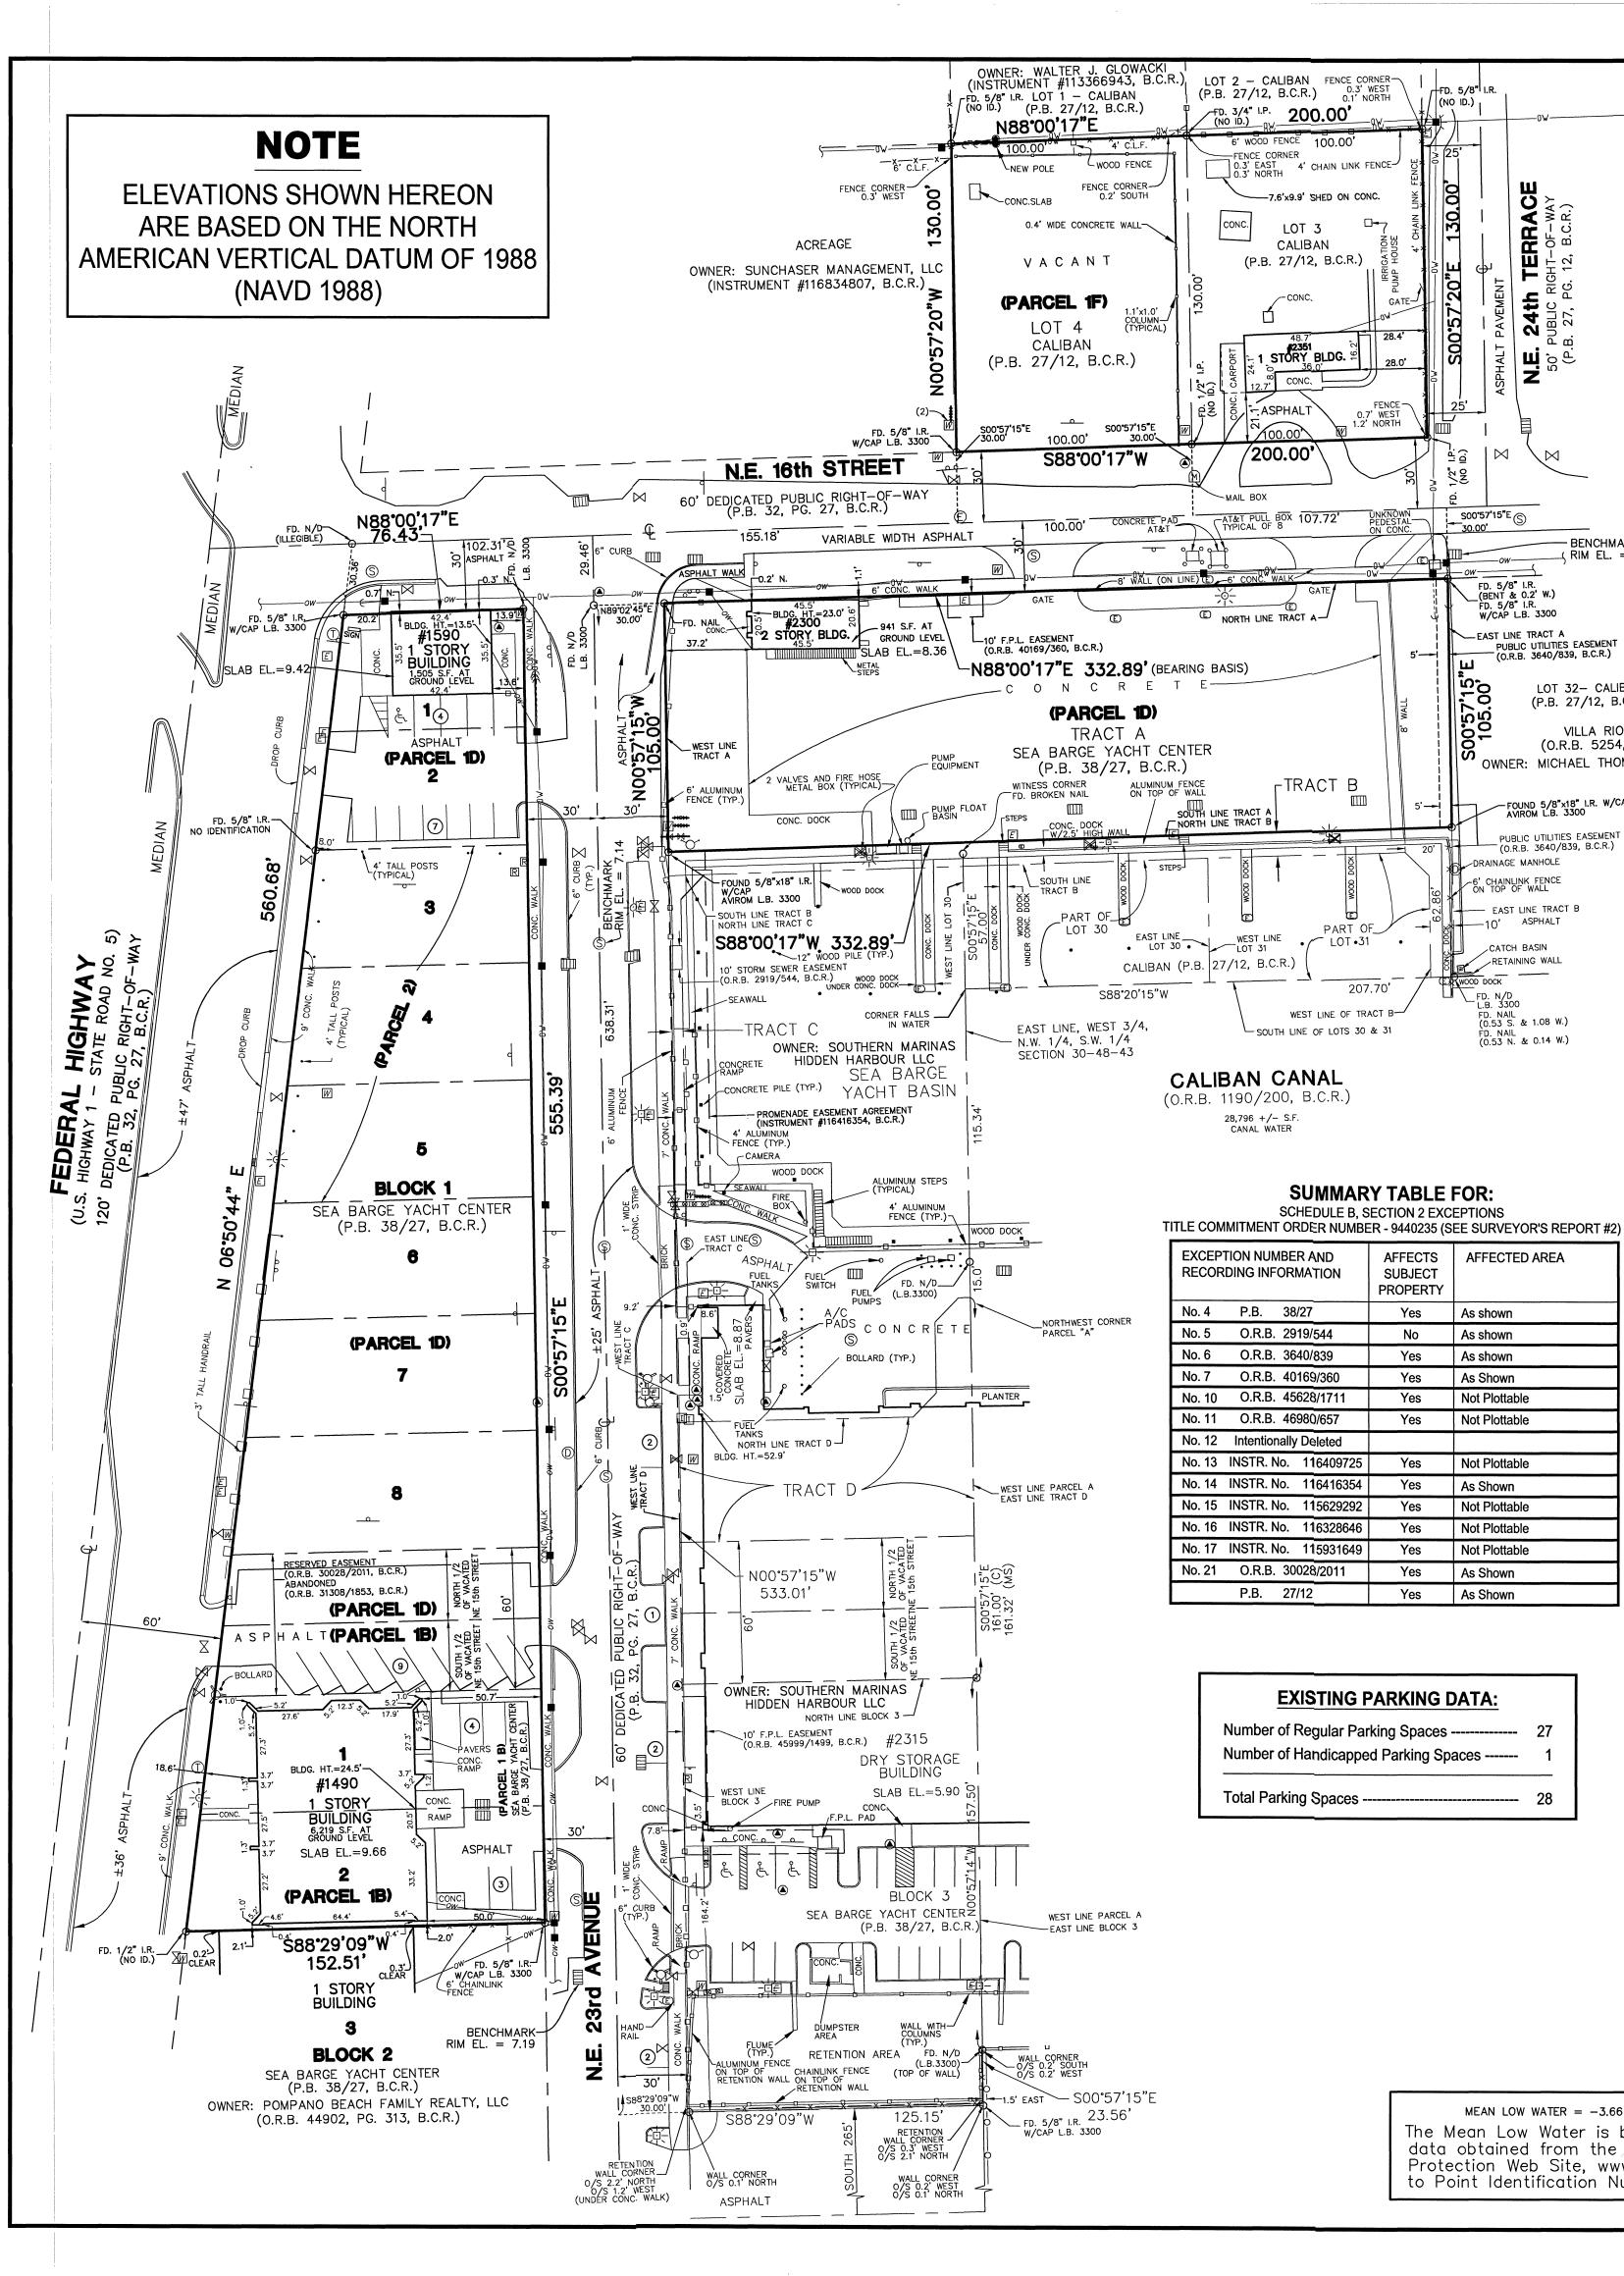

LEGEND

∠ RIM EL. = 5.39

FD. 5/8" I.R. (BENT & 0.2' W.) FD. 5/8" I.R. W/CAP L.B. 3300

-EAST LINE TRACT A

-DRAINAGE MANHOLE

6' CHAINLINK FENCE

-10' ASPHALT

CATCH BASIN

RETAINING WALL

FD. NAIL (0.53 S. & 1.08 W.)

FD. NAIL (0.53 N. & 0.14 W.)

AFFECTED AREA

Not Plottable

Not Plottable

Not Plottable

- EAST LINE TRACT B

PUBLIC UTILITIES EASEMENT
(0.R.B. 3640/839, B.C.R.)

FOUND 5/8"x18" I.R. W/CAP AVIROM L.B. 3300

LOT 32- CALIBAN

VILLA RIO CONDOMINIUM

(O.R.B. 5254, PG. 867, B.C.R.)

OWNER: MICHAEL THOMAS DeSTAFANO, "ET AL."

(P.B. 27/12, B.C.R.)

BACK FLOW PREVENTOR VALVE

CATCH BASIN CLEAN OUT CONCRETE LIGHT POLE

CONCRETE UTILITY POLE CURB INLET DOUBLE DEDECTOR CHECK VALVE DRAINAGE MANHOLE

(E) ELECTRIC MANHOLE FIRE HYDRANT ELECTRIC SERVICE BOX EXISTING ELEVATION

GREASE TRAP GUY ANCHOR HANDICAP PARKING IRRIGATION CONTROL BOX LIGHT POLE

MONITORING WELL NUMBER OF REGULAR PARKING -- ow--- OVERHEAD WIRES REUSE WATER METER

TELEPHONE MANHOLE

SANITARY MANHOLE SIAMESE CONNECTION SIGN (UNLESS NOTED) TELEPHONE BOX


1 \bowtie VALVE WATER METER WOOD UTILITY POLE


DRAIN

ZONING INFORMATION:

NOT PROVIDED BY INSURER

MEAN LOW WATER = -3.66 FEET (NAVD 1988) The Mean Low Water is based on established data obtained from the Florida Department of Environmental Protection Web Site, www.labins.org and referenced to Point Identification Number 89.

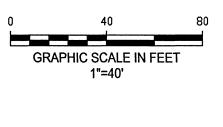

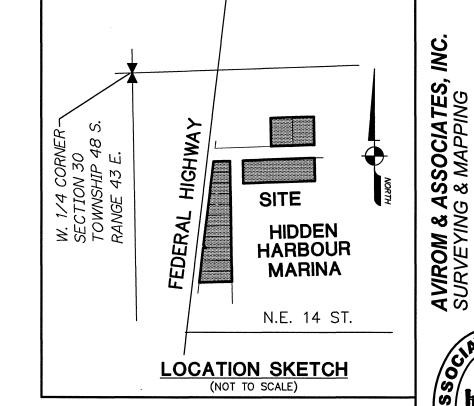

SURVEYOR'S REPORT:

- 1. Reproductions of this Sketch are not valid without the signature and the original seal of a Florida Licensed Surveyor and Mapper. Additions or deletions to this survey map or report by other than the signing party is prohibited without written consent of the signing party.
- 2. Lands shown hereon were not abstracted by Avirom & Associates, Inc. for easements, rights—of—way, ownership or other instruments of records. Instruments of record are per Title Commitment Order Number 9440235, issued by FIDELITY NATIONAL TITLE INSURANCE COMPANY, having an effective date of 04/22/2021, (Revision Number 2 on June 2, 2021). Property shown hereon is subject to agreements, covenants, easements, restrictions and other matters contained in the Title Commitment. Easements, where applicable are shown on the survey. (see SUMMARY TABLE)
- The land description shown hereon was provided by the Client. Bearings shown hereon are assumed based on the north line of Tract A — SEA BARGE YACHT CENTER having
- a bearing of N88°00'17"E. Elevations shown hereon are based on the North American Vertical Datum of 1988.
- 6. Benchmark reference: National Geodetic Survey Benchmark, Designation 015, PID D02654, EL = 6.77 feet
- 7. Symbols shown hereon and in the legend may have been enlarged for clarity. These symbols have been plotted at the center of the field location and may not represent the actual shape or size of the feature. 8. This map is intended to be displayed at a scale of 1:480 (1"=40")...
- 9. Units of measurement are in U.S. Survey Feet and decimal parts thereof. Well identified features in this survey were field measured to a horizontal positional accuracy of 0.10'. 10. Adjacent property owner information shown hereon was obtained from the Broward County Property Appraiser's
- 11. The entire property described hereon lies within Flood Zone X, Community Panel No. 12011C0188H, dated
- 12. Abbreviation Legend: B.C.R. = Broward County Records; C= Calculated; C= Centerline; C.B.S.= Concrete, Block
- & Stucco; C.L.F. = Chainlink Fence; C.M. = Concrete Monument; CONC.= Concrete; DIA. = Diameter; ESMT.= Easement; FD.= Found; F.P.L. = Florida Power & Light Company; ID.= Identification; INSTR. = Instrument; I.P.= Iron Pipe: I.R.= Iron Rod; L.B.= Licensed Business; MS= Measured; N/D= Nail & Disk; O.R.B.= Official Records Book; O/S= Offset; OW = Overhead Wires; P.B.= Plat Book; PG.= Page; P.L.S.= Professional Land Surveyor; P.O.B. Point of Beginning; P.O.C. Point of Commencement; P.R.M. Permanent Reference Monument: R/W= Right-of-Way; U.E.= Utility Easement; W/= With; W/CAP= With Surveyors Cap; BLDG. HT = Building Height: TYP. = Typical: NAVD 88 = National American Vertical Datum of 1988; C.M.P. = Corrugated Metal Pipe; D.I.P. = Ductile Iron Pipe; EL. = Elevation; H.D.P.E. = High-density Polyethylene; INV. = Invert; P.V.C. = Polyvinyl Chloride; R.C.P = Reinforced Concrete Pipe; UNK. = Unknown.

LAND DESCRIPTION:

(Parcel 1B)

Lots 1 and 2. Block 2, SEA BARGE YACHT CENTER, according to the Plat thereof, recorded in Plat Book 38, Page 27 of the Public Records of Broward County, Florida;

Together with the South 1/2 of the vacated N.E. 15th Street, lying North of Lot 1, Block 2, SEA BARGE YACHT CENTER, according to the Plat thereof, recorded in Plat Book 38, Page 27 of the Public Records of Broward County, Florida, as vacated by Ordinance No. 2000—14 recorded November 18. 1999 in Official Records Book 30028, Page 2011, of said Public Records.

(Parcel 1D)

Lots 1, 2, 6, 7 and 8, in Block 1; and all of Tract "A" of SEA BARGE YACHT CENTER, according to the Plat thereof, recorded in Plat Book 38, Page 27 of the Public Records of Broward County, Florida;

Together with the North 1/2 of the vacated N.E. 15th Street, lying South of Lot 8, Block 1 of SEA BARGE YACHT CENTER, according to the Plat thereof, recorded in Plat Book 38, Page 27 of the Public Records of Broward County, Florida.

(Parcel 1F)

Lots 3 and 4 of CALIBAN, according to the Plat thereof as recorded in Plat Book 27, at Page 12 of the Public Records of Broward County, Florida.

(Parcel 2)

Lots 3, 4 and 5, Block 1, of SEA BARGE YACHT CENTER, according to the Plat thereof, as recorded in Plat Book 38, Page 27, of the public records of Broward County, Florida.

Said lands situate in the City of Pompano Beach, Broward County, Florida and containing 124,463 square feet (2.8573 acres) more or less.

CERTIFICATION:

I HEREBY CERTIFY that the attached Boundary Survey of the hereon described property is true and correct to the best of my knowledge and belief as surveyed in the field under my direction. I FURTHER CERTIFY that this Boundary Survey meets the Standards of Practice set forth in Chapter 5J-17, Florida Administrative Code, pursuant to Chapter 472, Florida Statutes.


DAVID


Digitally signed by DAVID ERIC BREAUX, Jr, P.L.S. DN: cn=DAVID ERIC BREAUX, Jr, P.L.S., o=Avirom & Associates, lnc, ou, com, c=US

Date: 2021.07.29 13:40:20

DAVID ERIC Florida Regis email=eric@aviromsurvey. AVIROM & L.B. No. 330


VEY
MARINA"
NTER (P.B. 38/27
S. 27/12, B.C.R.) "HIDDEN HARBOUR NON OF SEA BARGE YACHT CENT LOTS 3 AND 4 - CALIBAN (P.B. 2

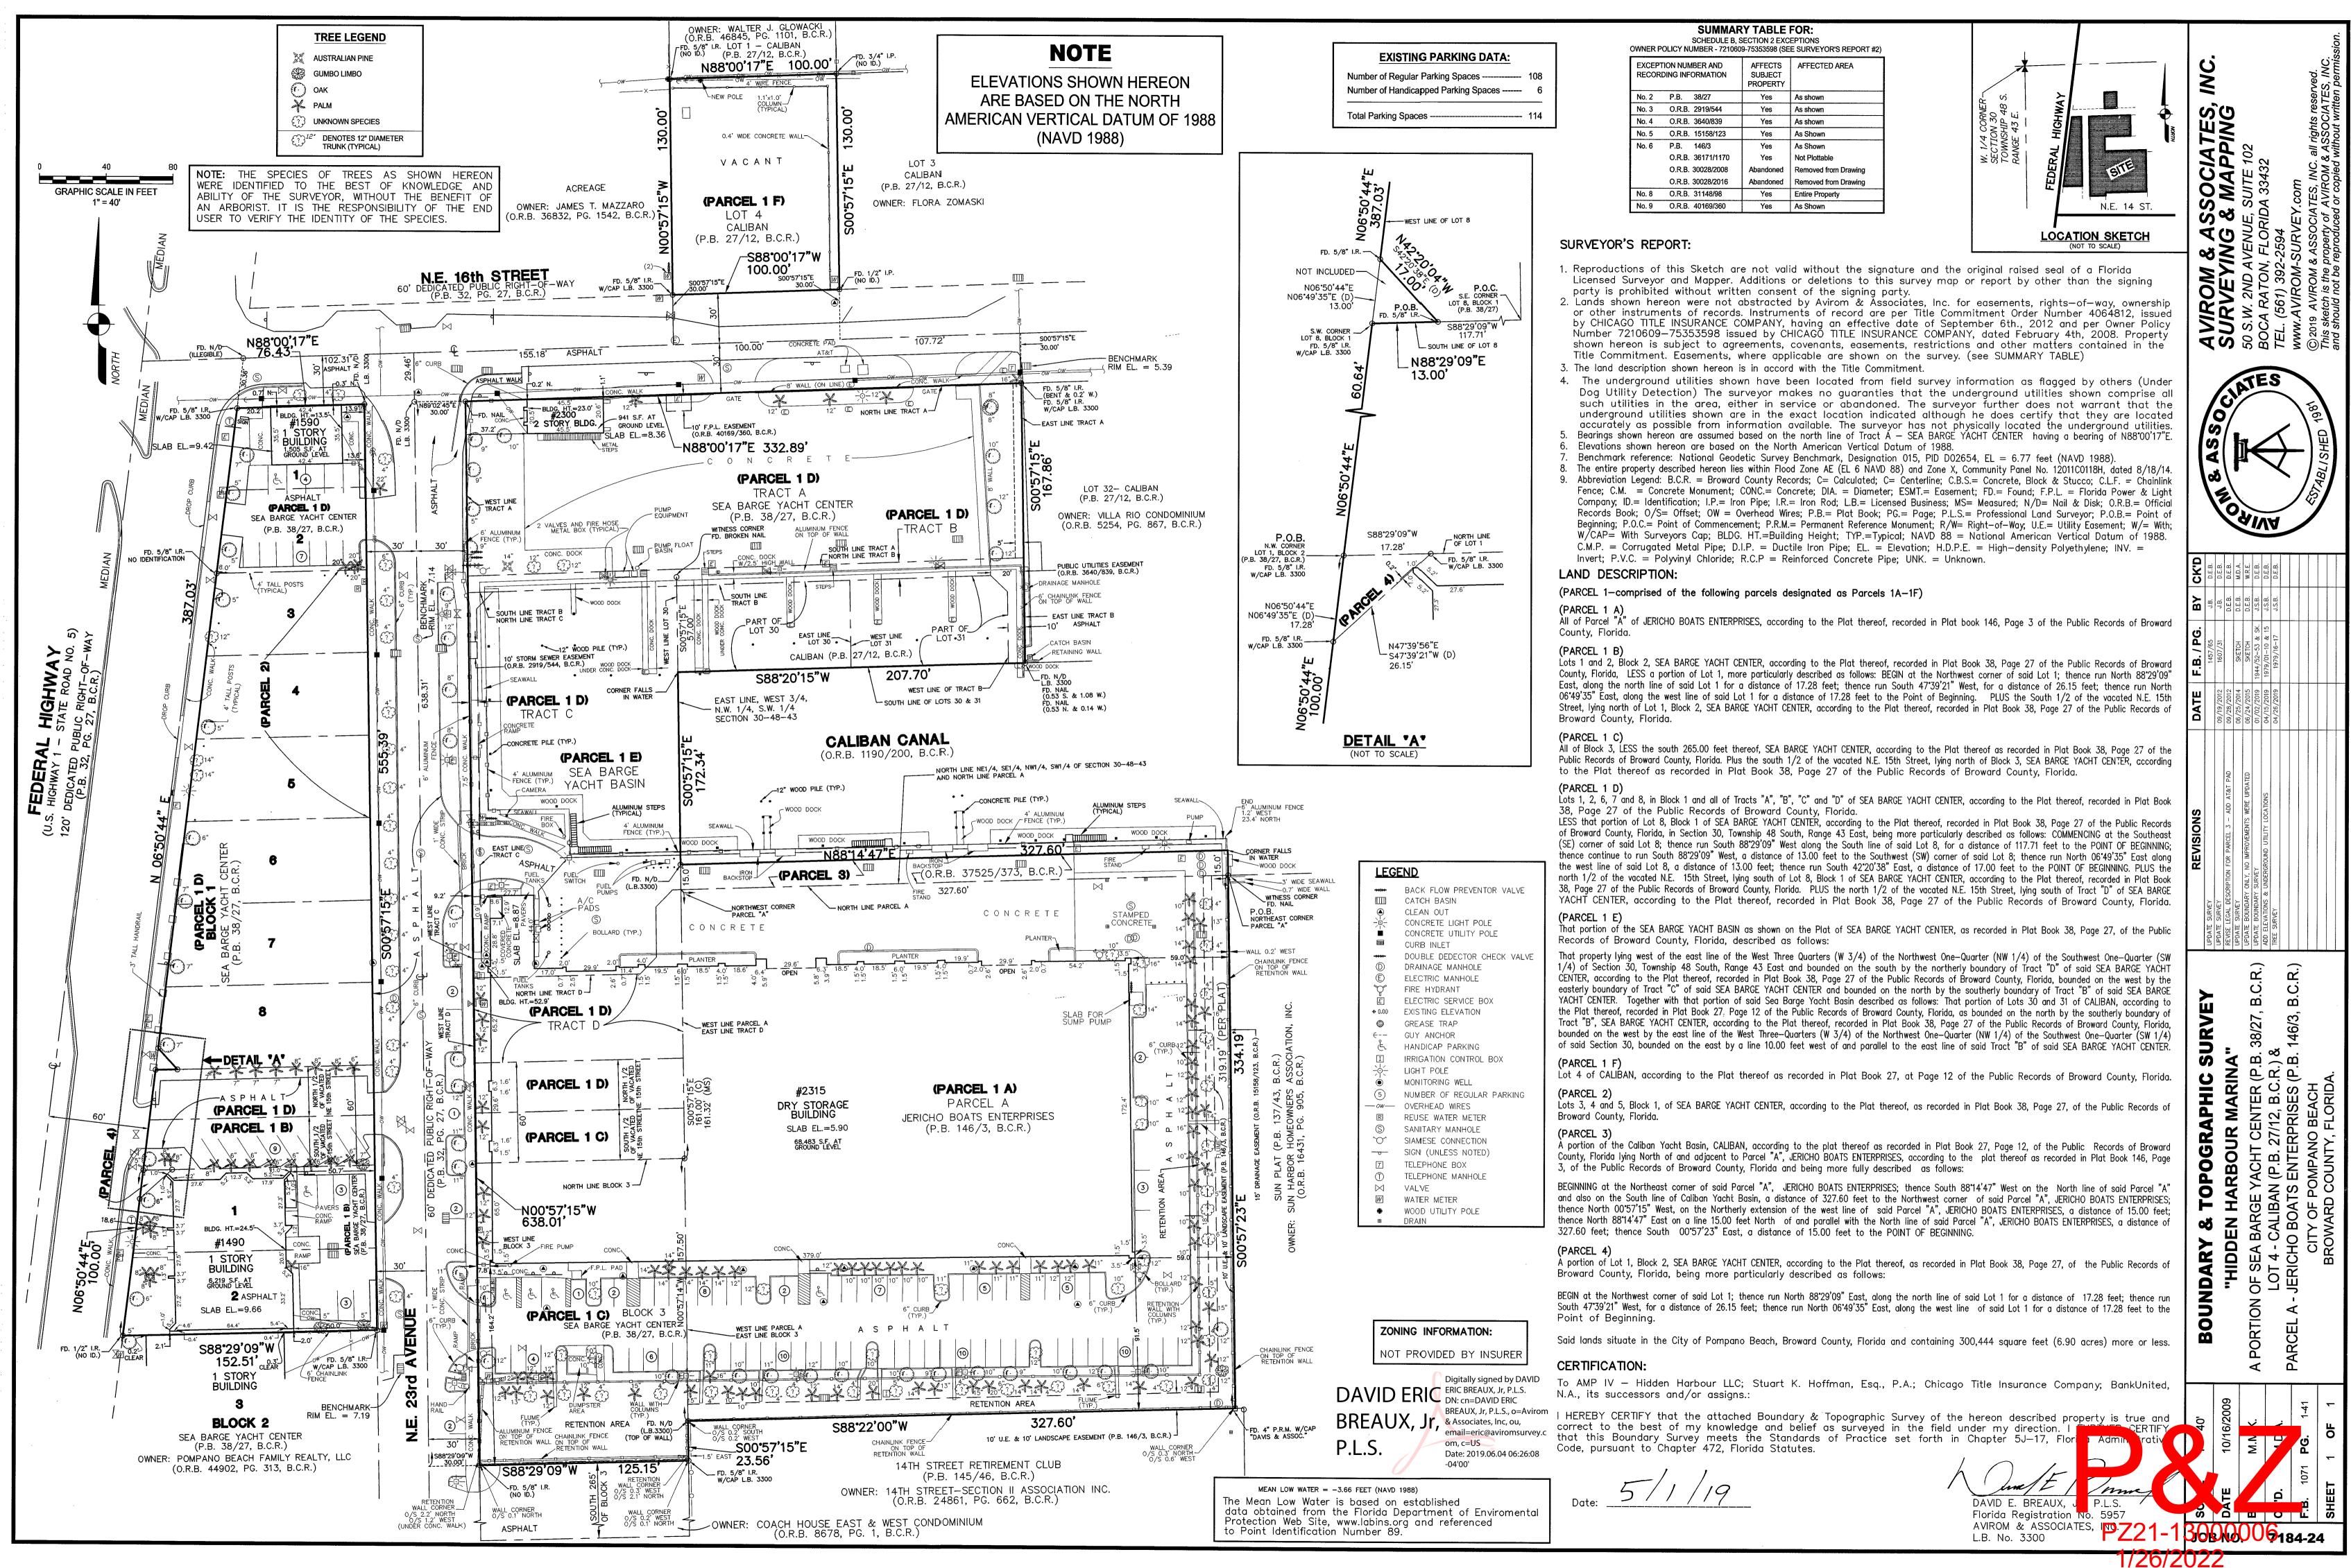


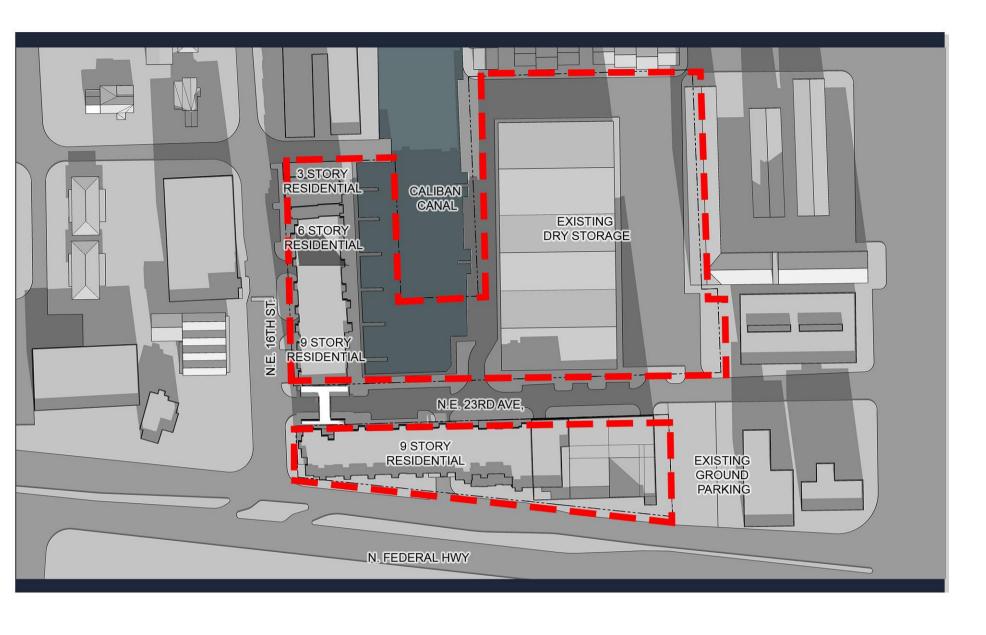

FALL EQUINOX

SPRING EQUINOX

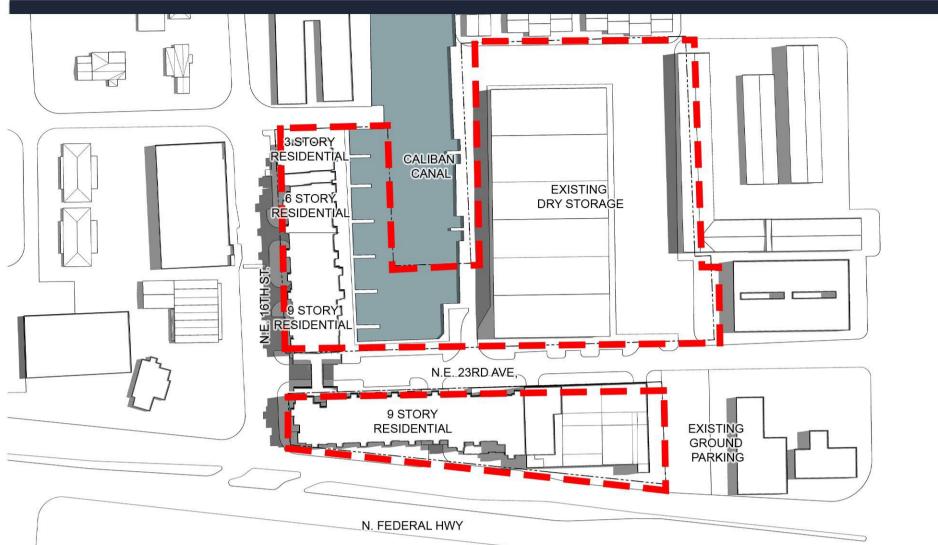

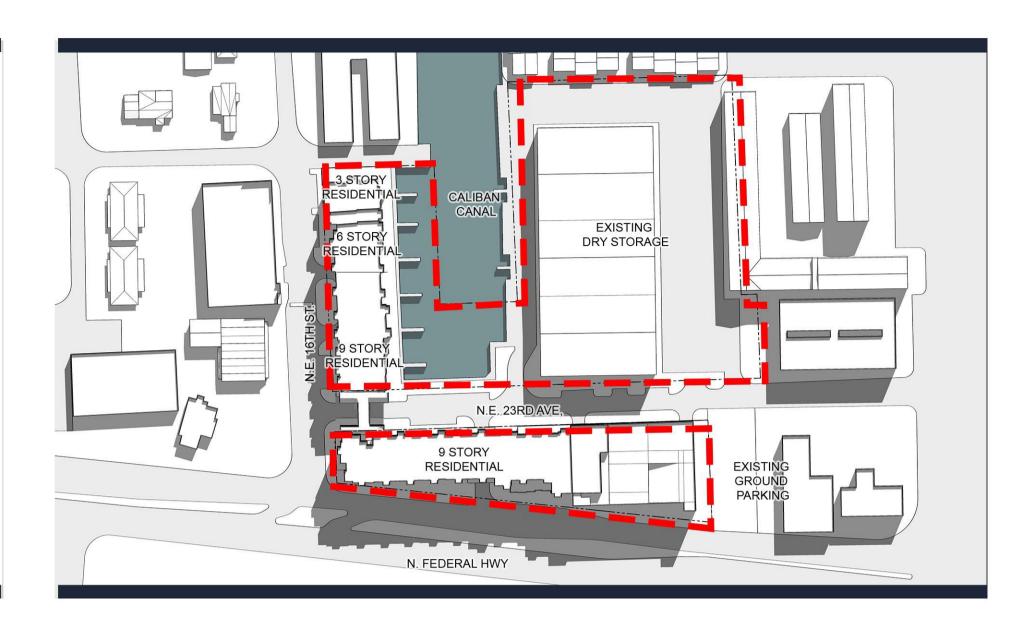



TWO HRS AFTER SUNRISE


BEATRIZ M. HERNANDEZ AR0094576


TWO HRS. BEFORE SUNSET



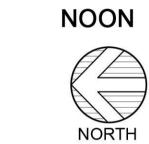

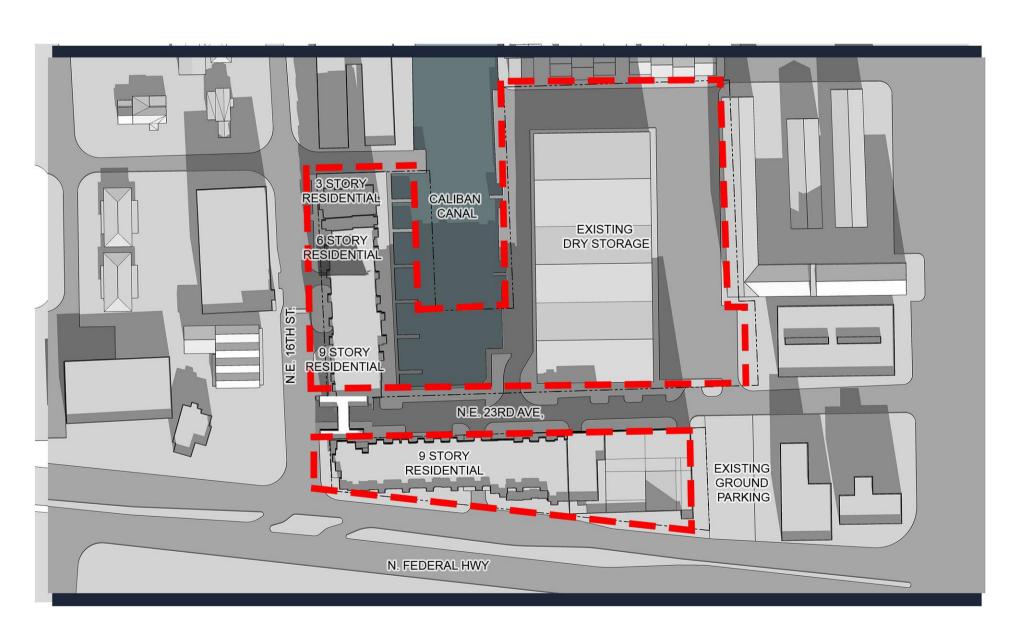

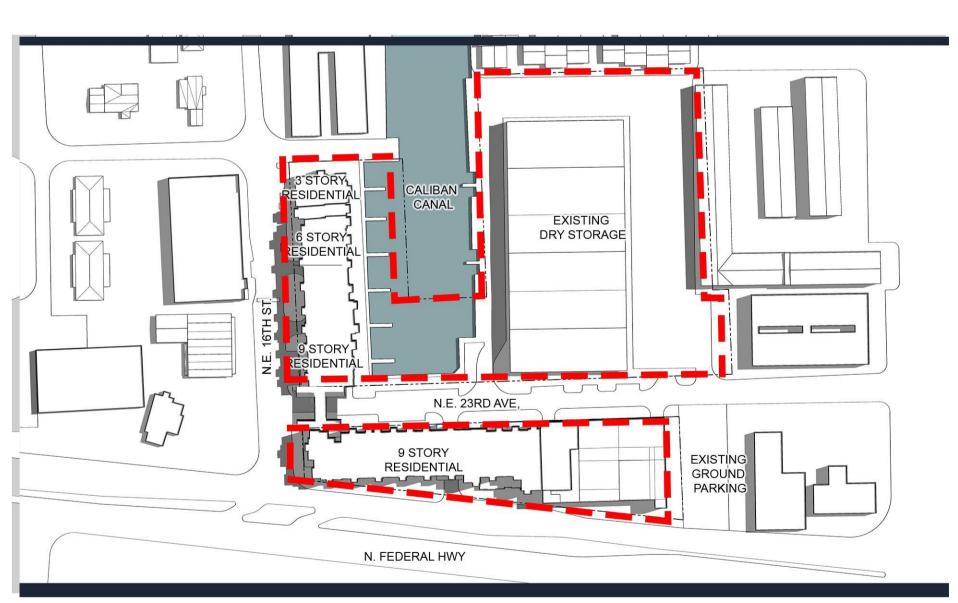

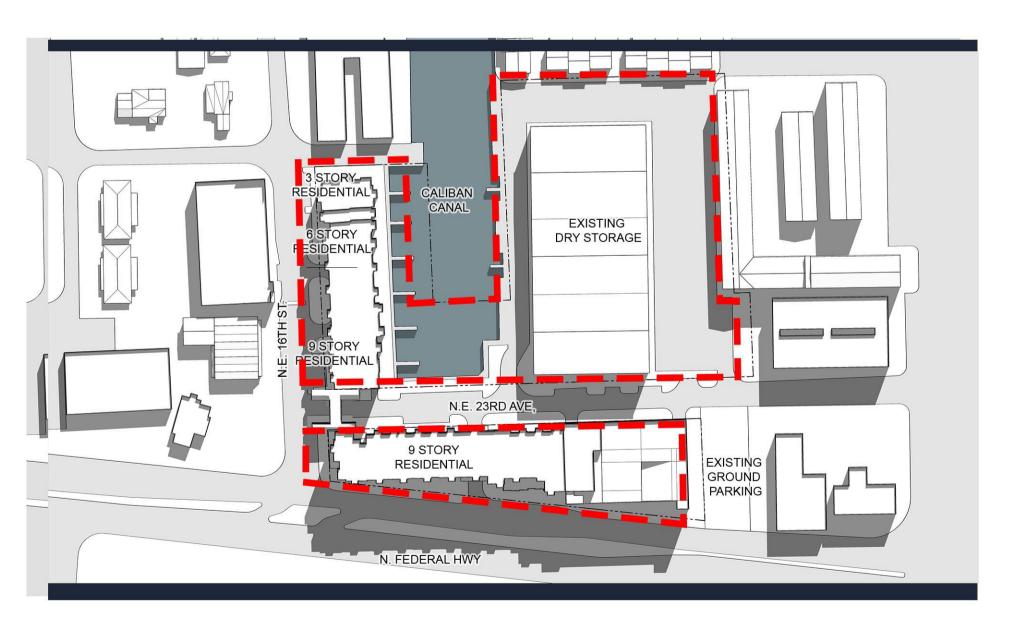


TWO HRS. BEFORE SUNSET






TWO HRS AFTER SUNRISE



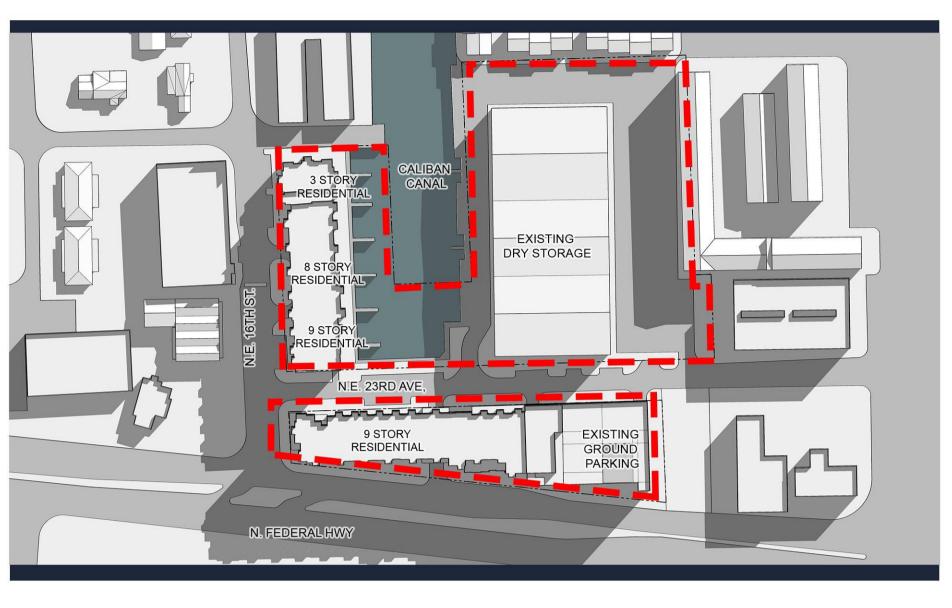

TWO HRS. BEFORE SUNSET

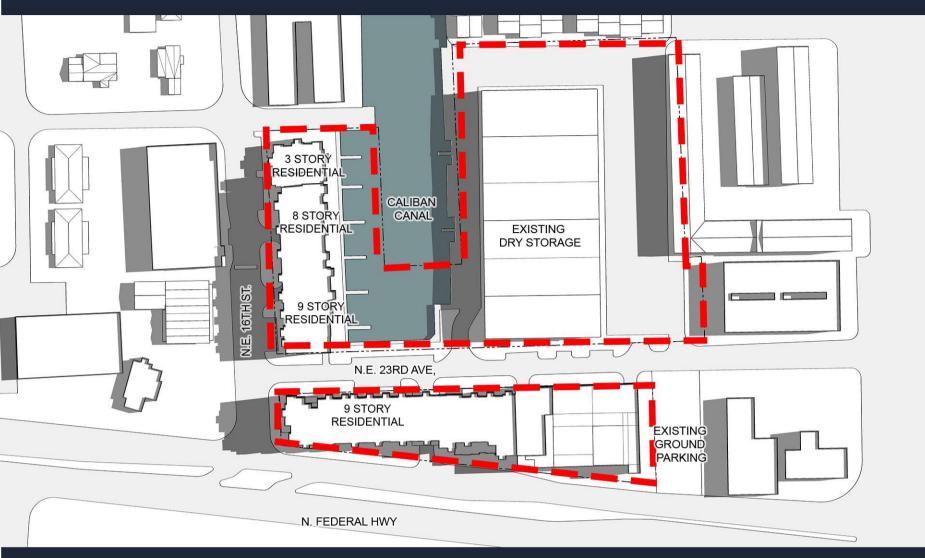






TWO HRS AFTER SUNRISE


NOON



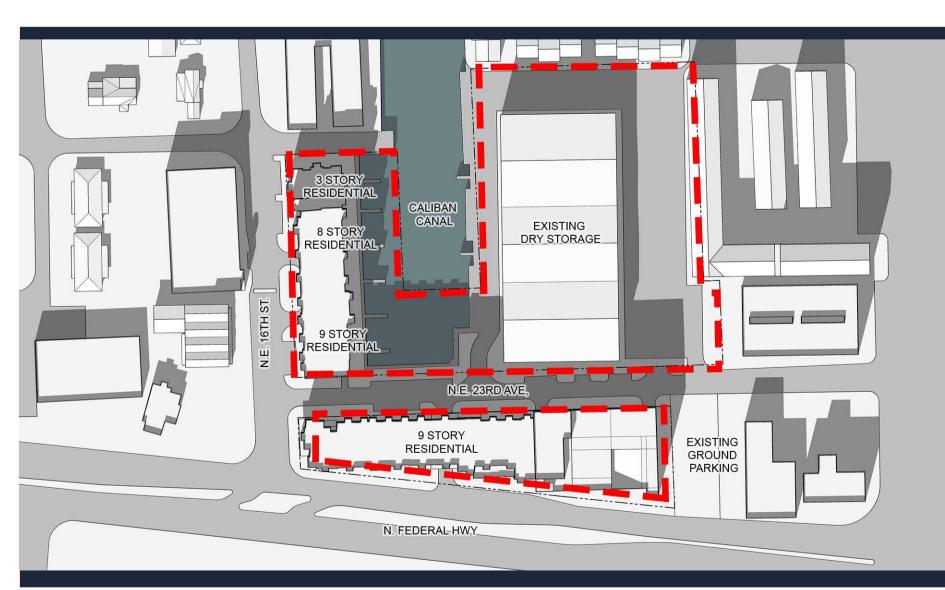

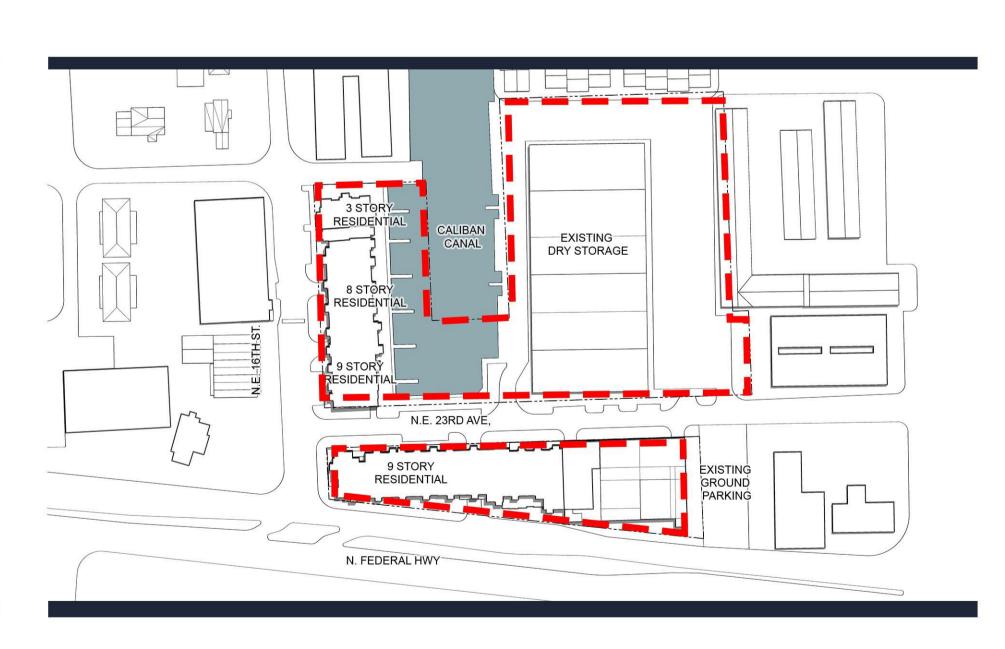

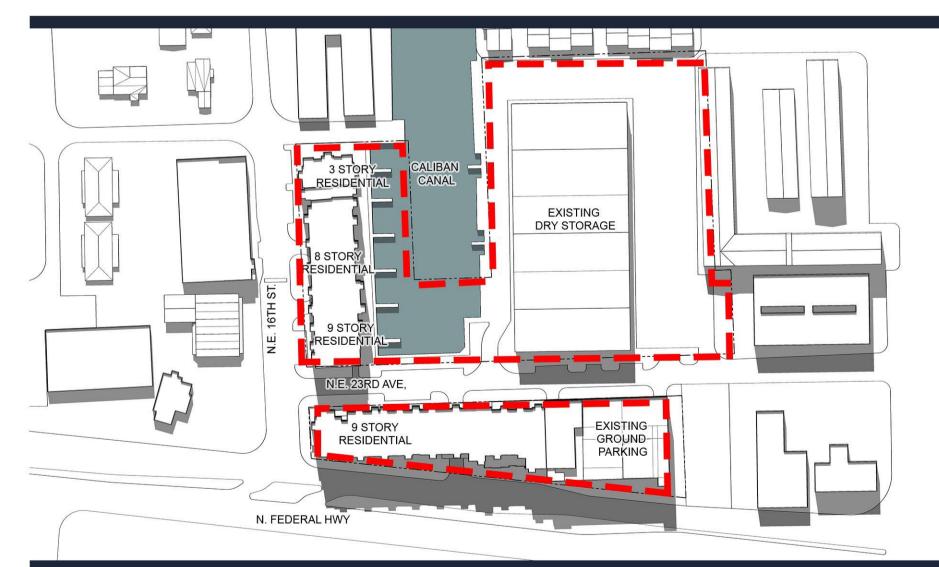

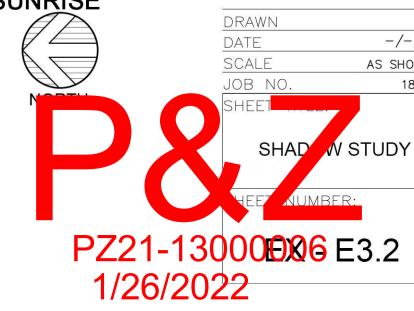








WINTER SOLSTICE

SUMMER SOLSTICE

TWO HRS AFTER SUNRISE -/-/-AS SHOWN

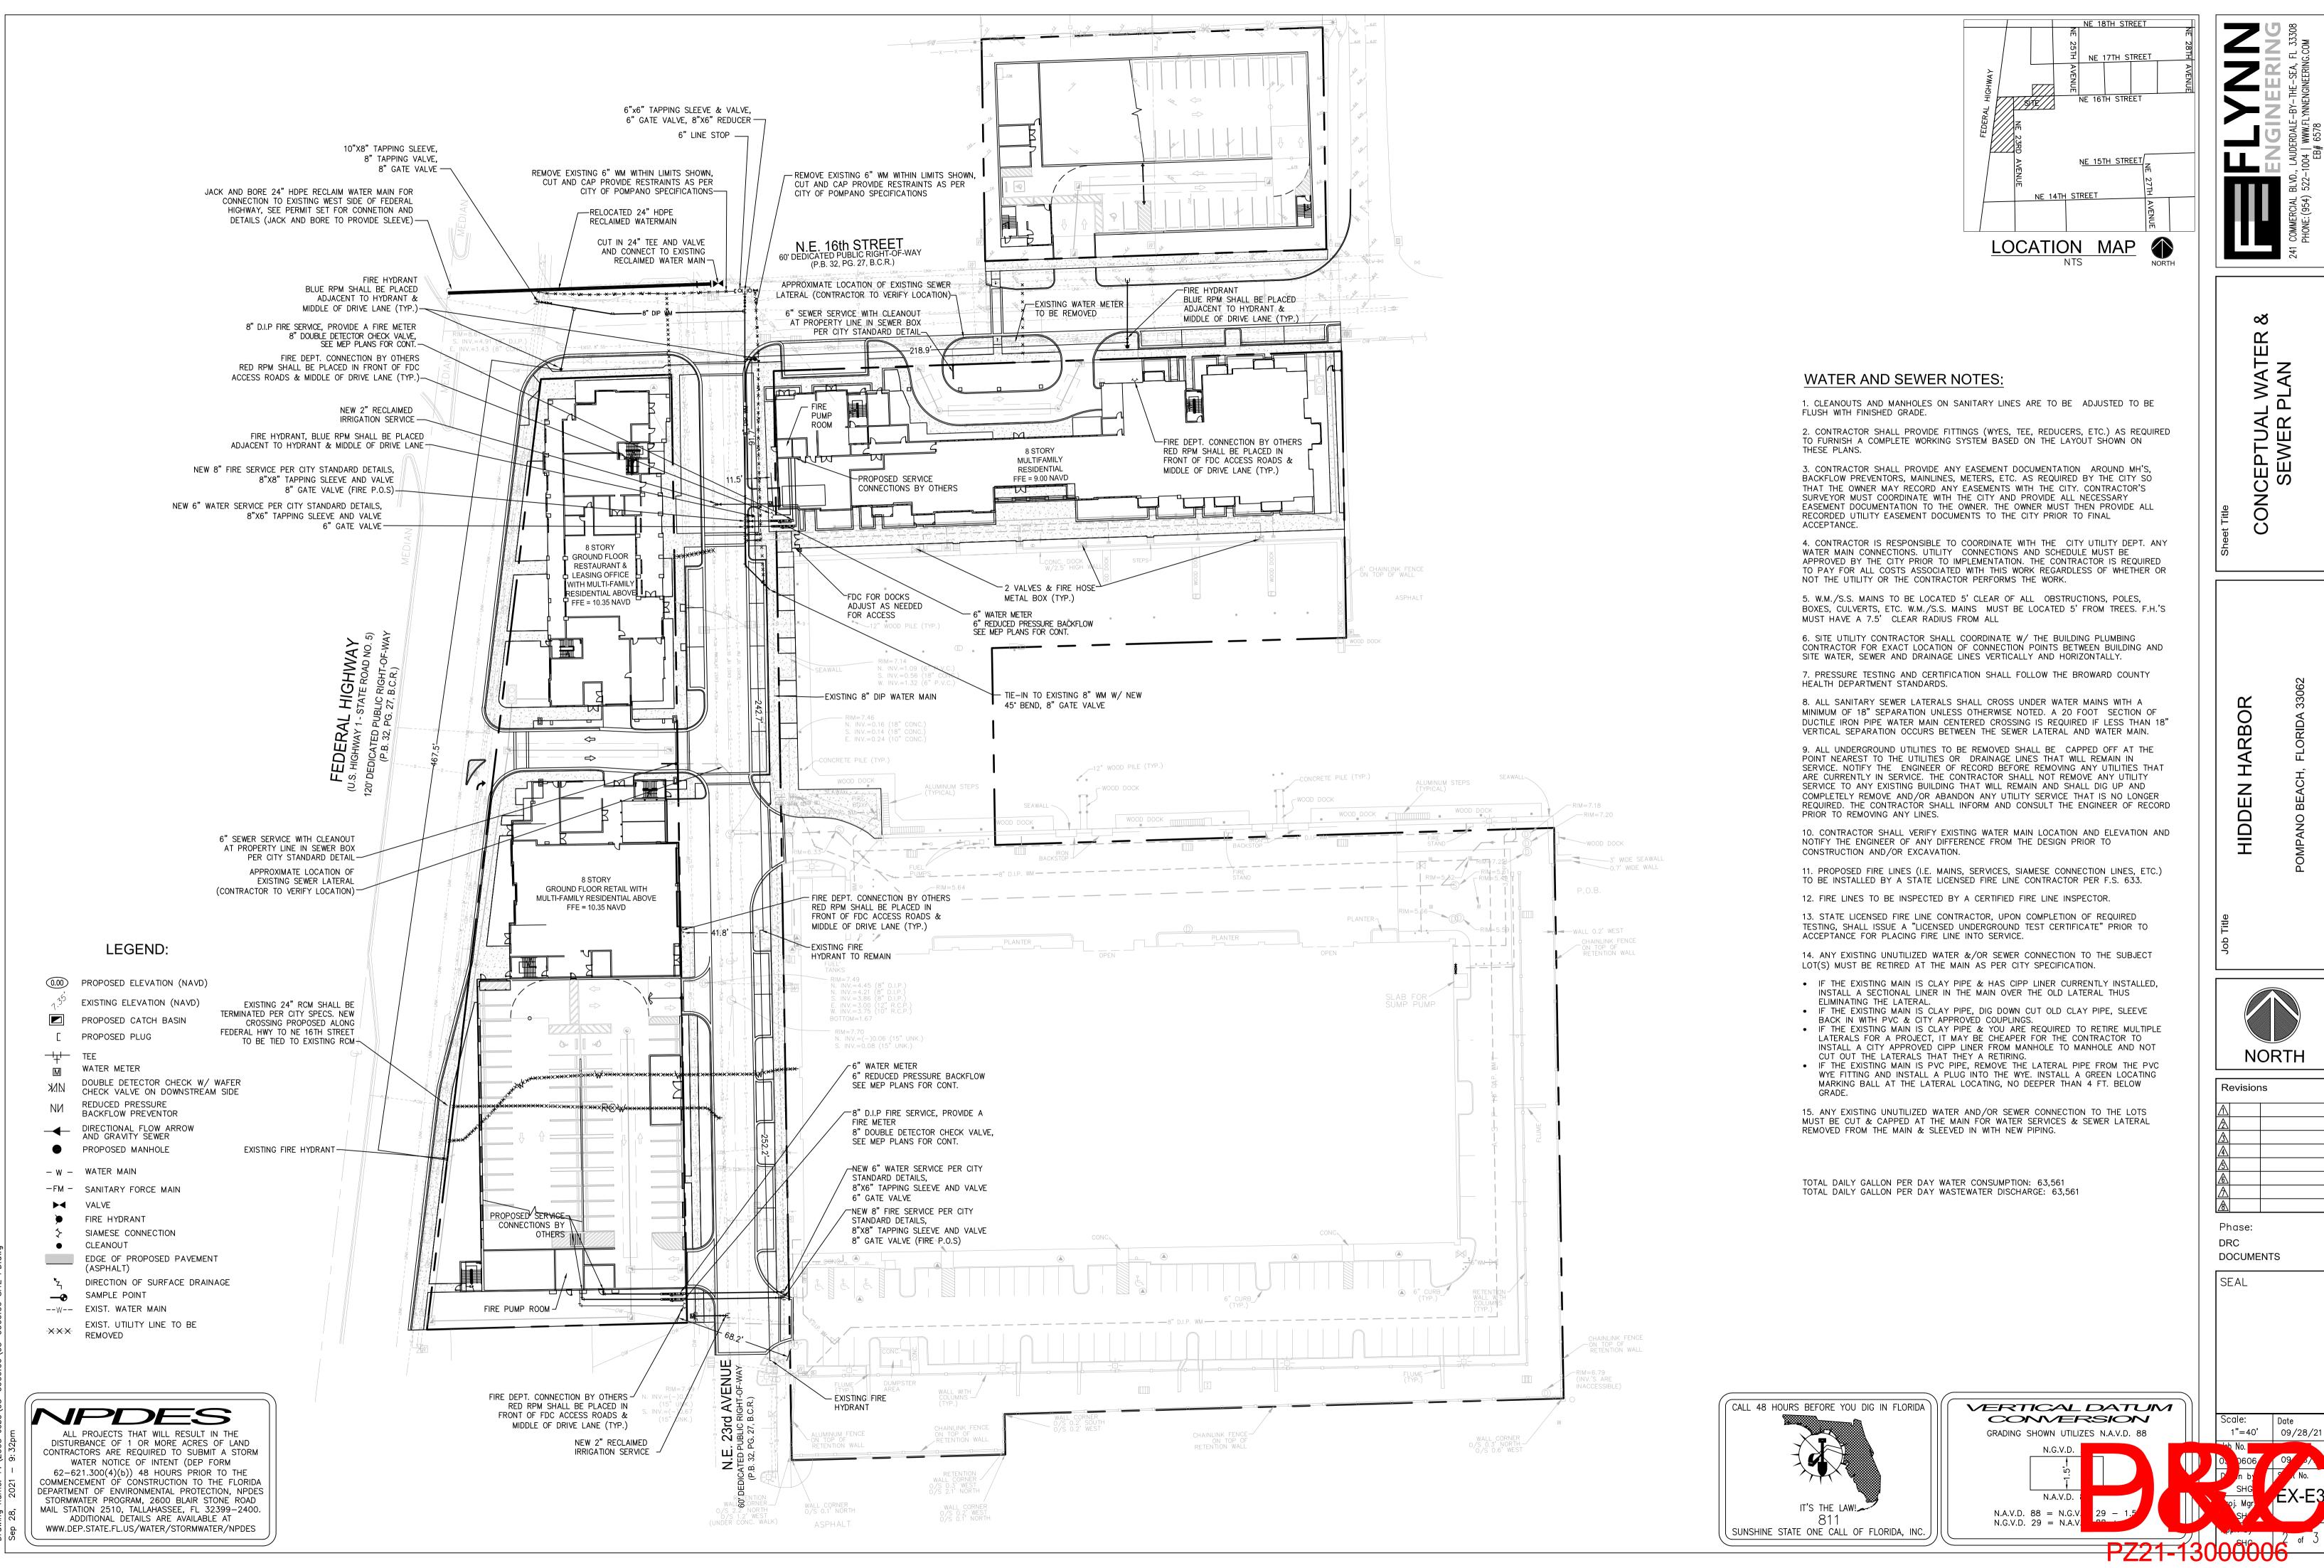

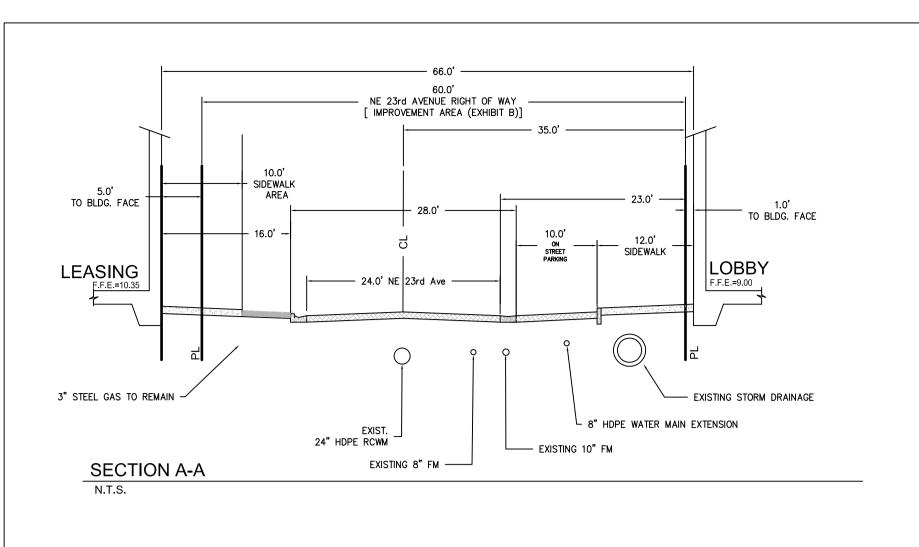

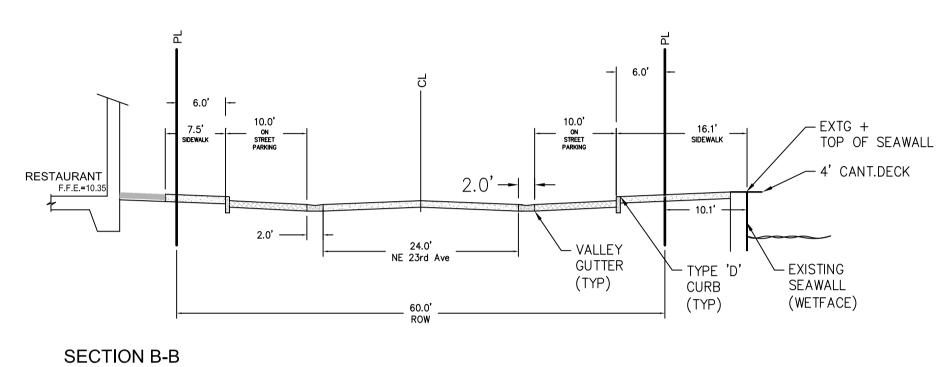

GRADING AND DRAINAGE NOTES:

N.T.S.

1. ALL STORM DRAINAGE LINE FROM THE BLDG SHALL BE LAID @ 1.0% MINIMUM SLOPE UNLESS NOTED OTHERWISE ON PLANS. 2. CLEANOUTS ON STORM DRAINAGE LINES ARE TO BE ADJUSTED TO BE FLUSH W/FINISHED GRADE.

3. CONTRACTOR SHALL PROVIDE FITTINGS (WYES, TEE, REDUCERS, ETC.) AS REQUIRED TO FURNISH A COMPLETE WORKING SYSTEM BASED ON THE LAYOUT SHOWN ON THESE PLANS.

4. LANDSCAPED AREAS SHALL BE GRADED TO DRAIN TO THE CATCH BASIN INLETS. FIELD ADJUST GRADING AS REQUIRED.

5. SITE UTILITY CONTRACTOR SHALL COORDINATE WITH THE BUILDING PLUMBING CONTRACTOR FOR EXACT LOCATION OF CONNECTION POINTS BETWEEN THE BUILDING AND SITE WATER, SEWER AND DRAINAGE LINES (VERTICALLY AND HORIZONTALLY).

6. RECTANGULAR CATCH BASIN AND YARD DRAIN GRATES SHALL BE INSTALLED SUCH THAT THE LONG AXIS OF GRATE PARALLELS THE CLOSEST ADJACENT WALK, BLDG., DRIVE WAY, PROPERTY LINE, OR ROADWAY.

7. COORDINATE LOCATION IN FIELD OF ALL CATCH BASINS & YARD DRAINS WITH LANDSCAPE CONTRACTOR TO AVOID CONFLICTS.

8. CENTERLINE OF YARD DRAINS @ BASE OF DOWN SPOUTS MUST ALIGN WITH CENTERLINE OF DOWN SPOUT PRIOR TO FINAL ACCEPTANCE BY OWNER. REFERENCE ARCH. PLANS FOR EXACT LOCATION OF DOWN SPOUTS.

STRUCTURE CATEGORY II, MINIMUM FFE = BFE+1 FLOOD ZONE "X" ELEV N/A NAVD ON FIRM MAP #12011C0188H, DATE AUGUST 18, 2014 BROWARD COUNTY 100 YEAR 3 DAY CONTOUR= ELEV. 5.50 NAVD AVERAGE WET SEASON WATER LEVEL= ELEV. 1.50 NAVD

LEGEND:

PROPOSED ELEVATION (NAVD)

EXISTING ELEVATION (NAVD)

PROPOSED CATCH BASIN

PROPOSED PLUG

-|_| TEE WATER METER

DOUBLE DETECTOR CHECK W/ WAFER CHECK VALVE ON DOWNSTREAM SIDE

REDUCED PRESSURE BACKFLOW PREVENTOR

DIRECTIONAL FLOW ARROW AND GRAVITY SEWER

PROPOSED MANHOLE

-FM - SANITARY FORCE MAIN

− W − WATER MAIN

▶◀ VALVE FIRE HYDRANT


SIAMESE CONNECTION CLEANOUT

EDGE OF PROPOSED PAVEMENT (ASPHALT)

DIRECTION OF SURFACE DRAINAGE

SAMPLE POINT


--W-- EXIST. WATER MAIN XXX REMOVED

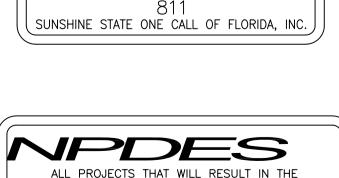


سر!IT'S THE LAW

CALL 48 HOURS BEFORE YOU DIG IN FLORIDA

ALL PROJECTS THAT WILL RESULT IN THE DISTURBANCE OF 1 OR MORE ACRES OF LAND CONTRACTORS ARE REQUIRED TO SUBMIT A STORM WATER NOTICE OF INTENT (DEP FORM 62-621.300(4)(b)) 48 HOURS PRIOR TO THE COMMENCEMENT OF CONSTRUCTION TO THE FLORIDA DEPARTMENT OF ENVIRONMENTAL PROTECTION, NPDES STORMWATER PROGRAM, 2600 BLAIR STONE ROAD MAIL STATION 2510, TALLAHASSEE, FL 32399-2400. ADDITIONAL DETAILS ARE AVAILABLE AT WWW.DEP.STATE.FL.US/WATER/STORMWATER/NPDES

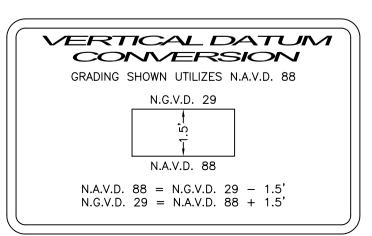

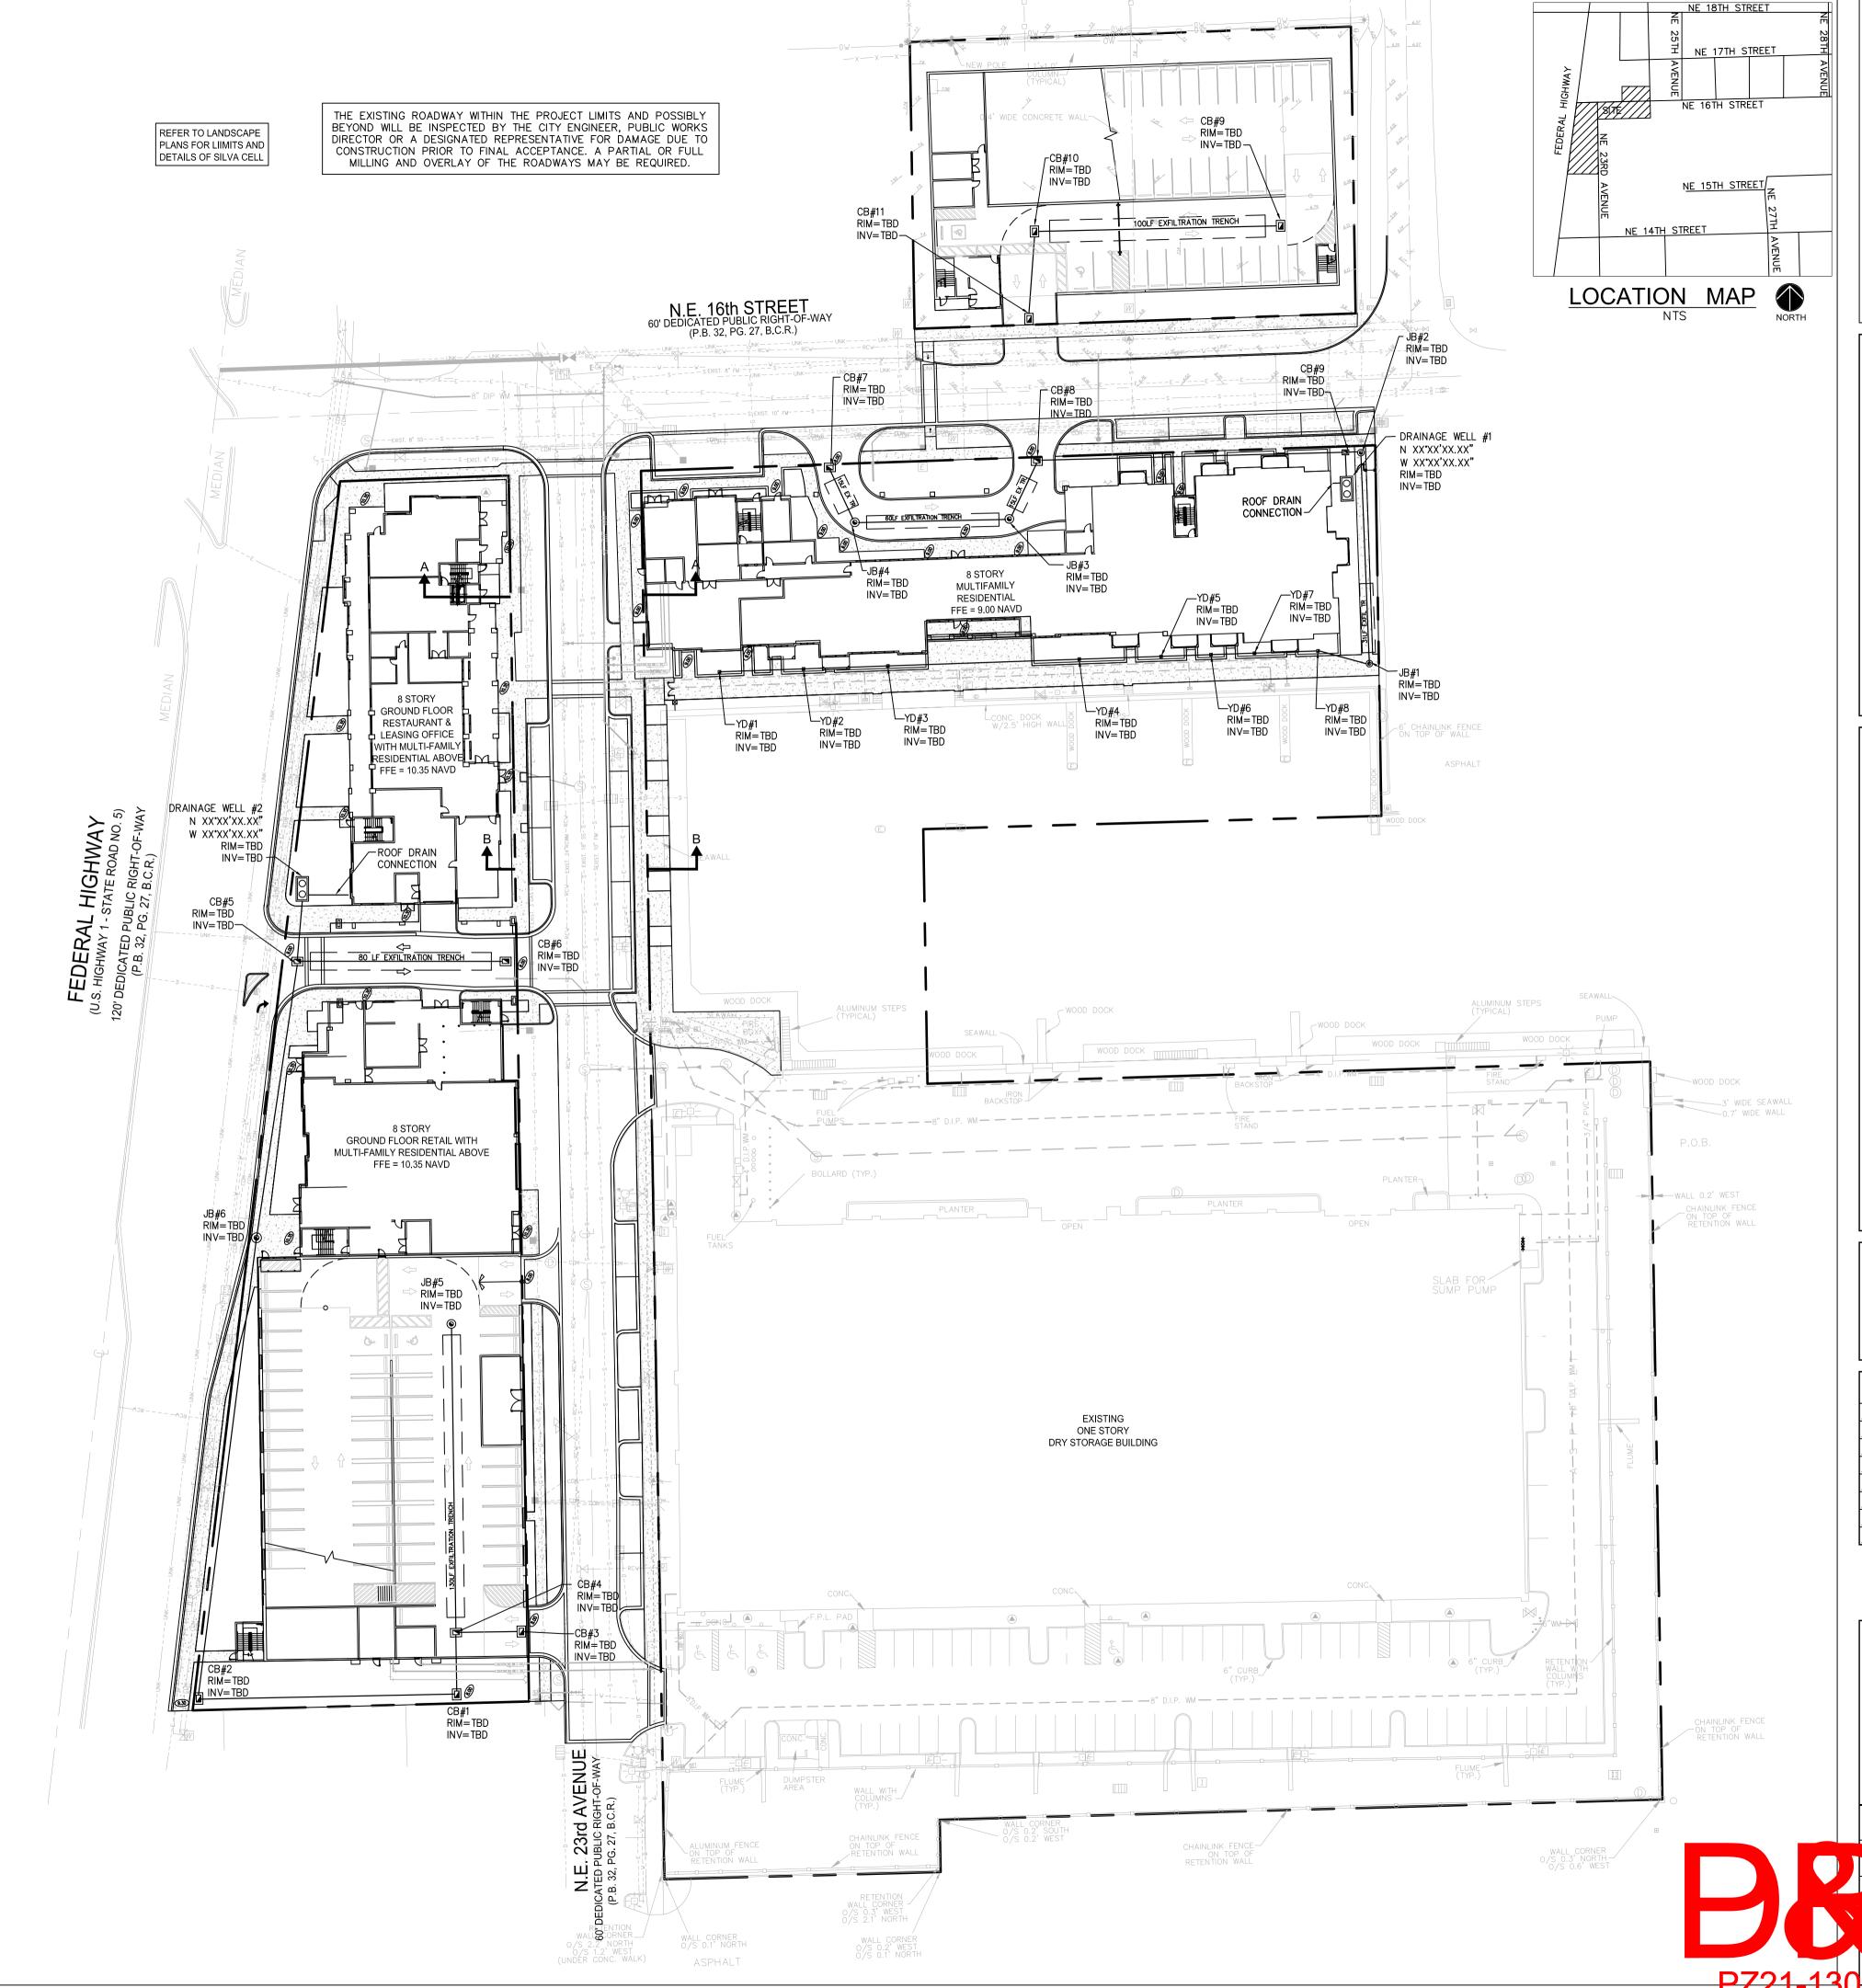


CONCEPTUAL PAVING, GRADING & DRAINAGE PLAN


NORTH

Revisions

Phase: DRC DOCUMENTS


SEAL

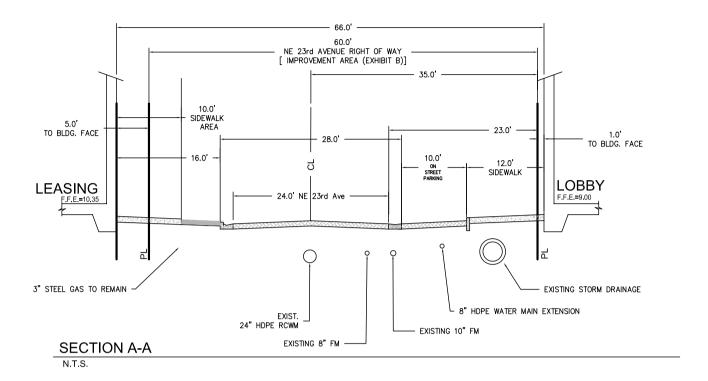


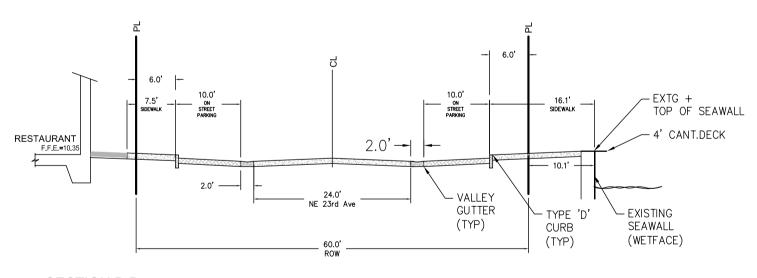


SECTION B-B

N.T.S.

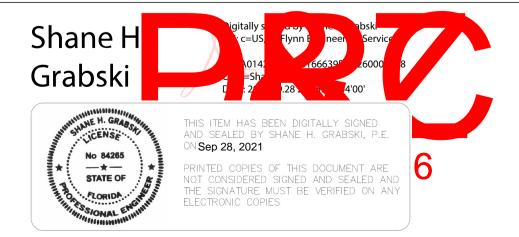

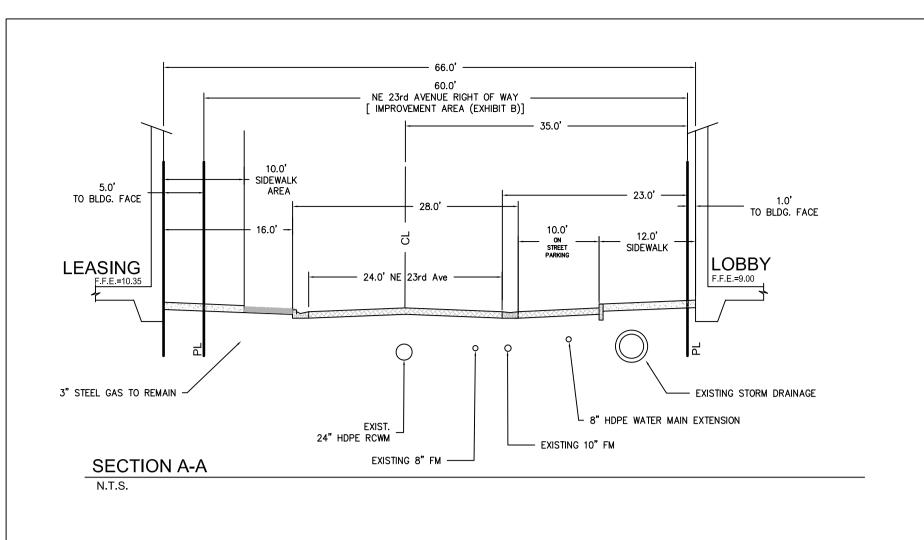

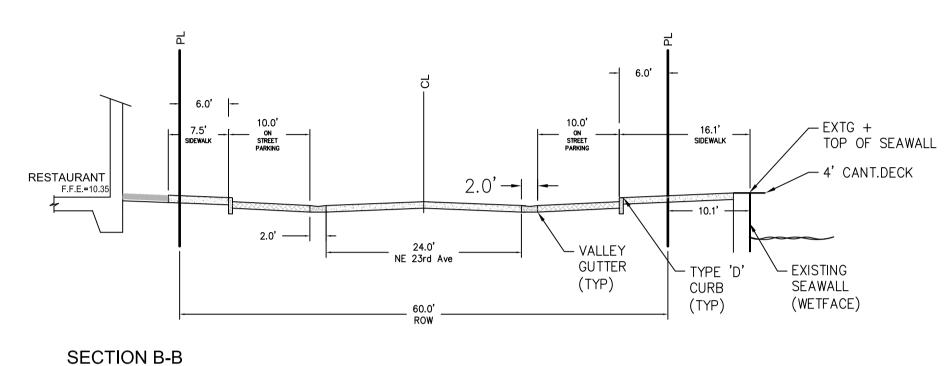

GRADING AND DRAINAGE NOTES:

N.T.S.

1. ALL STORM DRAINAGE LINE FROM THE BLDG SHALL BE LAID @ 1.0% MINIMUM SLOPE UNLESS NOTED OTHERWISE ON PLANS. 2. CLEANOUTS ON STORM DRAINAGE LINES ARE TO BE ADJUSTED TO BE FLUSH W/FINISHED GRADE.

3. CONTRACTOR SHALL PROVIDE FITTINGS (WYES, TEE, REDUCERS, ETC.) AS REQUIRED TO FURNISH A COMPLETE WORKING SYSTEM BASED ON THE LAYOUT SHOWN ON THESE PLANS.

4. LANDSCAPED AREAS SHALL BE GRADED TO DRAIN TO THE CATCH BASIN INLETS. FIELD ADJUST GRADING AS REQUIRED.

5. SITE UTILITY CONTRACTOR SHALL COORDINATE WITH THE BUILDING PLUMBING CONTRACTOR FOR EXACT LOCATION OF CONNECTION POINTS BETWEEN THE BUILDING AND SITE WATER, SEWER AND DRAINAGE LINES (VERTICALLY AND HORIZONTALLY).

6. RECTANGULAR CATCH BASIN AND YARD DRAIN GRATES SHALL BE INSTALLED SUCH THAT THE LONG AXIS OF GRATE PARALLELS THE CLOSEST ADJACENT WALK, BLDG., DRIVE WAY, PROPERTY LINE, OR ROADWAY.

7. COORDINATE LOCATION IN FIELD OF ALL CATCH BASINS & YARD DRAINS WITH LANDSCAPE CONTRACTOR TO AVOID CONFLICTS.

8. CENTERLINE OF YARD DRAINS @ BASE OF DOWN SPOUTS MUST ALIGN WITH CENTERLINE OF DOWN SPOUT PRIOR TO FINAL ACCEPTANCE BY OWNER. REFERENCE ARCH. PLANS FOR EXACT LOCATION OF DOWN SPOUTS.

STRUCTURE CATEGORY II, MINIMUM FFE = BFE+1 FLOOD ZONE "X" ELEV N/A NAVD ON FIRM MAP #12011C0188H, DATE AUGUST 18, 2014 BROWARD COUNTY 100 YEAR 3 DAY CONTOUR= ELEV. 5.50 NAVD AVERAGE WET SEASON WATER LEVEL= ELEV. 1.50 NAVD

LEGEND:

PROPOSED ELEVATION (NAVD) EXISTING ELEVATION (NAVD)

PROPOSED CATCH BASIN

PROPOSED PLUG

-|_| TEE

WATER METER DOUBLE DETECTOR CHECK W/ WAFER CHECK VALVE ON DOWNSTREAM SIDE

REDUCED PRESSURE BACKFLOW PREVENTOR

AND GRAVITY SEWER

PROPOSED MANHOLE

FIRE HYDRANT

− W − WATER MAIN

-FM - SANITARY FORCE MAIN

▶◀ VALVE


SIAMESE CONNECTION CLEANOUT


EDGE OF PROPOSED PAVEMENT (ASPHALT)


DIRECTION OF SURFACE DRAINAGE SAMPLE POINT


--W-- EXIST. WATER MAIN

XXX REMOVED

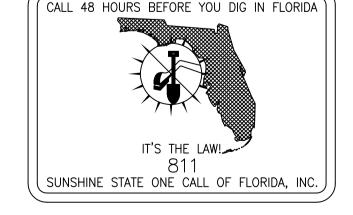

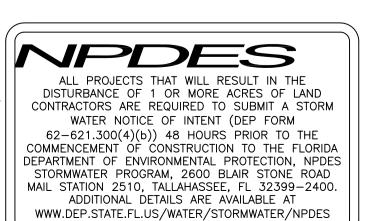

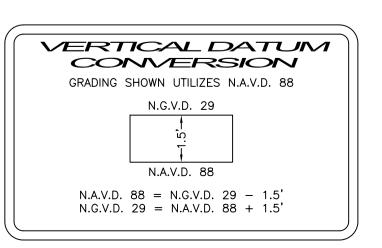

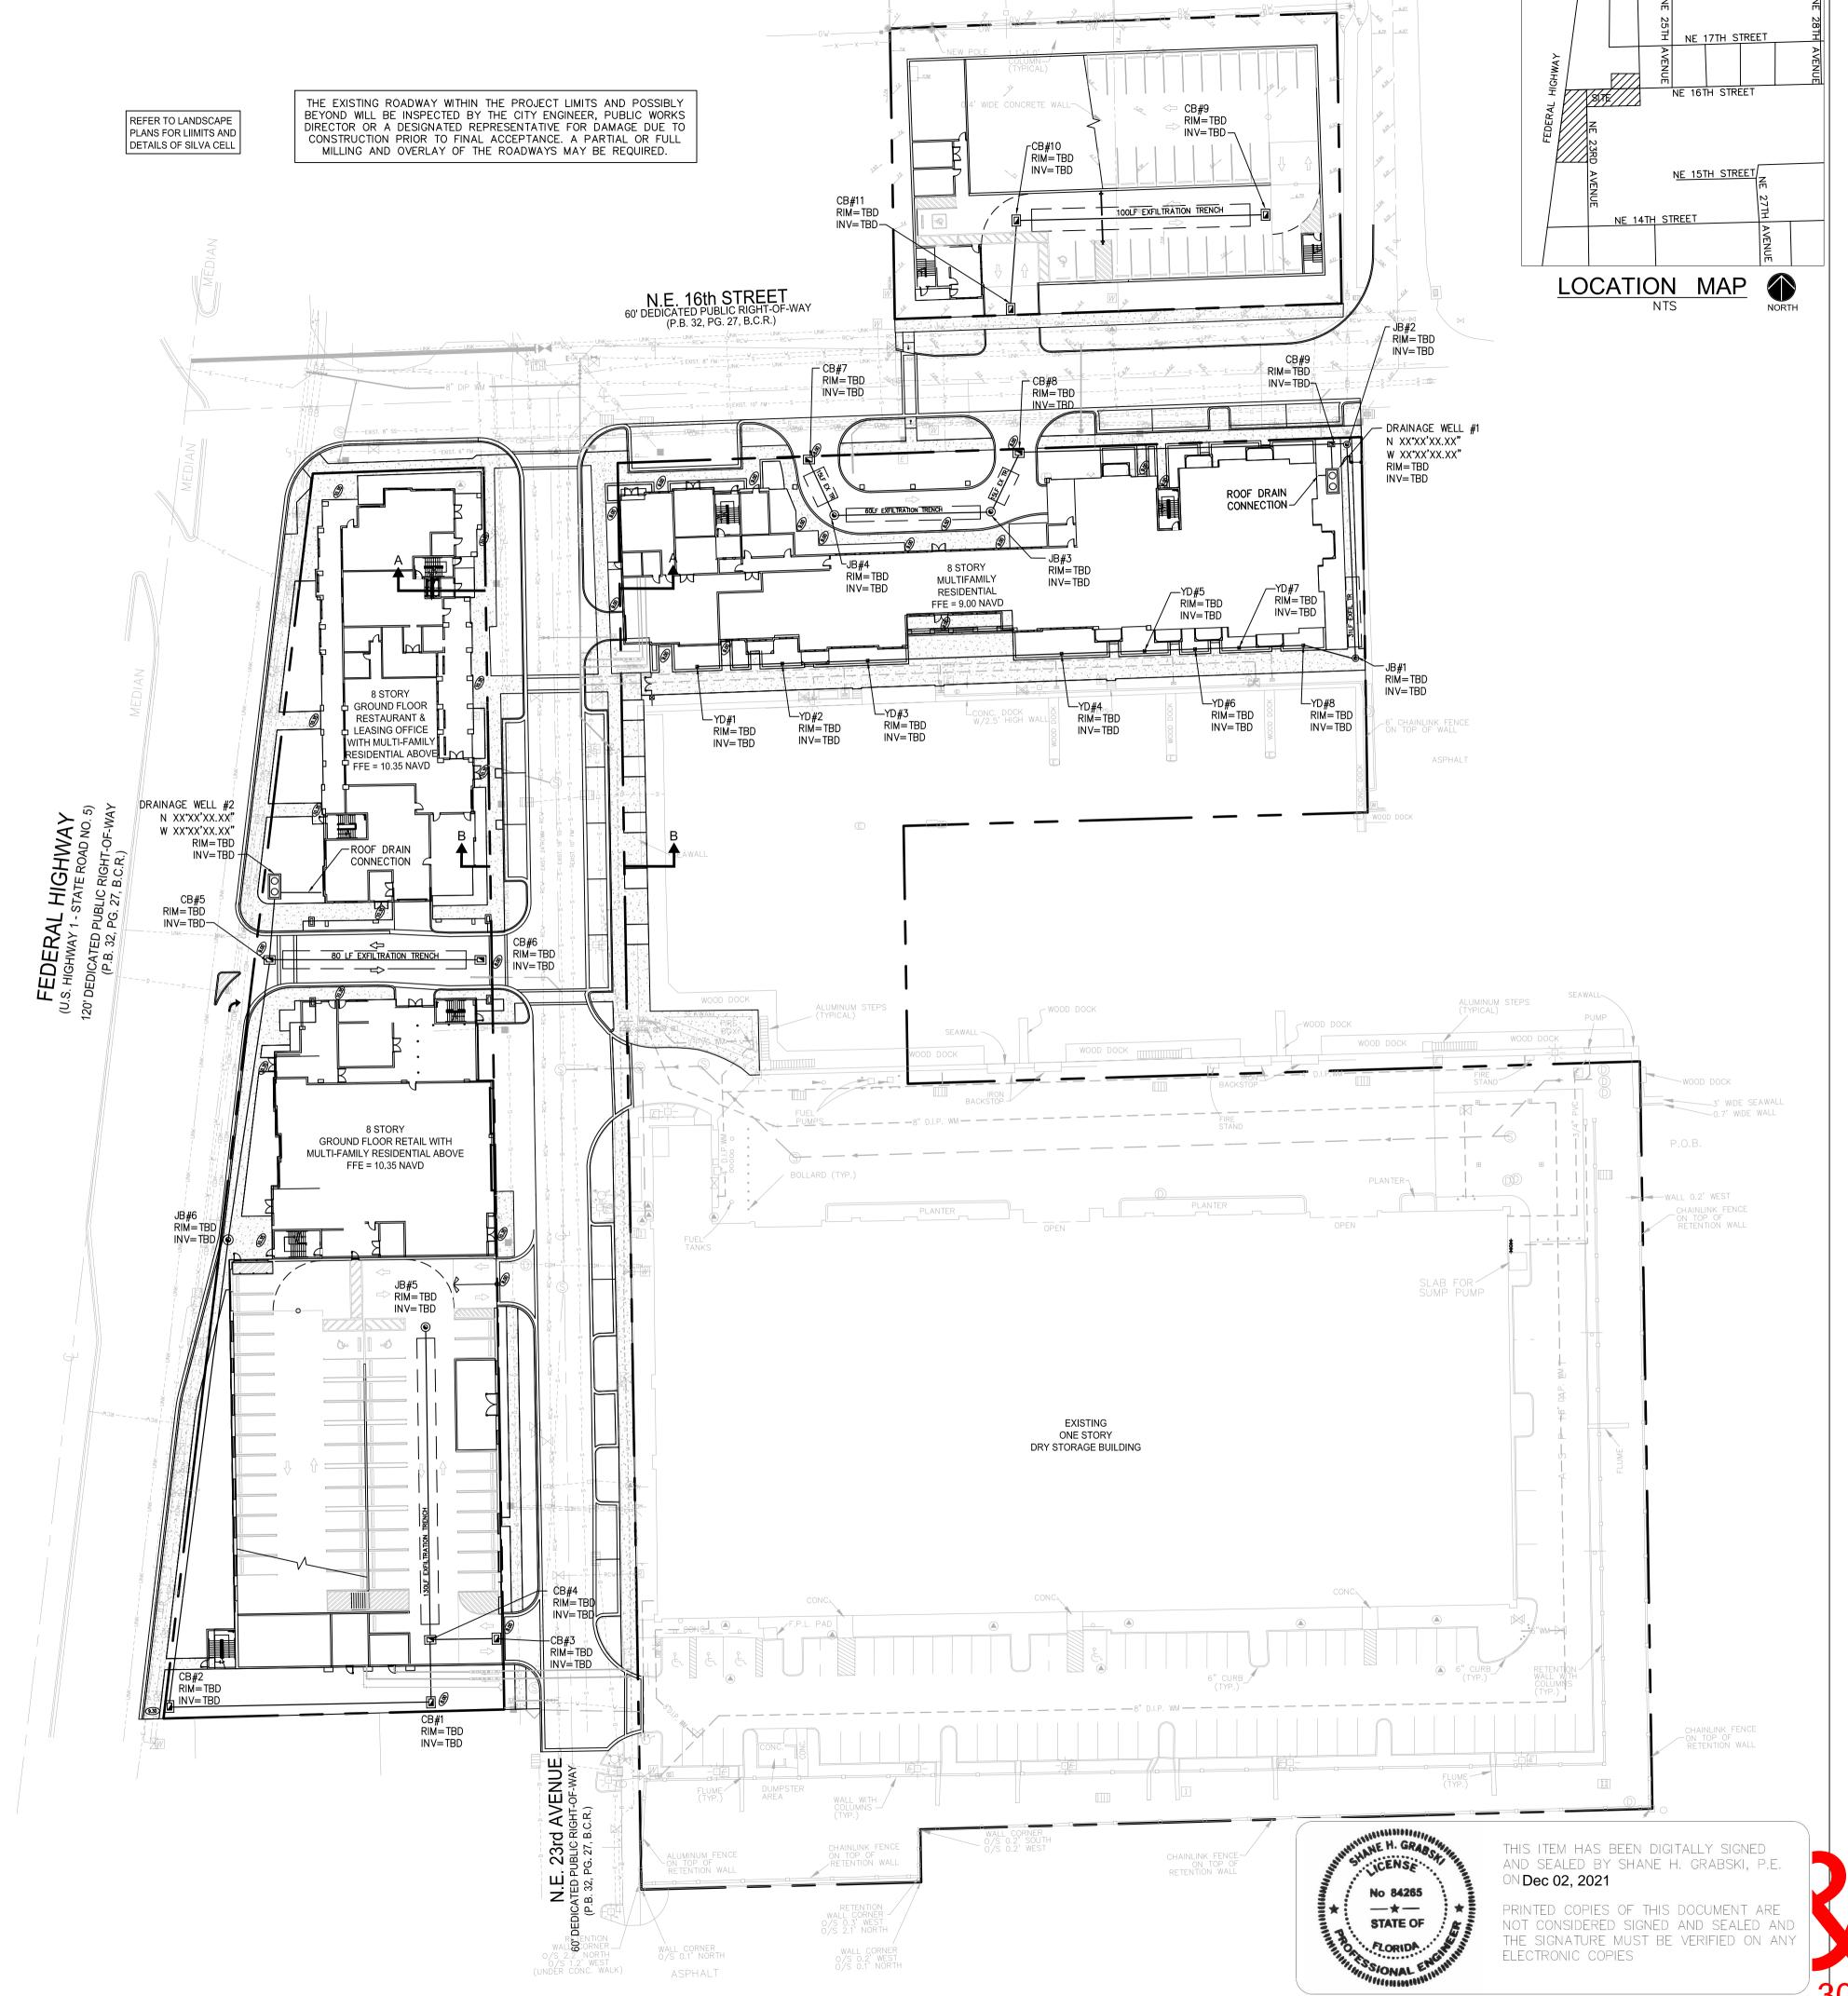

NE 18TH STREET

CONCEPTUAL PAVING, GRADING & DRAINAGE PLAN


NORTH Revisions


Phase: DRC DOCUMENTS


Grabski


Digitally signed by Shane H Grabsl DN: c=US, o=Flynn Engineering Services P.A. dnQualifier=A01410D0000017BA42 5154700004C4C, cn=Shane H Date: 2021.12.02 19:07:12 -05'00'


1"=40' 09/28/21 05-0606.07 12 Drawn by

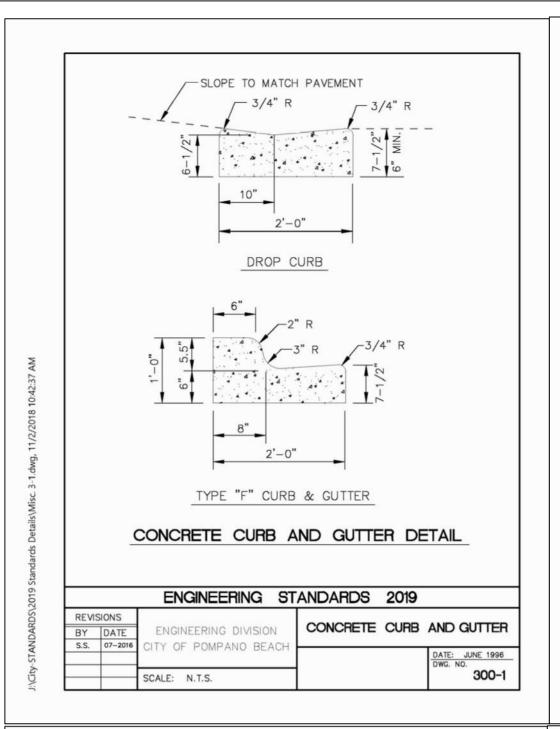


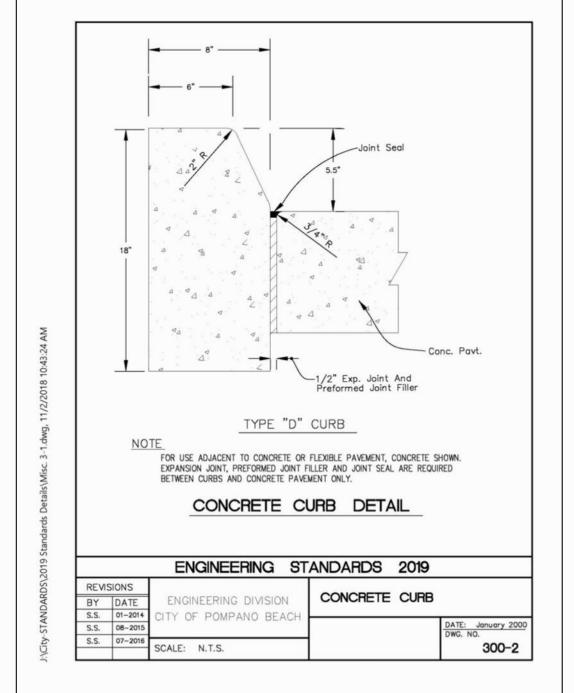


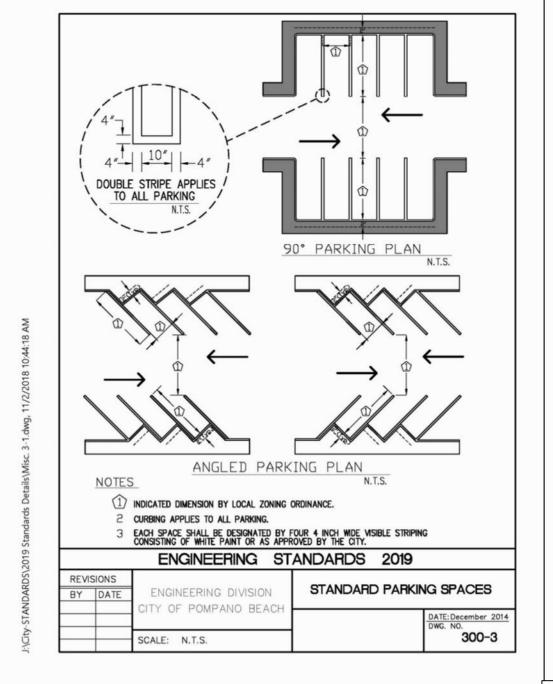


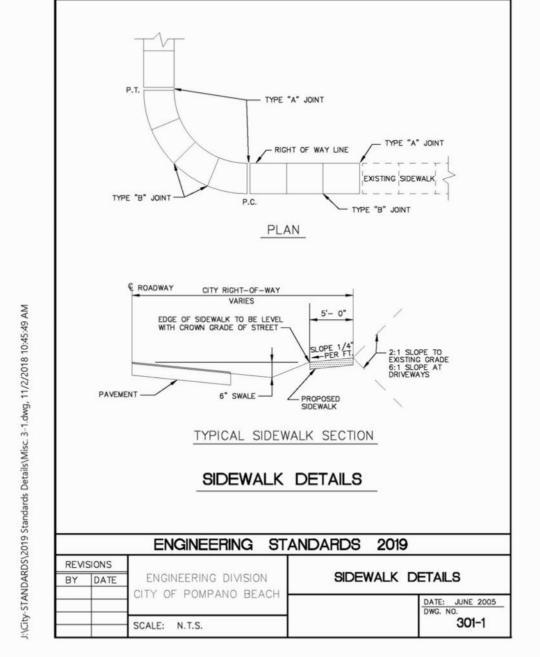


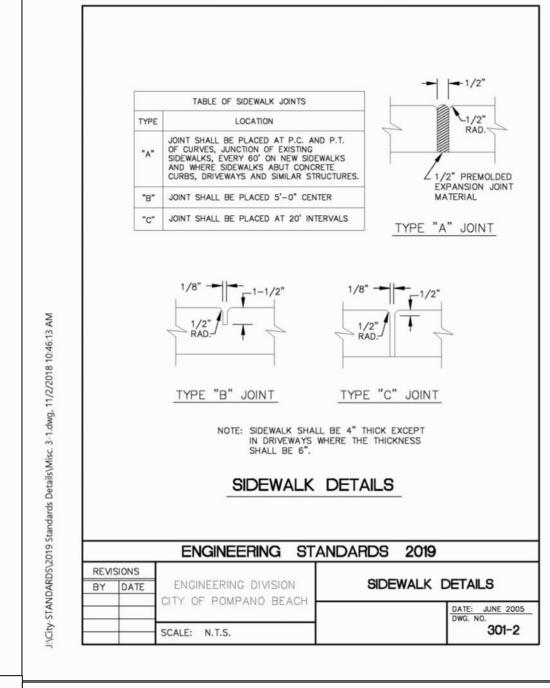


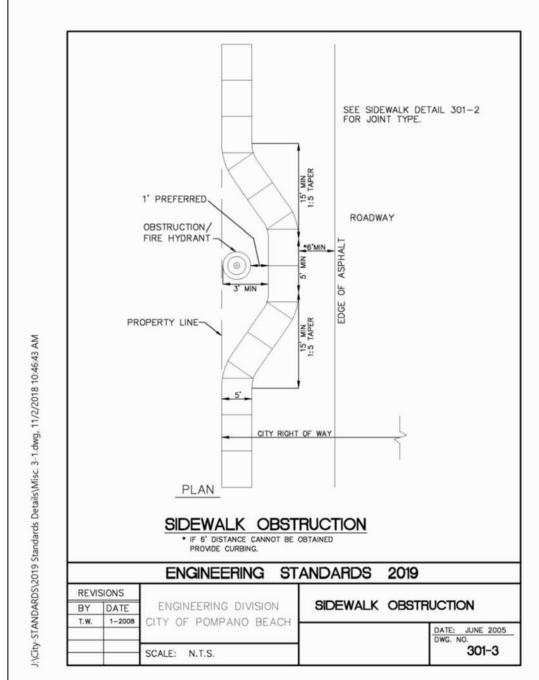


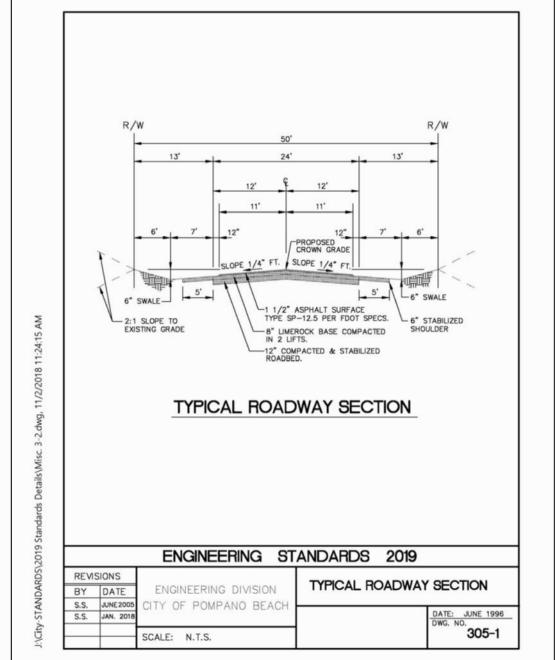


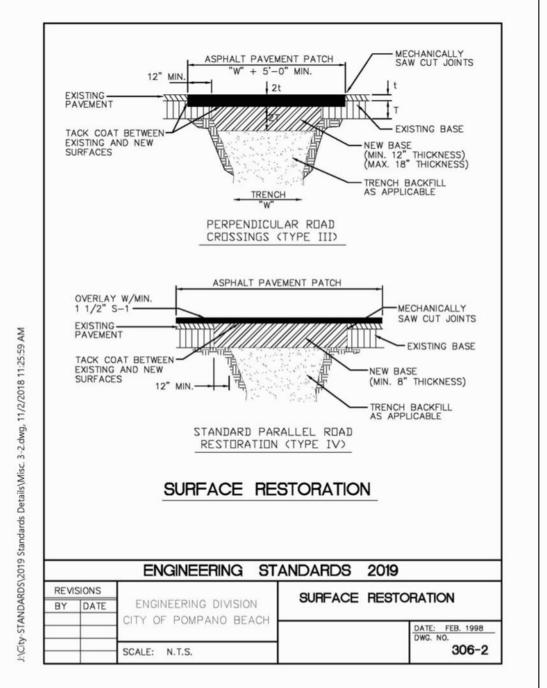

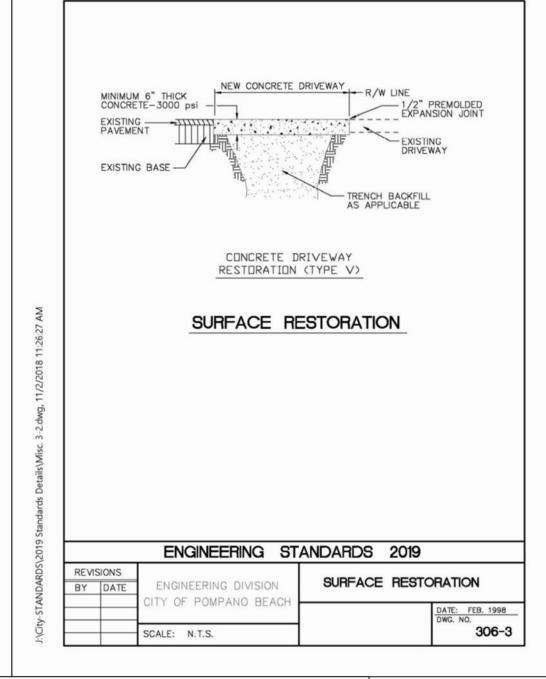

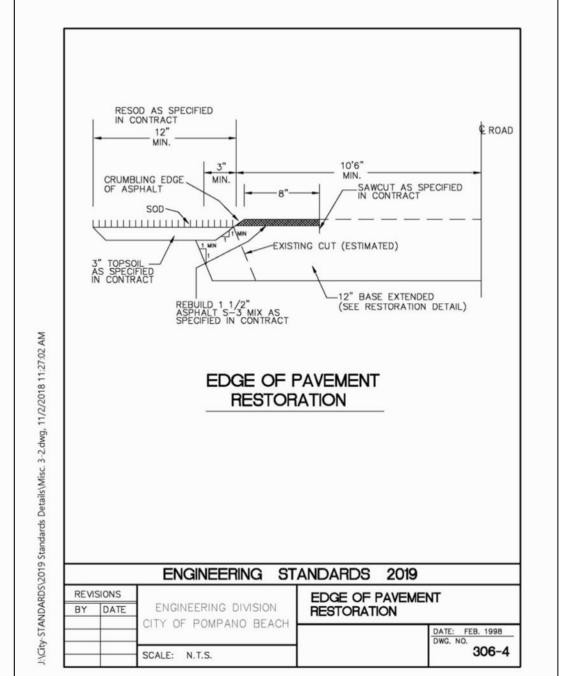

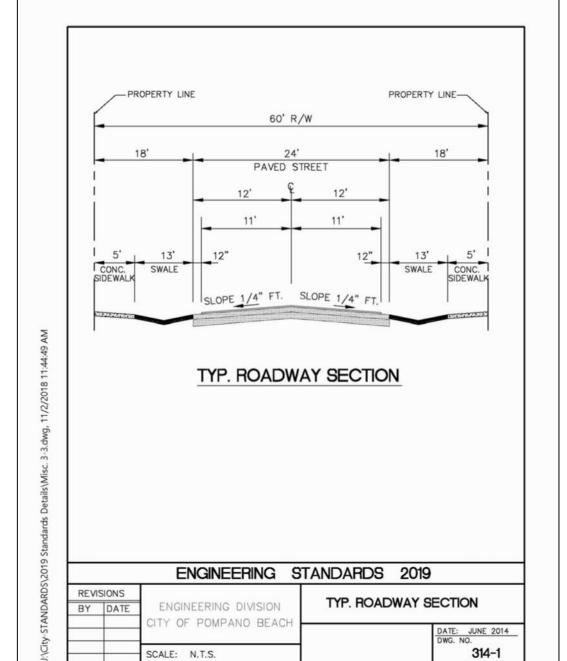

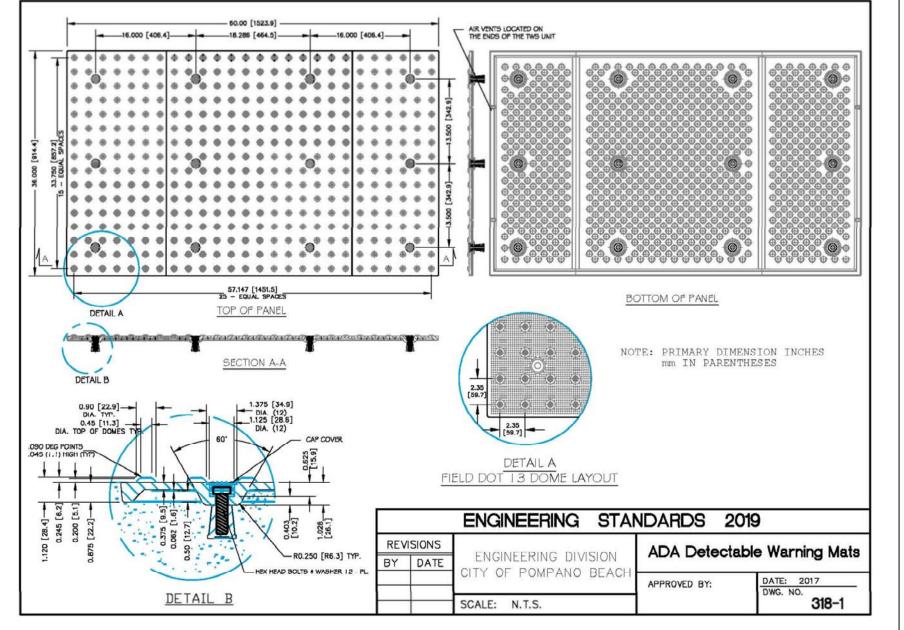



THIS ITEM HAS BEEN DIGITALLY SIGNED AND SEALED BY SHANE H. GRABSKI, P.E. ON Dec 02, 2021


PRINTED COPIES OF THIS DOCUMENT ARE NOT CONSIDERED SIGNED AND SEALED AND THE SIGNATURE MUST BE VERIFIED ON ANY ELECTRONIC COPIES

ENGINEERII

241 COMMERCIAL BLVD., LAUDERDALE—BY-THE—SEA, FL
PHONE: (954) 522–1004 | WWW.FLYNNENGINEERING.C
EB# 6578

STANDARD
PAVING, GRADING, &
DRAINAGE DETAILS

HIDDEN HARBOUR

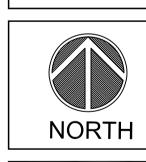

14	
Revision	าร
A 1	T
\triangle	
<u> </u>	
<u>A</u>	
<u> </u>	
<u></u>	
<u> </u>	
Δ	
<u> </u>	
Phase	

Phase:
DRC
DOCUMENTS

Shane H Grabski


Digitally signed by Shane H Grabski DN: c=US, o=Flynn Engineering Services P.A., dnQualifier=A01410D0000017BA42 5154700004C4C, cn=Shane H Grabski Date: 2021.12.02 19:01:51 -05'00'


Scale:
1"=40' 11/05/19


Job No.
05-0606.06 12/2 21


Drawn by Sh No.
MDI
oj. Mgr.
DTR


Appr. b 2 of 6

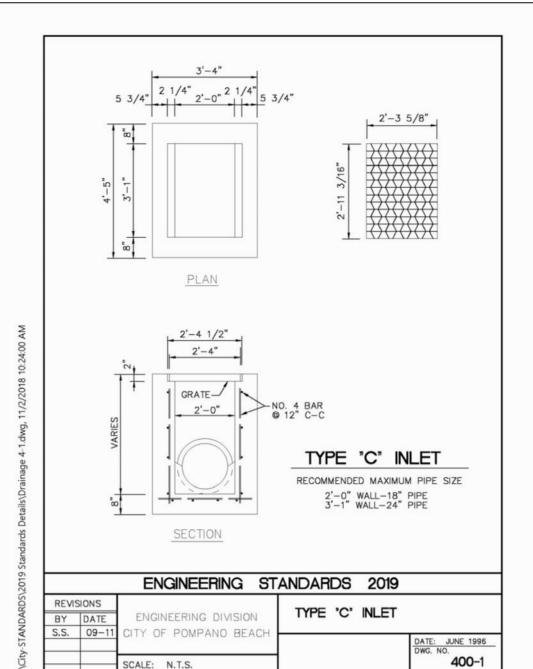

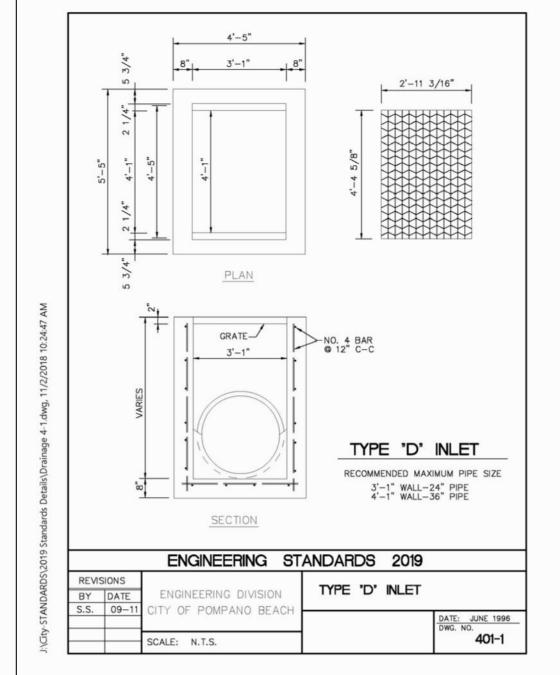


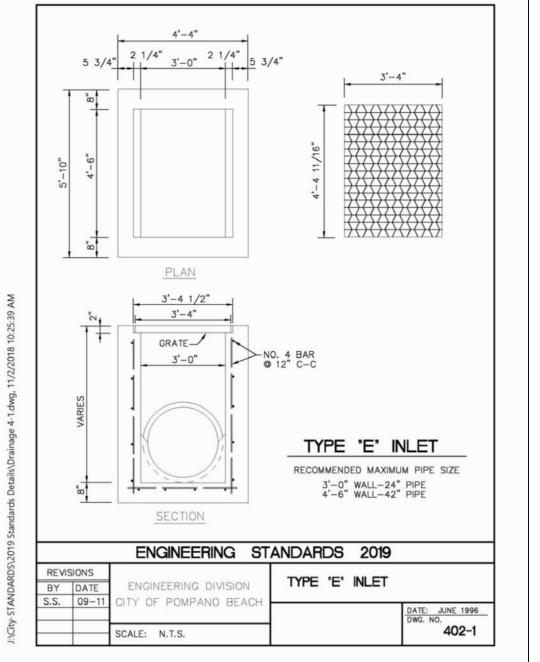


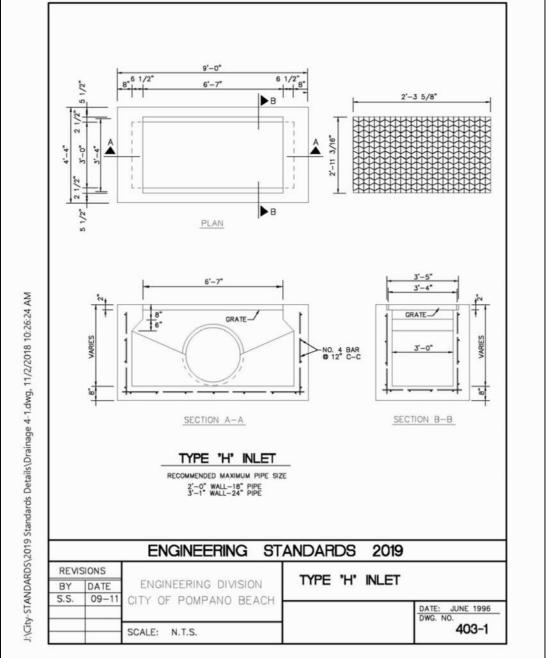


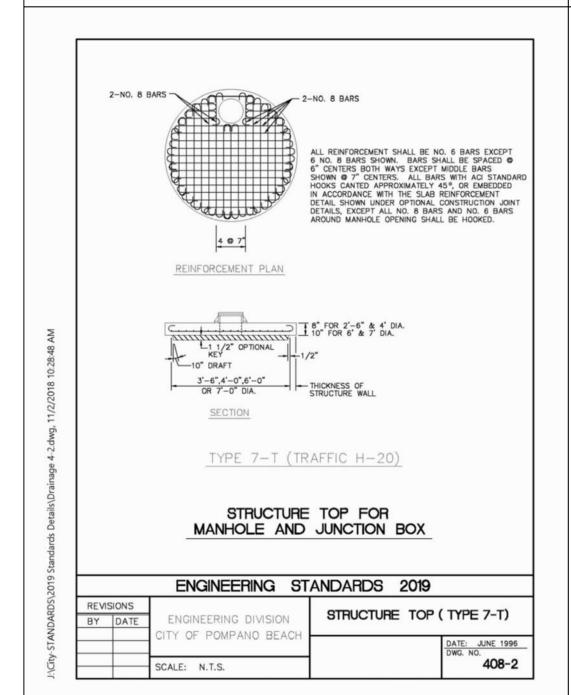



SCALE: N.T.S.

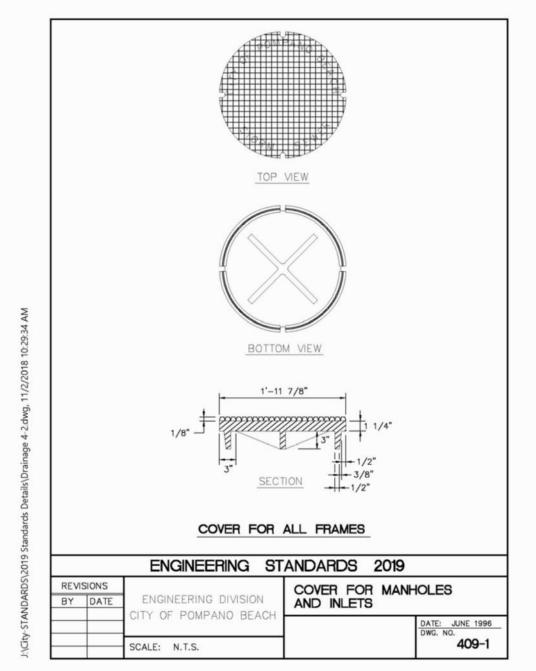


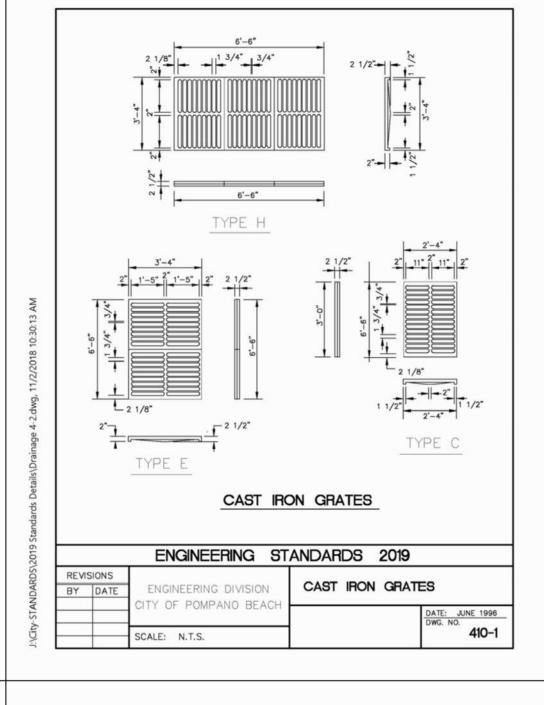


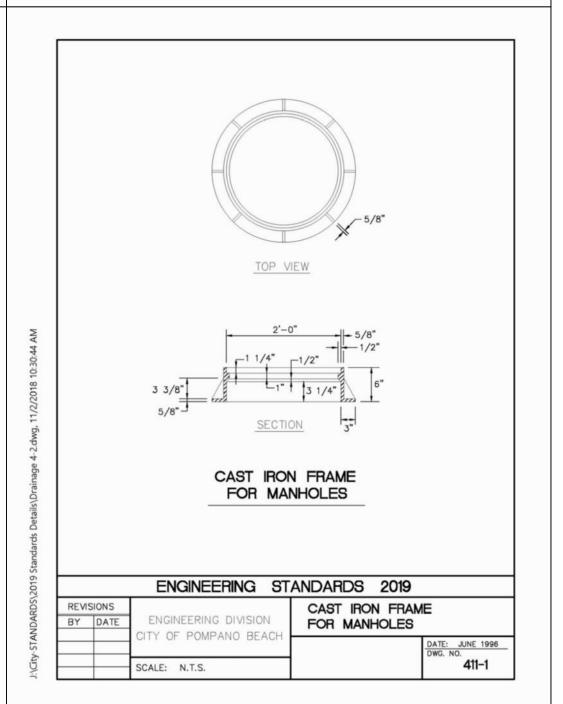


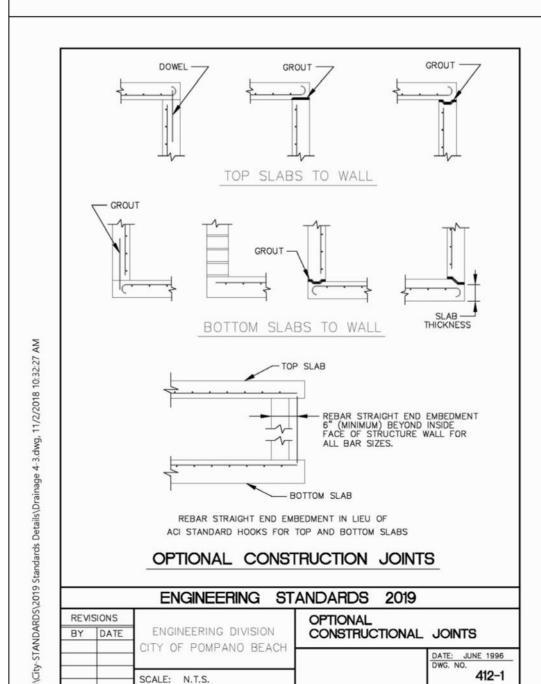

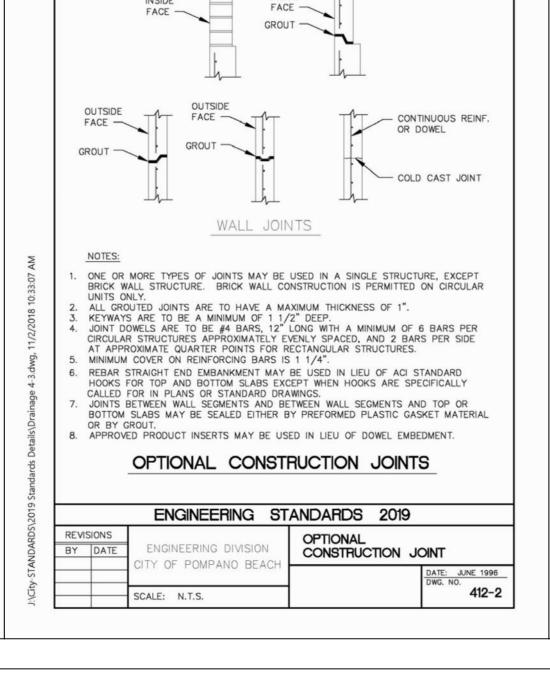

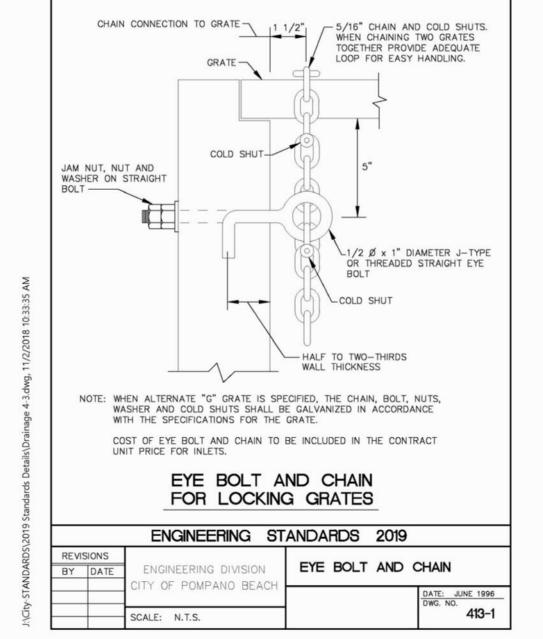


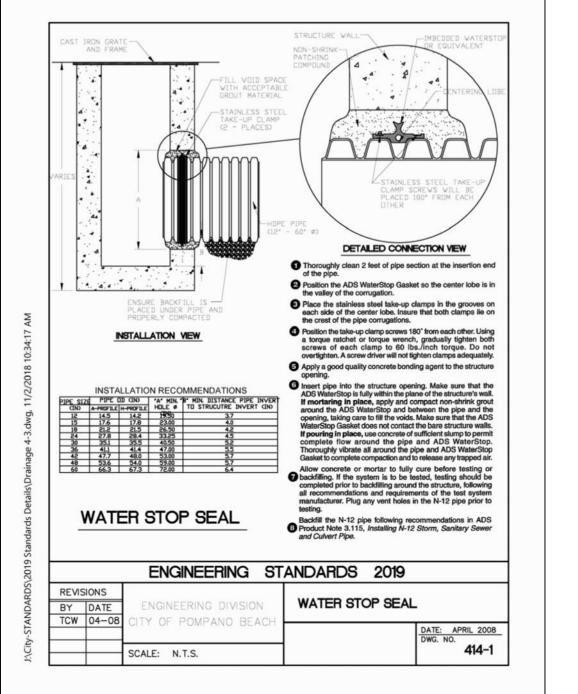

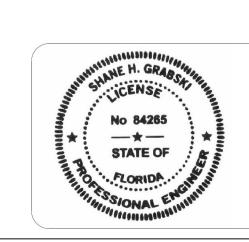




PRINTED COPIES OF THIS DOCUMENT ARE NOT CONSIDERED SIGNED AND SEALED AND THE SIGNATURE MUST BE VERIFIED ON ANY ELECTRONIC COPIES

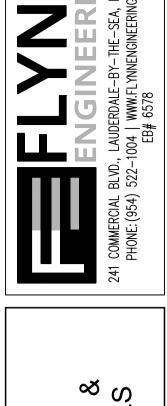

STANDARD
PAVING, GRADING, DRAINAGE DETAILS

HARBOUR

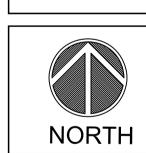

Revisions
\triangle
<u>A</u>
<u>A</u>
<u> </u>
<u>/\$</u>
<u>6</u>
\triangle
<u> </u>
Phase:

DOCUMENTS

Grabski Digitally signed by Shane H Grabski DN: c=US, o=Flynn Engineering Services P.A., dnQualifier=A01410D0000017BA42


5154700004C4C, cn=Shane H

Date: 2021.12.02 19:03:37 -05'00'

Shane H

Scale: Date 1"=40' 11/05/19 05-0606.06 12/ Drawn by MDI

oj. Mgr.

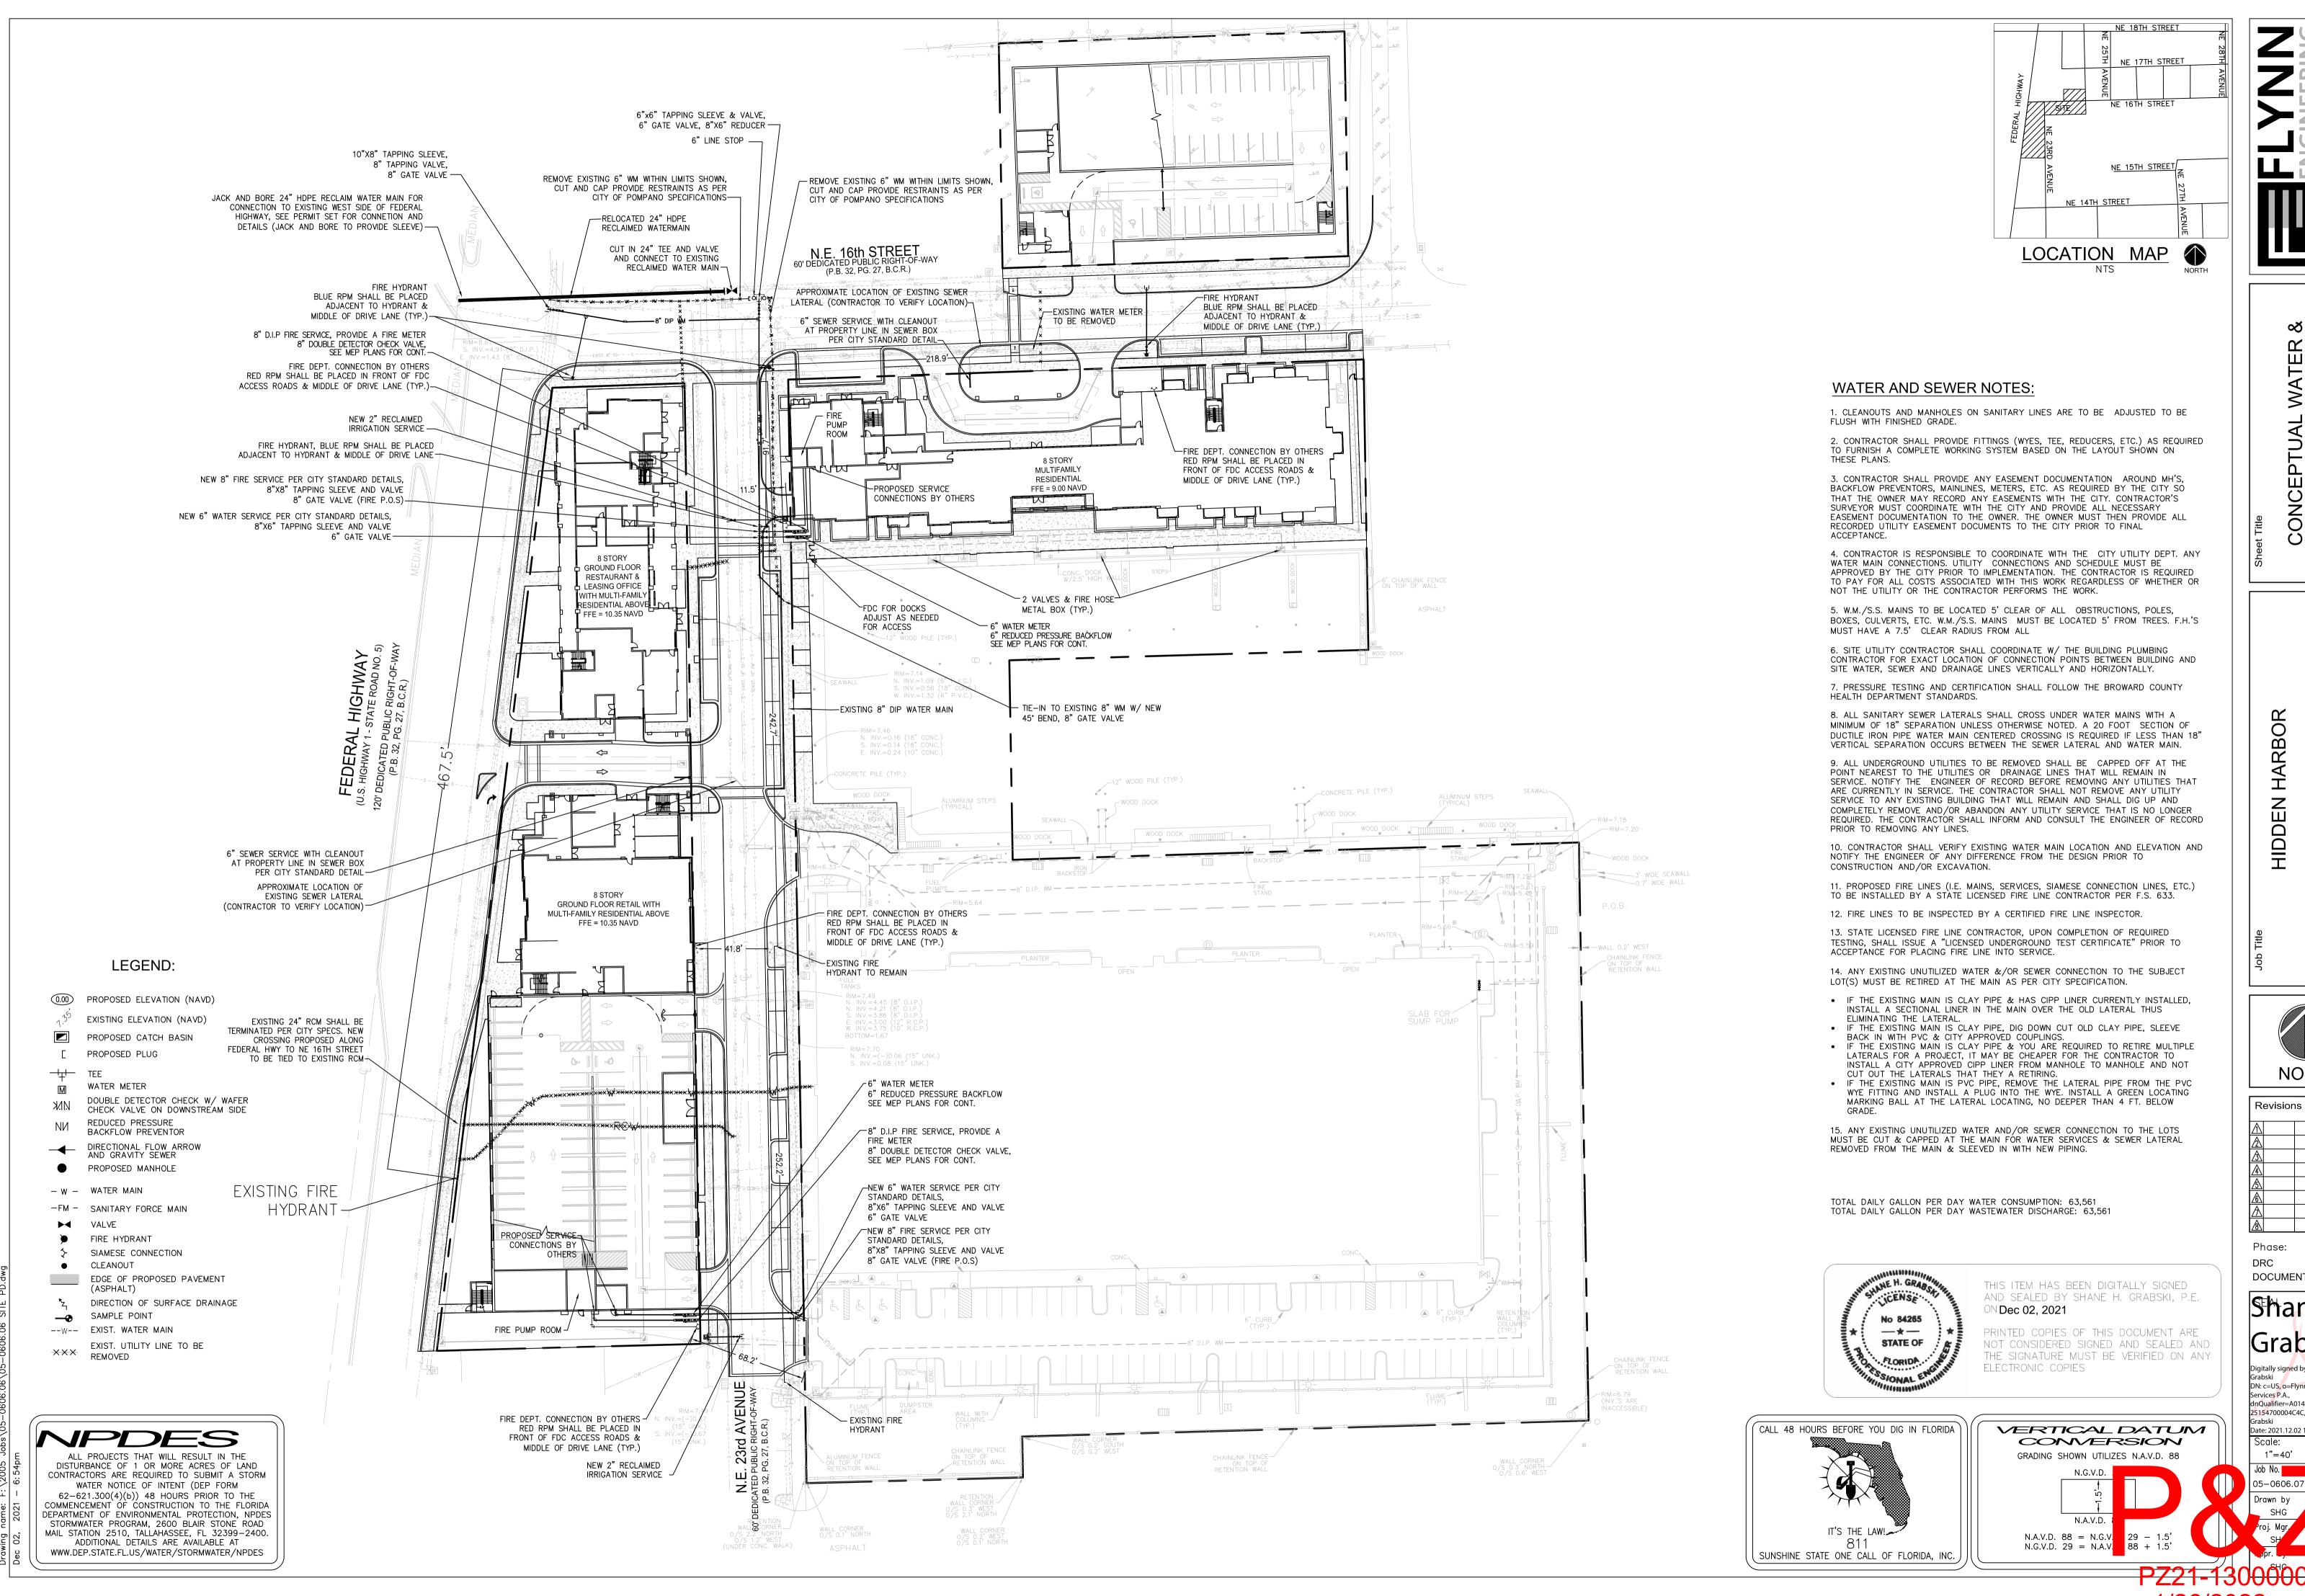

 $\overline{\leq}$ EPTU, SEWE



Revisions


DOCUMENTS

Grabski

Digitally signed by Shane H DN: c=US, o=Flynn Engineering InQualifier=A01410D0000017BA4 25154700004C4C, cn=Shane H


Date: 2021.12.02 19:07:42 -05'00' 09/28/21


5-0606.07

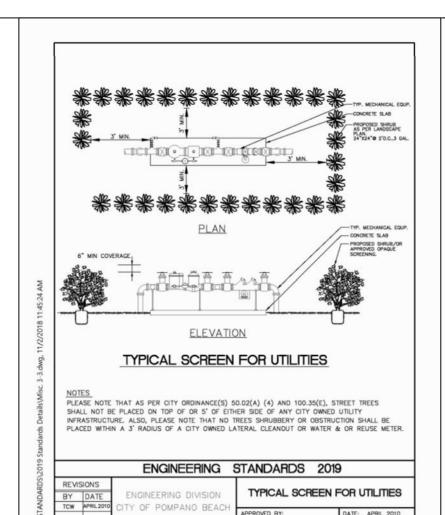



SCALE: N.T.S.

315-1

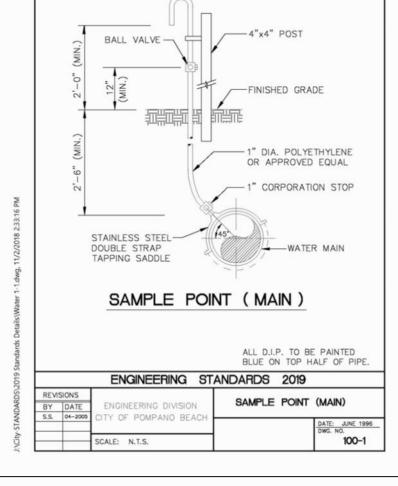

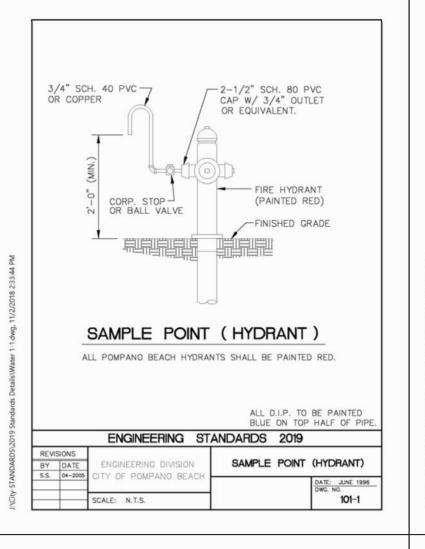

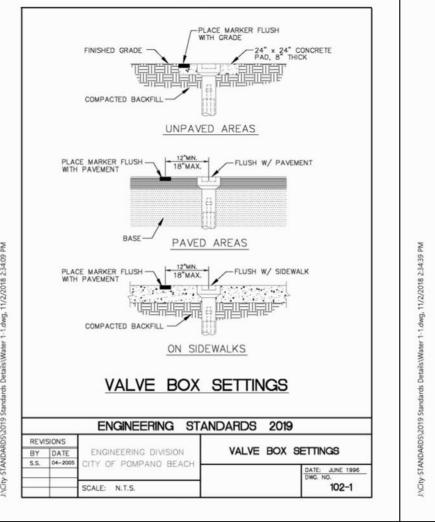

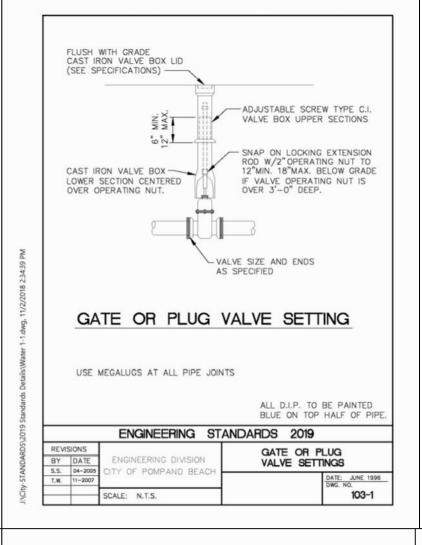



R/W OR EASEMENT LINE WHERE APPLICABLE


FINISHED GRAD


109-1

-BURY LINE

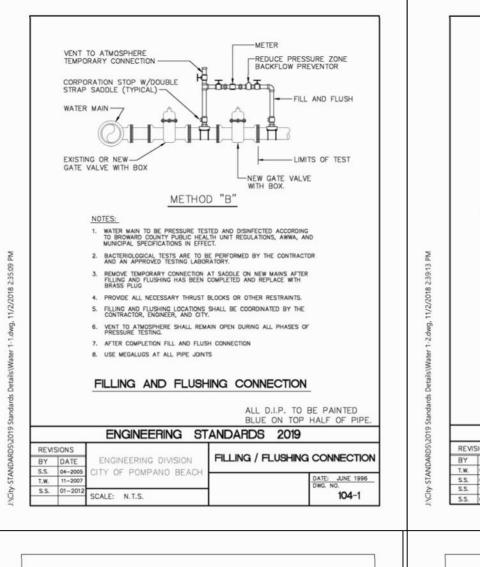


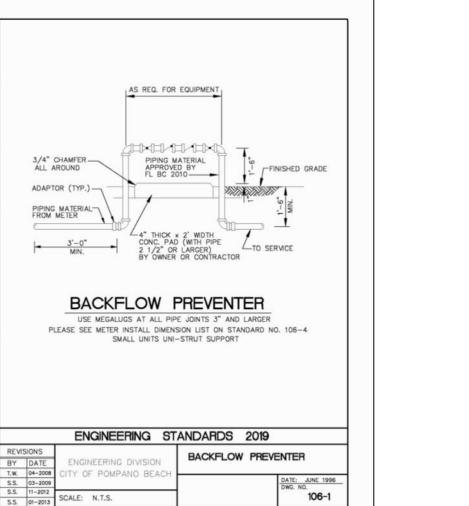


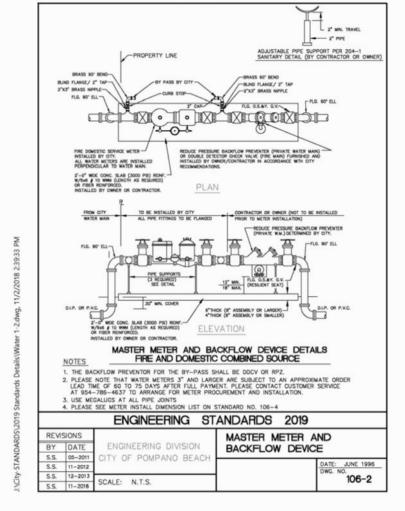


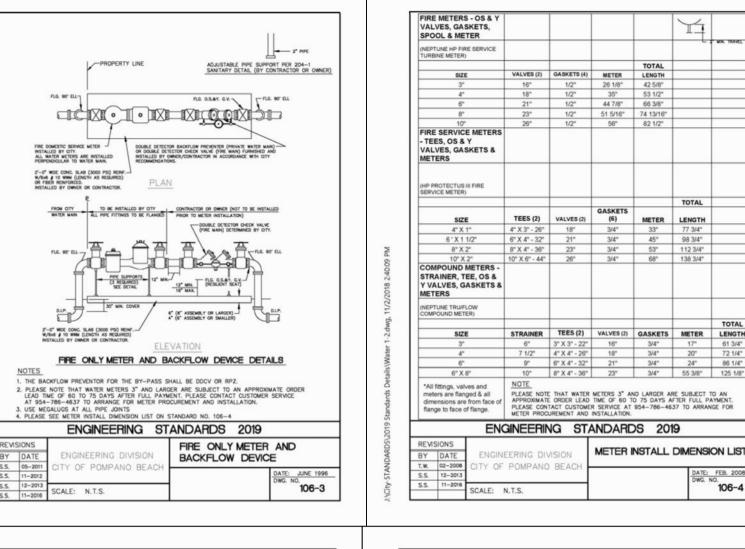





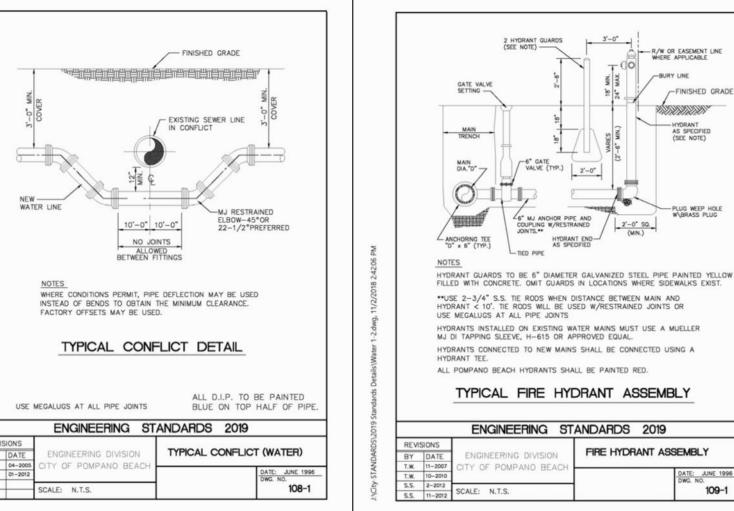


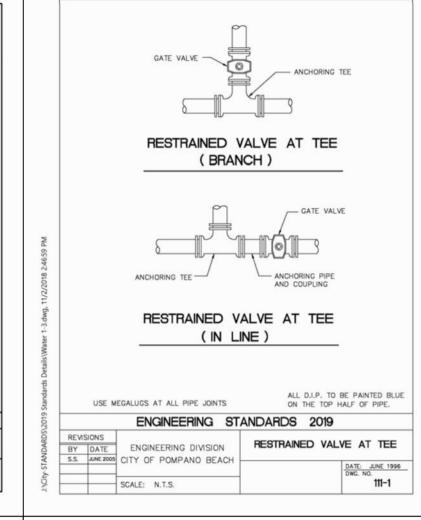


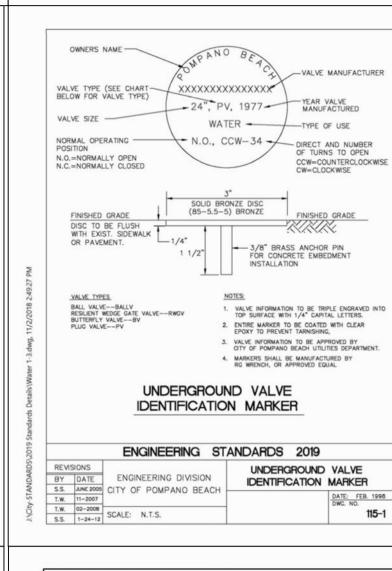


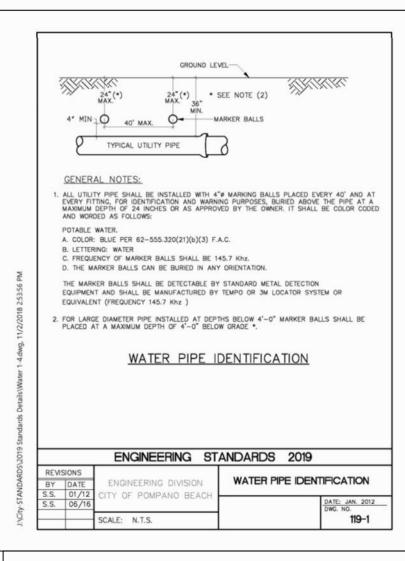


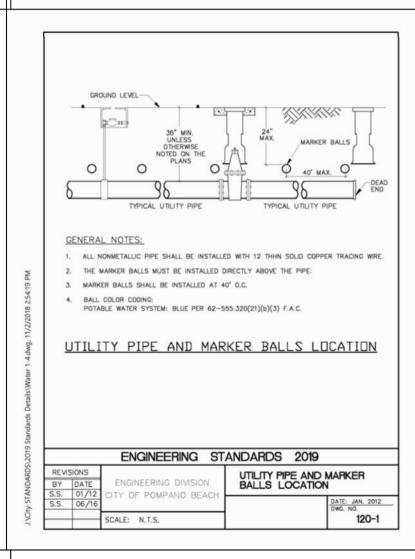


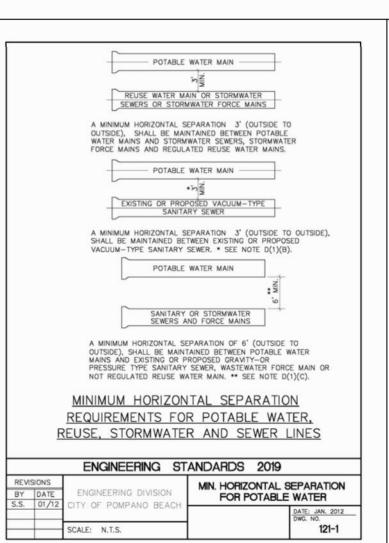


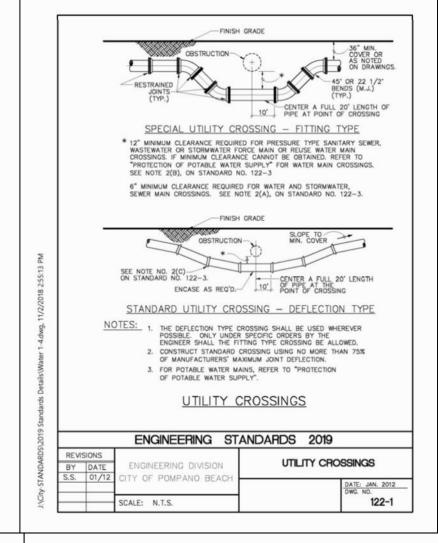


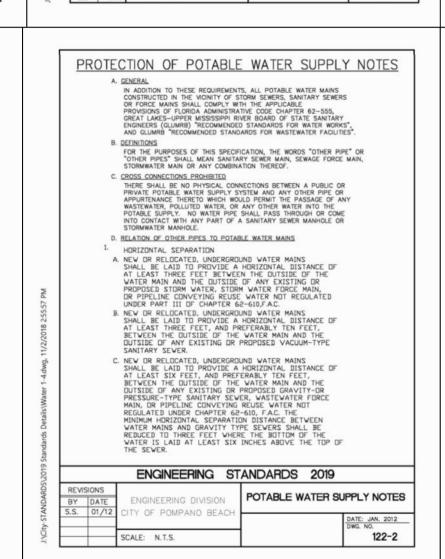

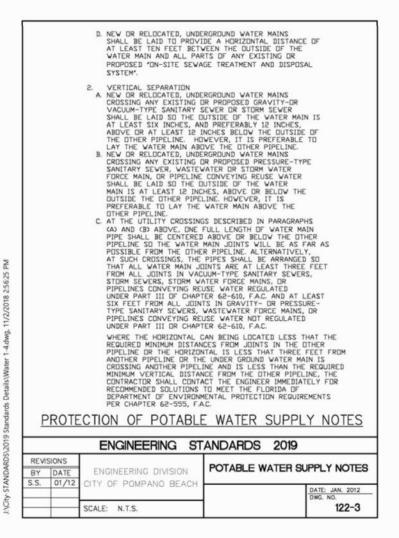

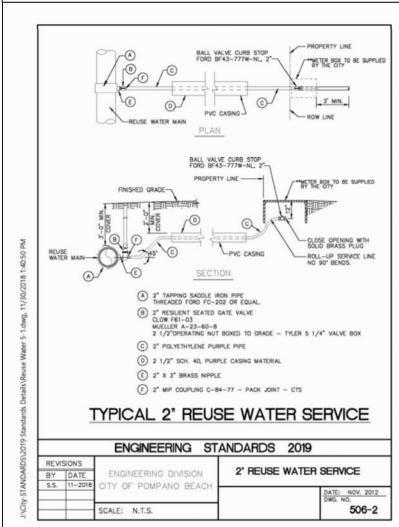


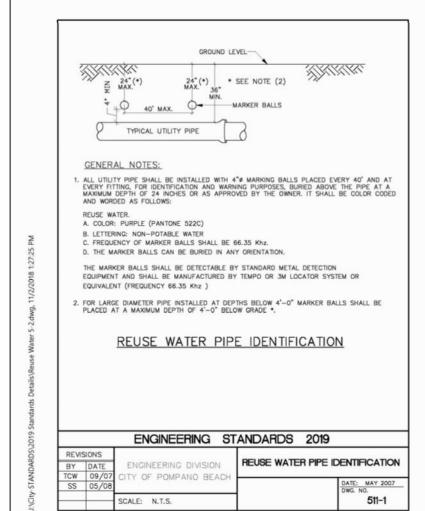


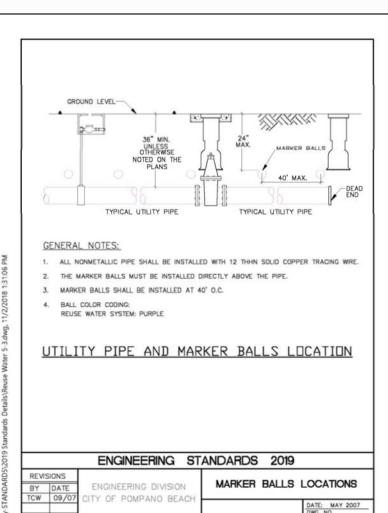



SCALE: N.T.S.

512-1

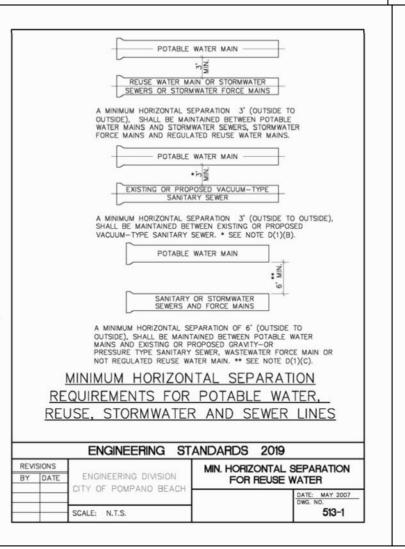

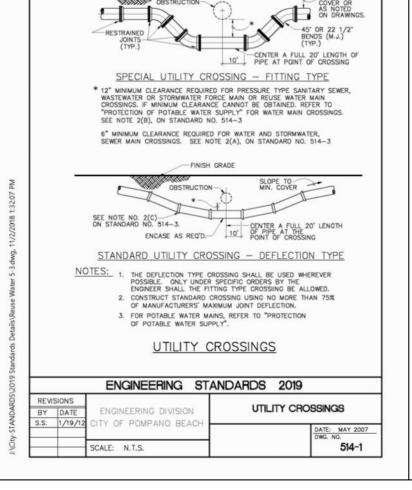


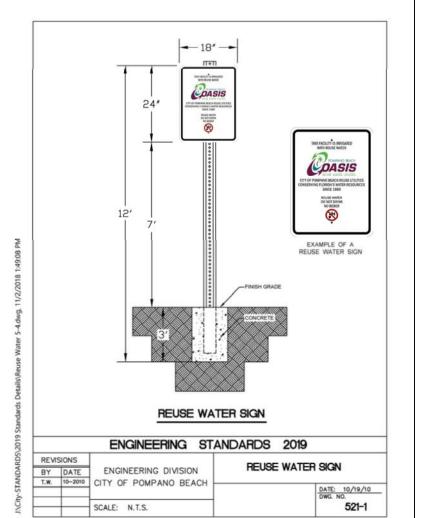

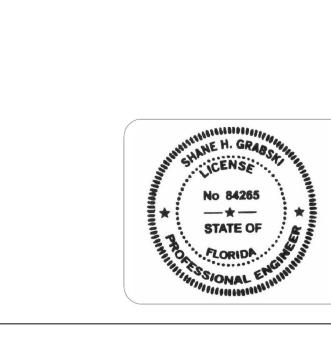



PRINTED COPIES OF THIS DOCUMENT ARE NOT CONSIDERED SIGNED AND SEALED AND THE SIGNATURE MUST BE VERIFIED ON ANY ELECTRONIC COPIES

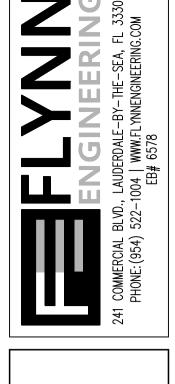

ER


	N	ORTH	
R	evisior	าร	-
Λ			
<u> </u>			
<u> </u>			
A			
<u>\$</u>			
<u> </u>			
			_
<u> </u>			_
DI	Phase		


Phase: DRC DOCUMENTS


Grabski


N: c=US, o=Flynn Engineering Services P.A., dnOualifier=A01410D0000017BA42 \$154700004C4C, cn=Shane H Date: 2021.12.02 19:15:48 -05'00' Scale: 1"=40' 11/05/19


05-0606.06 12/ Drawn by MDI oj. Mgr.

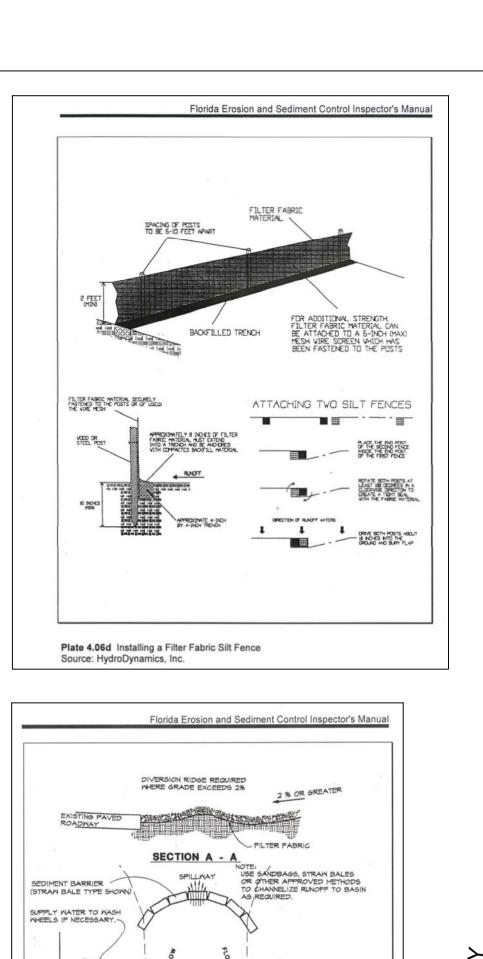


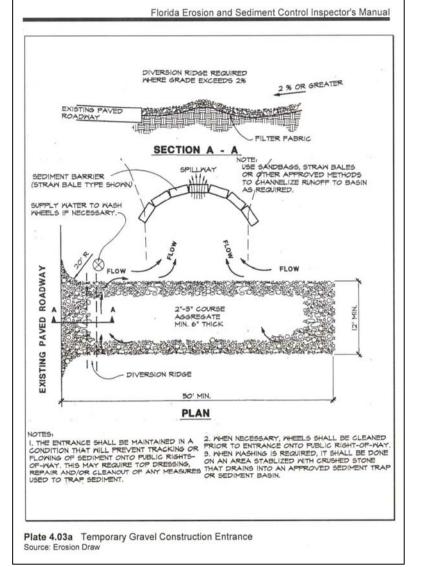

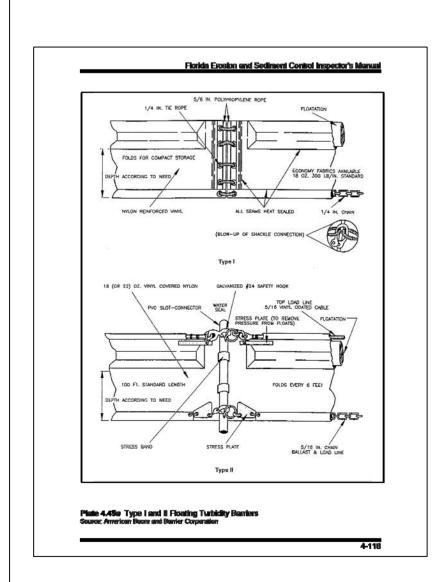

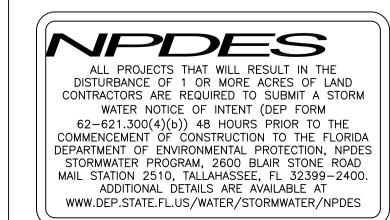

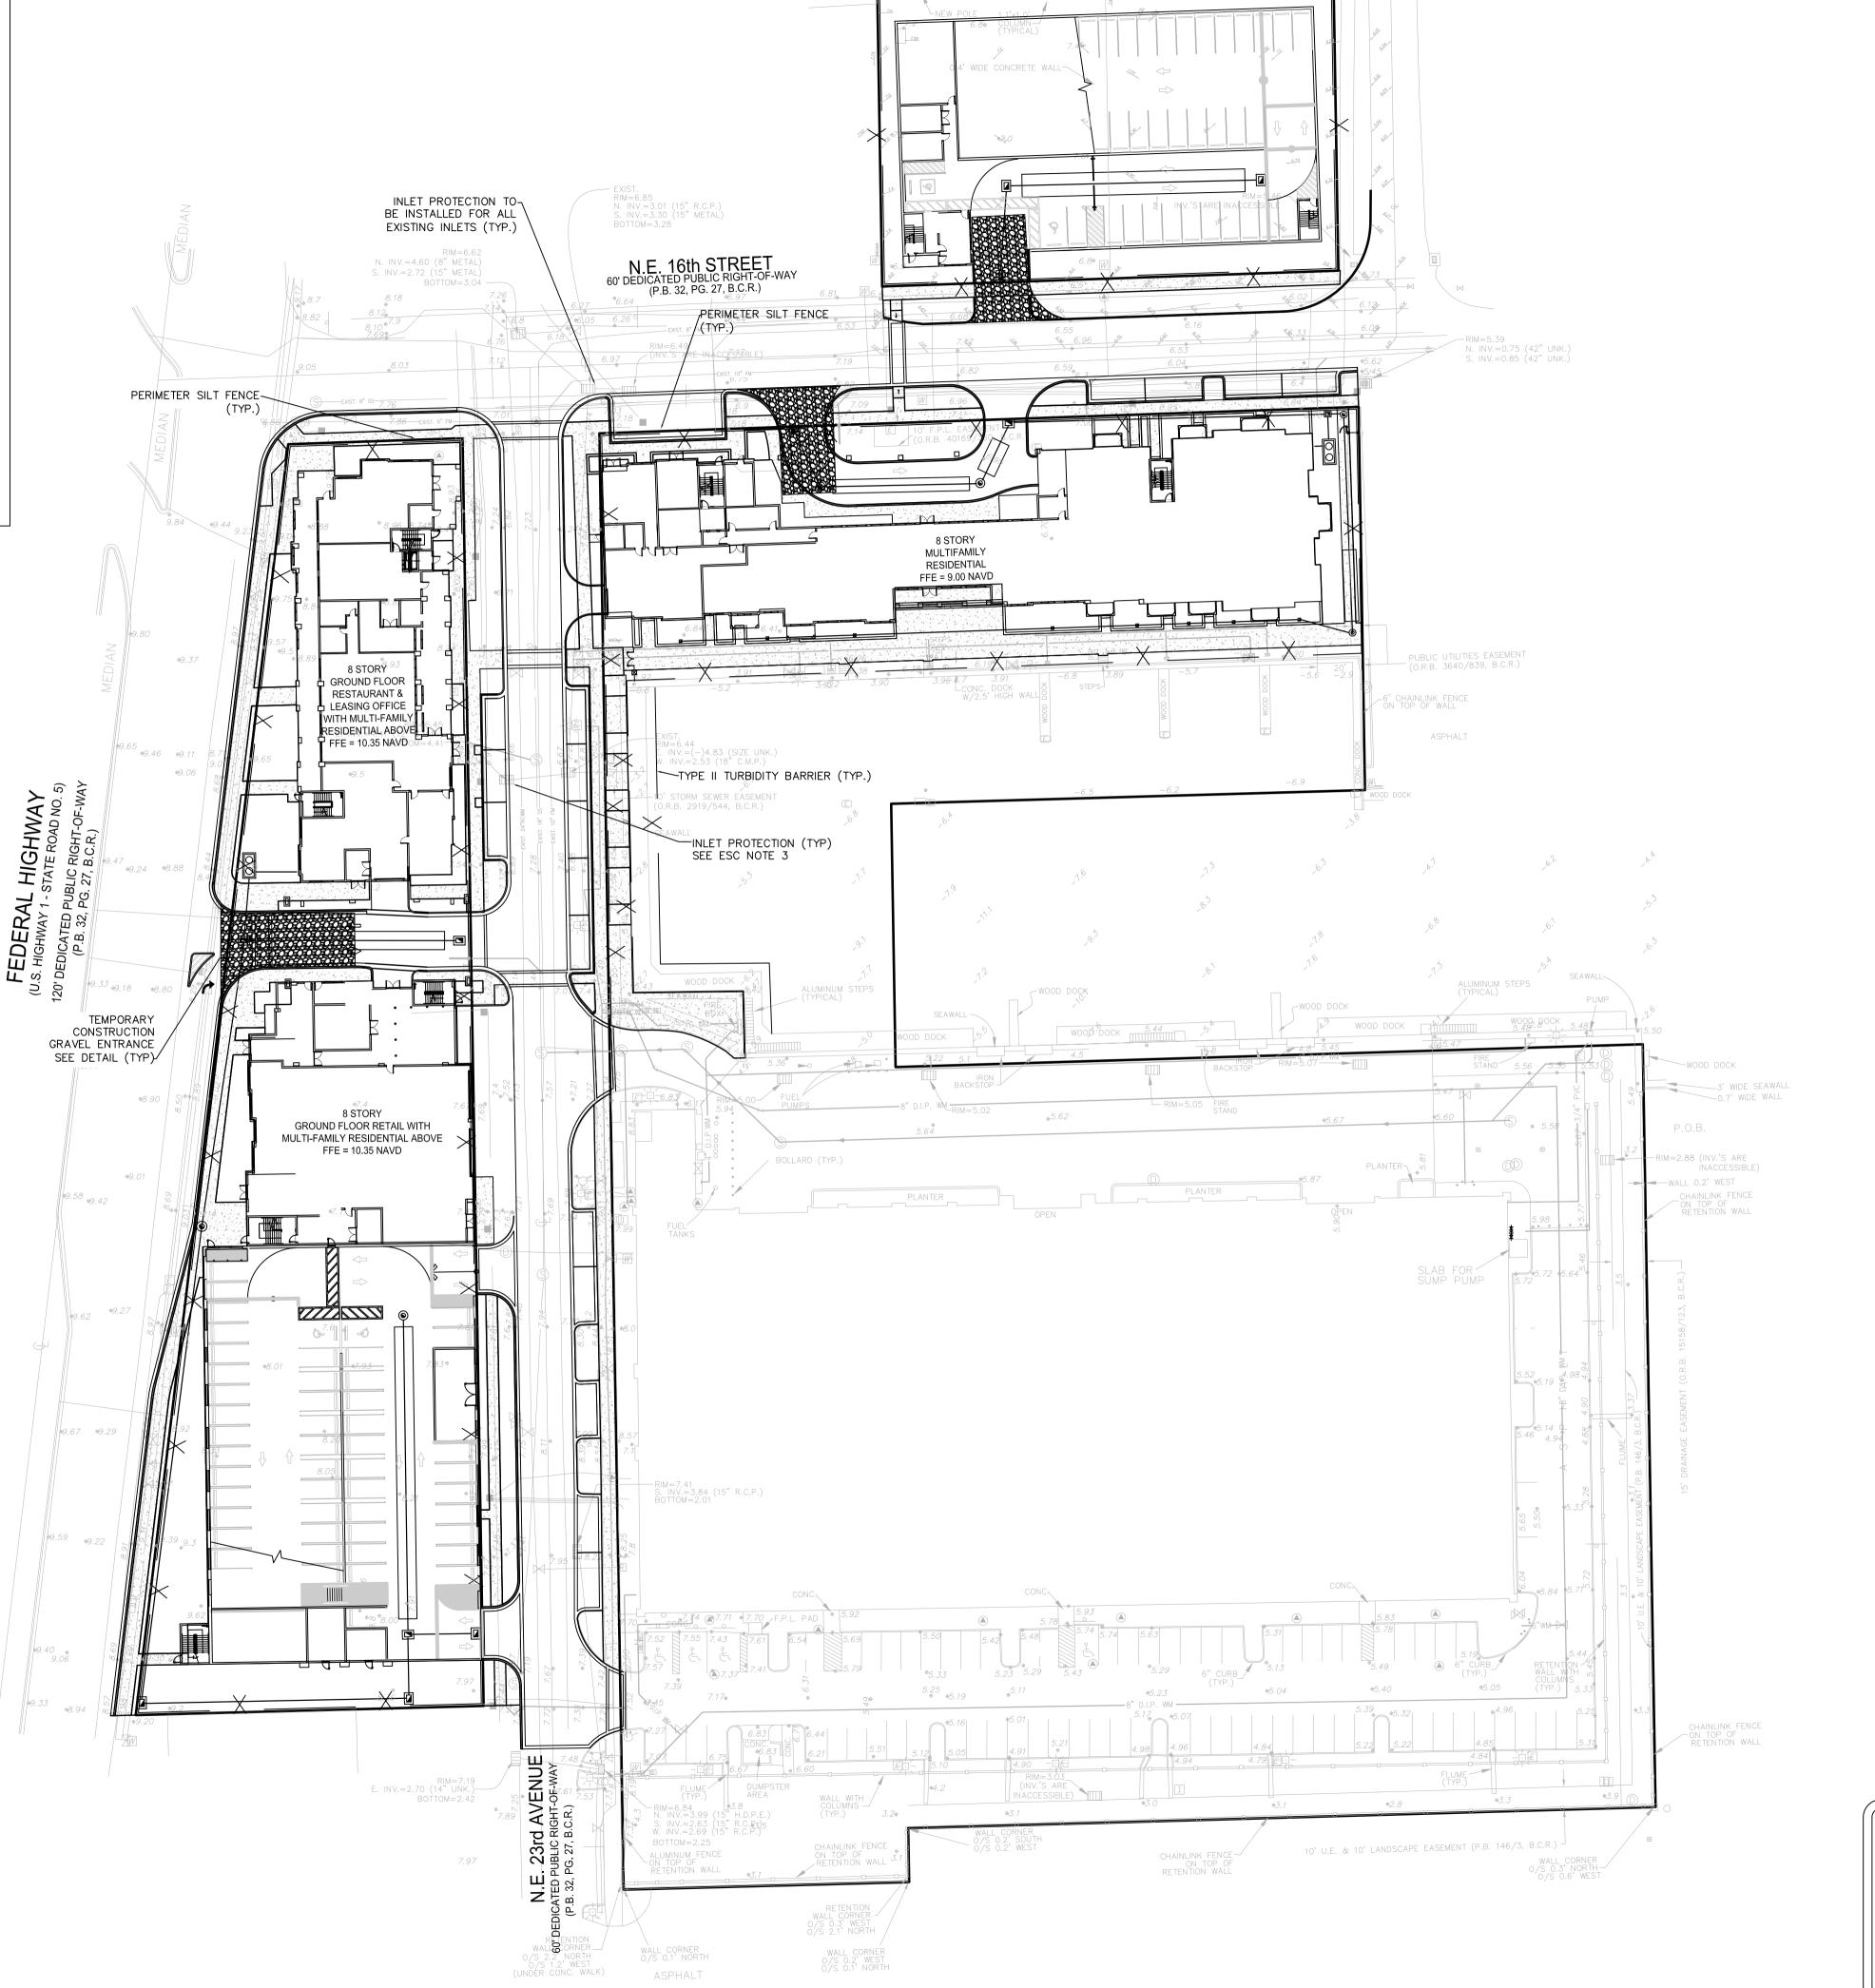

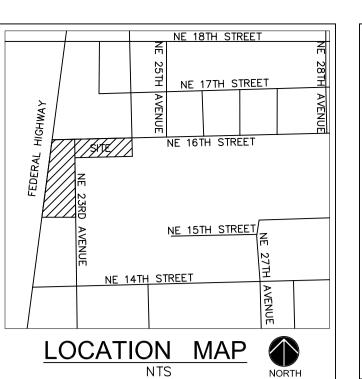


ESC NOTES:

- 1. THIS PLAN REFLECTS THE ENGINEER'S SUGGESTION FOR EROSION AND SEDIMENT CONTROL. SITE OPERATOR TO MODIFY PLAN AS NEEDED TO MAINTAIN "BEST MANAGEMENT PRACTICES" DURING CONSTRUCTION.
- 2. AT ALL TIMES DURING CONSTRUCTION, ALL STORMWATER MUST REMAIN ONSITE. NO DISCHARGE INTO THE PUBLIC RIGHT OF WAY OR ADJOINING PROPERTIES IS ALLOWED.
- 3. DRAINAGE STRUCTURES INSTALLED TO BE PROTECTED WITH FILTER FABRIC AND/OR PERIMETER SILT FENCE. 4. PROVIDE FILTER FABRIC OR OTHER METHOD OF


SEDIMENT PROTECTION FOR ANY EXISTING CATCH

- BASIN/INLET WITHIN 100 FEET OF THE PROJECT AREA. 5. ANY SEDIMENT THAT IS TRACKED ONTO ROADS MUST BE SWEPT UP IMMEDIATELY.
- 6. SEDIMENT SHALL NOT BE REMOVED BY WASHING/FLUSHING WITH WATER AT THE RIGHT OF WAY.
- 7. PRIOR TO START OF CONSTRUCTION, AN ENGINEERING ROUGH INSPECTION MUST BE SCHEDULED TO VERIFY EROSION AND SEDIMENTATION CONTROL IS SETUP PROPERLY AND SO INSPECTOR CAN MONITOR SITE FOR CONSTRUCTION MITIGATION.

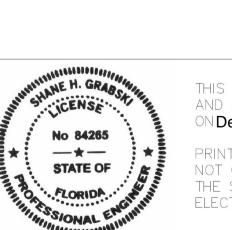

THIS ITEM HAS BEEN DIGITALLY SIGNED AND SEALED BY SHANE H. GRABSKI, P.E. ON Dec 02, 2021

PRINTED COPIES OF THIS DOCUMENT ARE NOT CONSIDERED SIGNED AND SEALED AND THE SIGNATURE MUST BE VERIFIED ON ANY ELECTRONIC COPIES

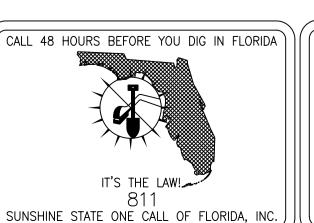

VERTICAL DATUM CONVERSION GRADING SHOWN UTILIZES N.A.V.D. 88 N.A.V.D. N.A.V.D. 88 = N.G.V.DN.G.V.D. 29 = N.A.V.D

EPTUAL EROSION ENT CONTROL PLA CONCE

H




R	evisior	าร
$\overline{\mathbb{A}}$		
⇗		
<u> </u>		
<u> </u>		
Ճ		
${}^{\lozenge}$		
$\overline{\mathbb{A}}$		
<u>&</u>		
Pł	use.	

DRC DOCUMENTS

DN: c=US, o=Flynn Engineering Services P.A., dnQualifier=A01410D0000017BA42 5 54700004C4C, cn=Shane H

Date: 2021.12.02 18:56:31 -05'00' Scale: 1"=40' 10/25/19


1/26/2022

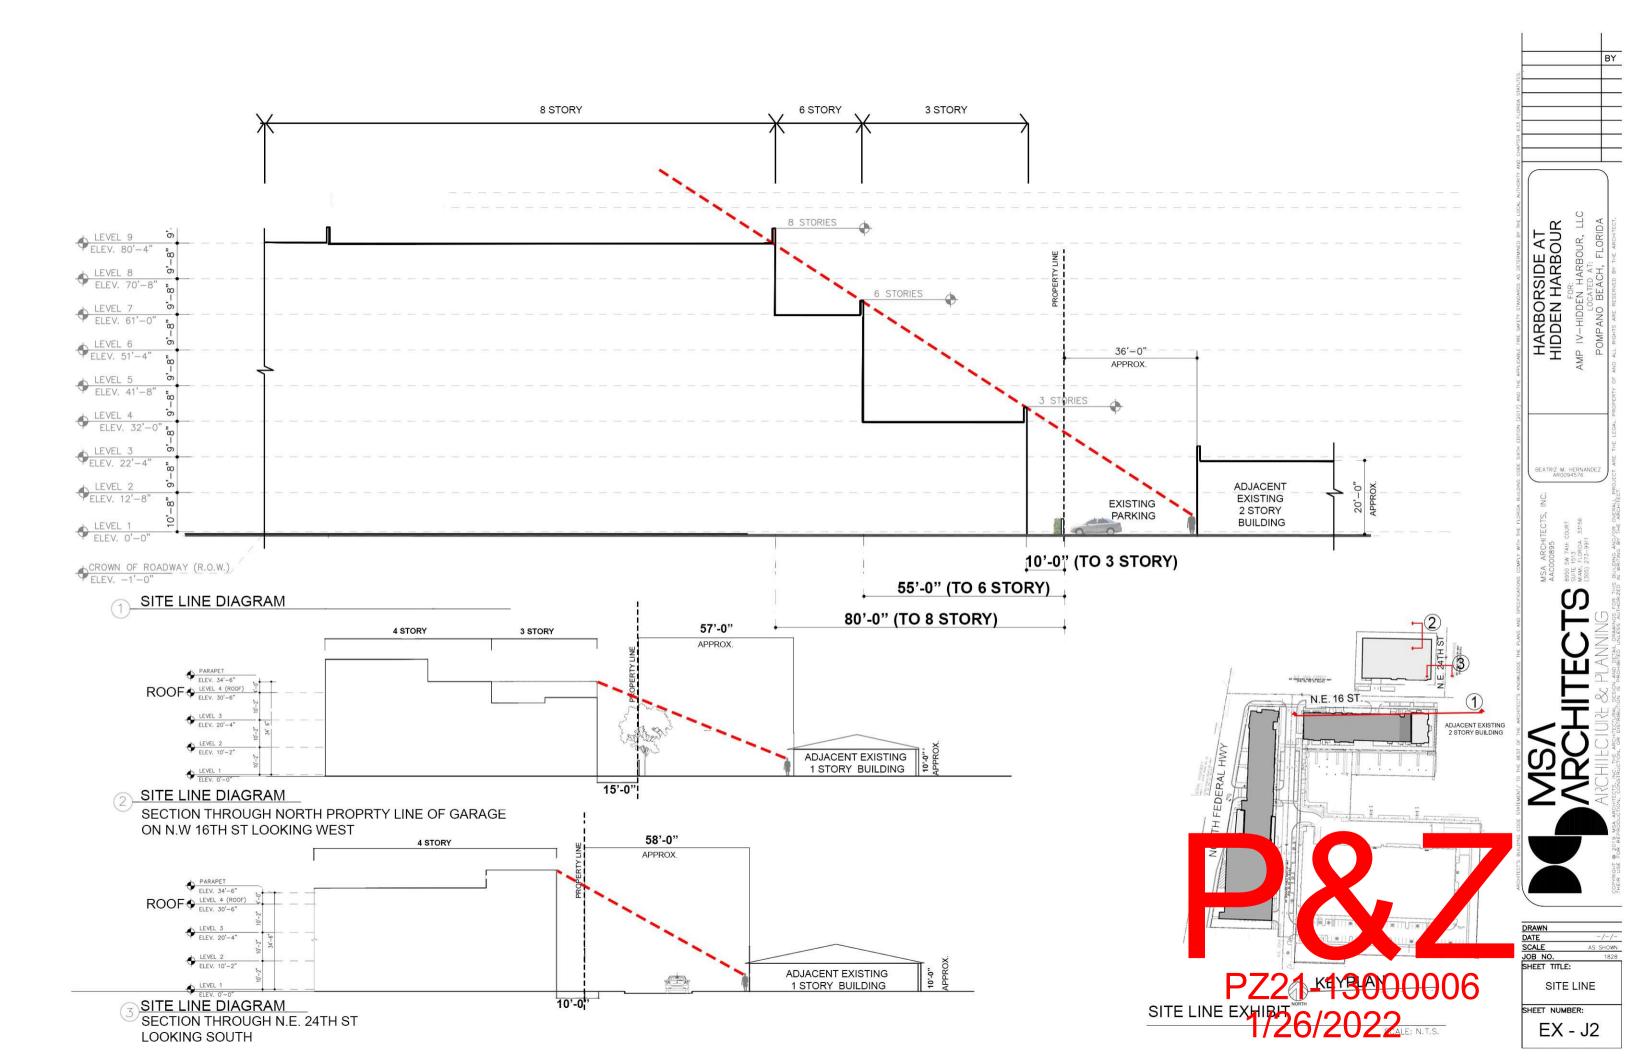



VIEW LOOKING WEST FROM 16TH ST



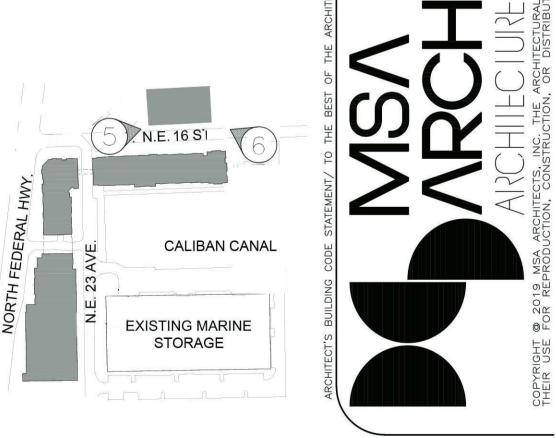



RENDERING

NO TO SCALE

PZ21-130 0000\$-3.7
1/26/2022

VIEW LOOKING NORTH EAST
FROM CORNER OF NE 16TH ST & NE 24TH TERR

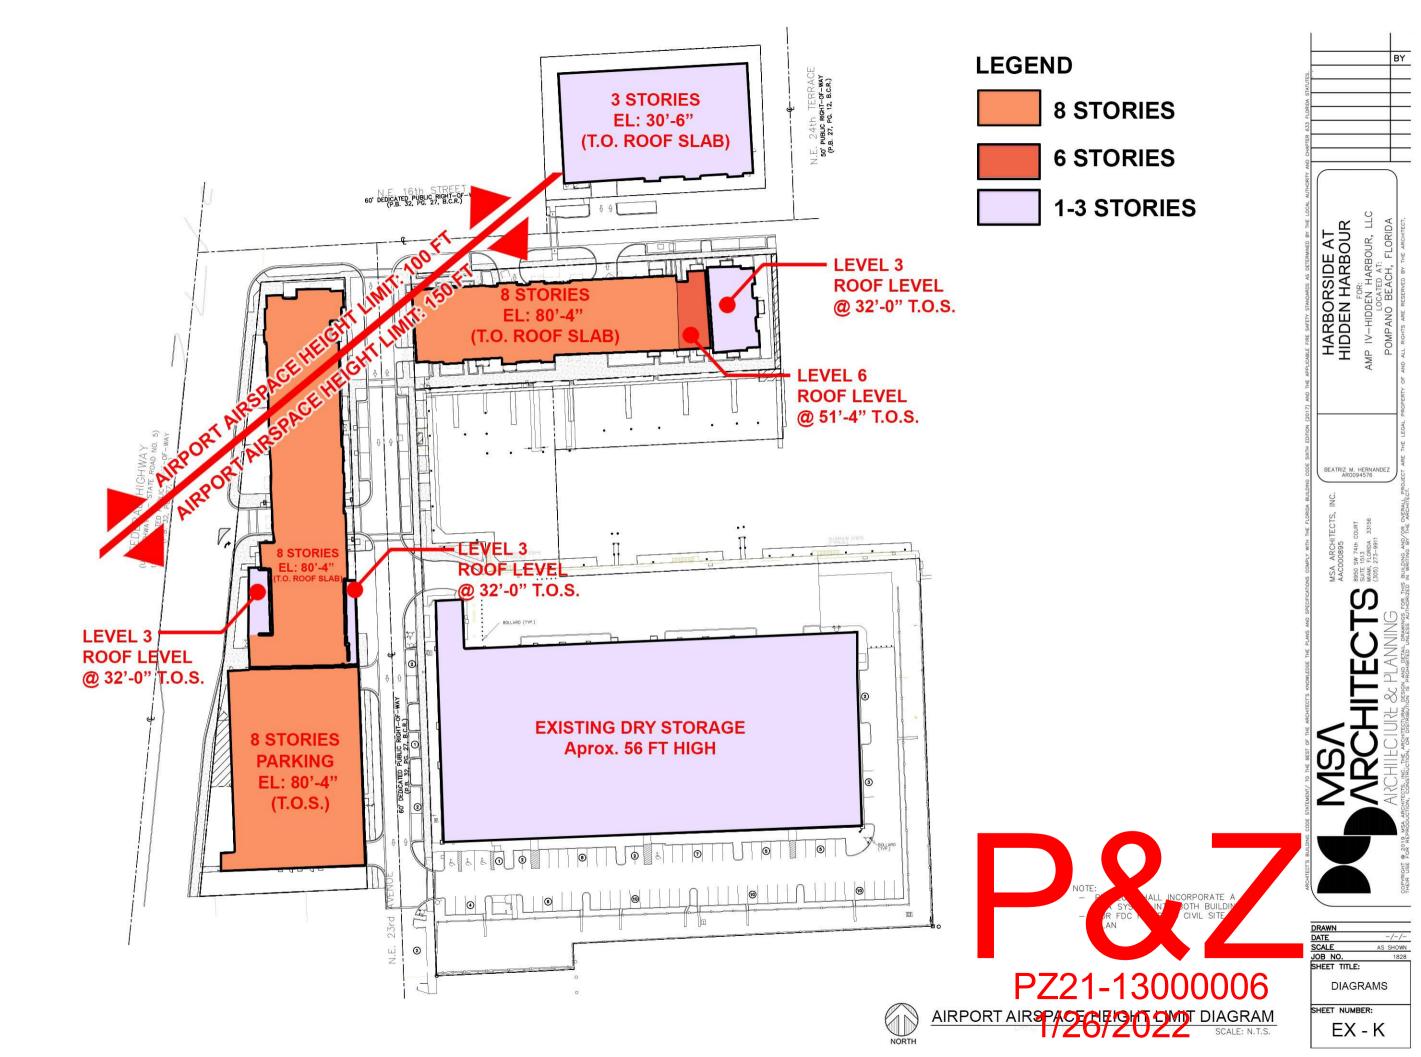

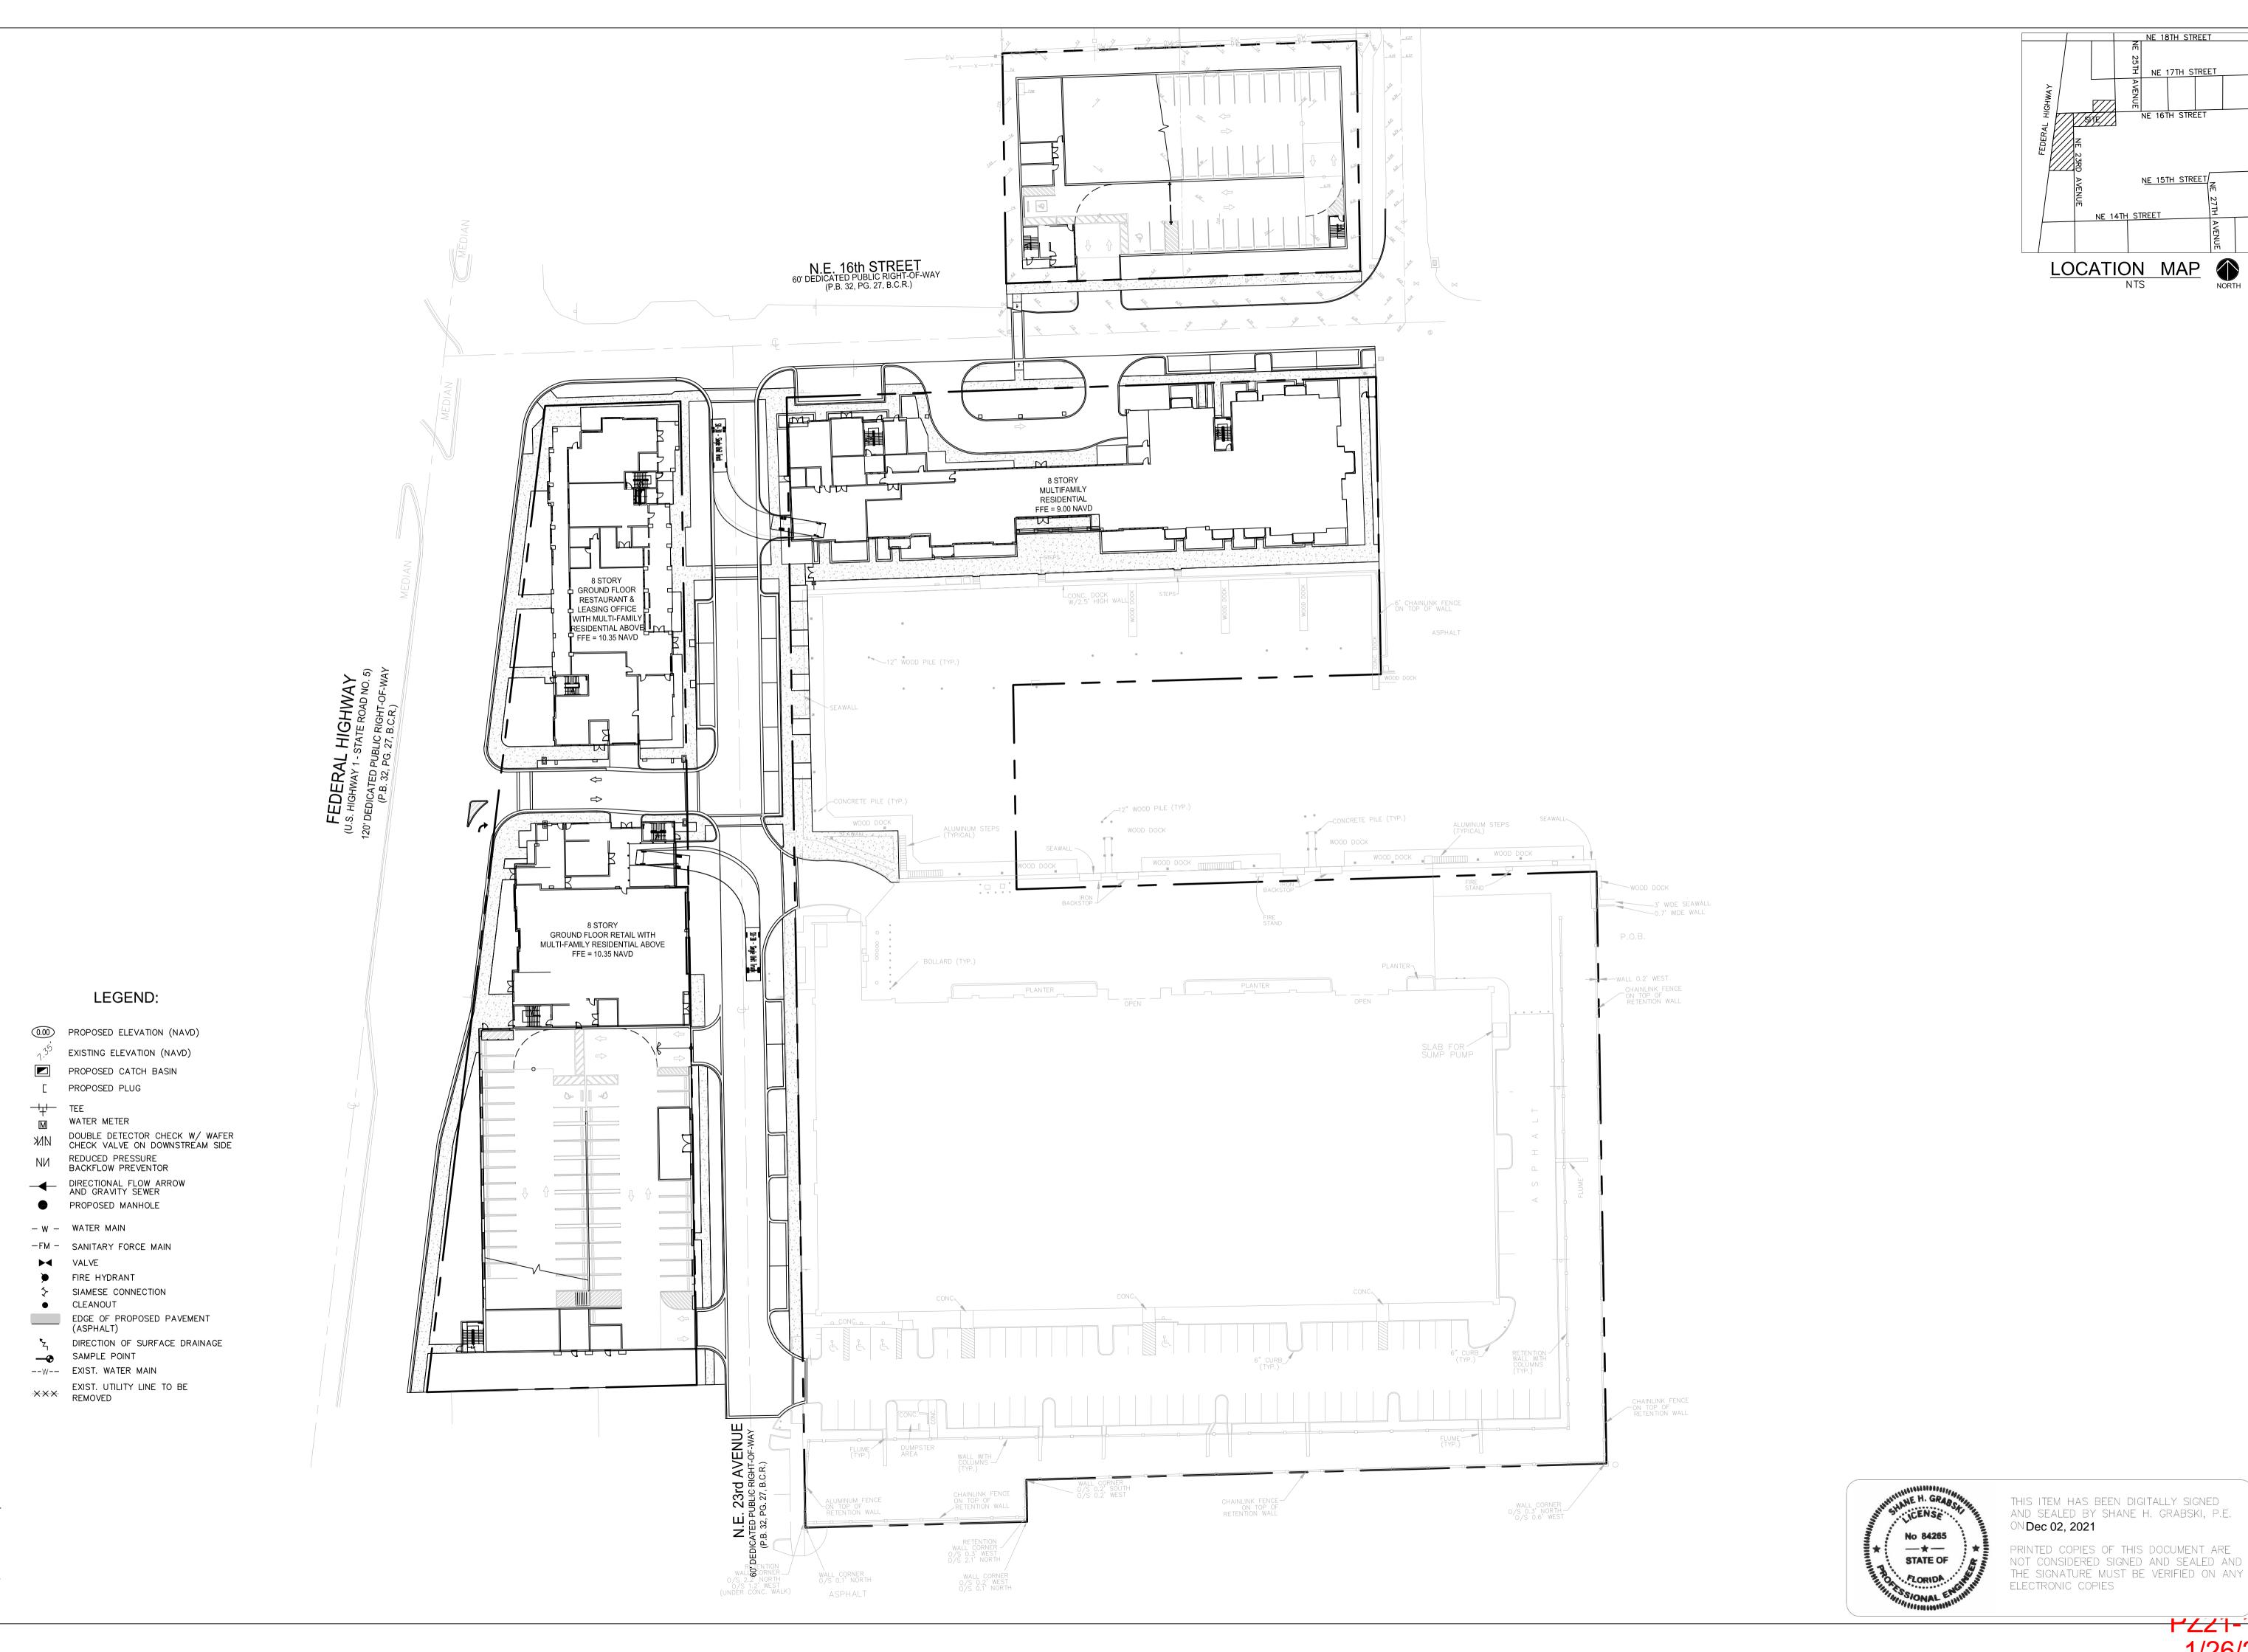

NORTH

R	Revisions			
\triangle				
\triangle				
⅓				
4				
\bigcirc				
<u></u>				
\mathbb{A}				
<u>&</u>				
		·		

Phase: DRC DOCUMENTS

Shane H

Grabski Digitally signed by Shane H Grabs DN: c=US, o=Flynn Engineering Services P.A., dnQualifier=A01410D0000017BA4 5154700004C4C, cn=Shane H

Date: 2021.12.02 18:58:05 -05'00'

1"=40' 09/28/21 05-0606.07

1/26/2022