CITY OF POMPANO BEACH **ESQUIRE LAKE NEIGHBORHOOD** STORMWATER IMPROVEMENTS

CITY BID No. E-03-18



LOCATION MAP



Florida's Warmest Welcome

BROWARD COUNTY NOTES

THE FOLLOWING ITEMS ARE NOT REVIEWED OR ACCEPTED BY BROWARD COUNTY:

- COUNTY TRAFFIC ENGINEERING DIVISION'S REVIEW DOES NOT INCLUDE A REVIEW AND ACCEPTANCE OF THE PROJECT'S DESIGN OR I. THESE ITEMS ARE TO BE REVIEWED AND APPROVED BY THE CITY ENGINEER.

FOR INFORMATION REGARDING THIS PROJECT, CONTACT: REBECCA TRAVIS. P.E.

MATHEWS CONSULTING, A BAXTER & WOODMAN COMPANY 477 S. ROSEMARY AVENUE, SUITE 330 WEST PALM BEACH, FL 33401 561/655-6175



477 S. Rosemary Avenue, Suite 330. West Palm Beach, Florida 33401
Phone: 561-655-6175 Fax: 561-655-6179
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DRAWING LIST

		
SHEET	DRAWING	TITLE
1 2 3 4	G-1 G-2 G-3 G-4	GENERAL TITLE SHEET, LOCATION MAP AND DRAWING LIST SURVEY LEGEND AND GENERAL NOTES HORIZONTAL CONTROL DETAILS KEY MAP
5 6 7 8 9 10 111 12 13 14 15 16 17 18 19 20 21 22 23 24 25 26 27 28 29 30 31 33 34 35 36 37 38 39 39 39 39 39 39 39 39 39 39 39 39 39	C-1 C-2 C-3 C-4 C-5 C-6 C-7 C-8 C-8A C-9 C-10 C-11 C-12 C-13 C-15 C-16 C-17 C-18 C-19 C-20 C-21 C-22 C-23 C-24 C-25 C-26 C-27 C-28 C-29 C-30 C-31 C-32 C-33 C-33 C-33 C-35	CIVIL NW 10TH STREET PLAN AND PROFILE — SHEET 1 NW 10TH STREET PLAN AND PROFILE — SHEET 2 NW 9TH COURT PLAN AND PROFILE — SHEET 3 NW 9TH COURT PLAN AND PROFILE — SHEET 5 NW 9TH STREET PLAN AND PROFILE — SHEET 5 NW 9TH STREET PLAN AND PROFILE — SHEET 6 NW 9TH STREET PLAN AND PROFILE — SHEET 7 NW 9TH STREET PLAN AND PROFILE — SHEET 7 NW 9TH STREET PLAN AND PROFILE — SHEET 8 OUTFALL #5 PLAN AND PROFILE — SHEET 8 NW 8TH STREET PLAN AND PROFILE — SHEET 10 NW 8TH STREET PLAN AND PROFILE — SHEET 11 NW 8TH STREET PLAN AND PROFILE — SHEET 11 NW 8TH STREET PLAN AND PROFILE — SHEET 11 NW 8TH STREET PLAN AND PROFILE — SHEET 11 NW 7TH STREET PLAN AND PROFILE — SHEET 14 NW 7TH STREET PLAN AND PROFILE — SHEET 15 NW 7TH STREET PLAN AND PROFILE — SHEET 16 NW 6TH COURT PLAN AND PROFILE — SHEET 17 NW 6TH COURT PLAN AND PROFILE — SHEET 18 NW 6TH COURT PLAN AND PROFILE — SHEET 19 NW 6TH COURT PLAN AND PROFILE — SHEET 19 NW 6TH STREET PLAN AND PROFILE — SHEET 19 NW 6TH STREET PLAN AND PROFILE — SHEET 12 NW 6TH STREET PLAN AND PROFILE — SHEET 12 NW 6TH STREET PLAN AND PROFILE — SHEET 12 NW 6TH STREET PLAN AND PROFILE — SHEET 12 NW 6TH STREET PLAN AND PROFILE — SHEET 12 NW 6TH STREET PLAN AND PROFILE — SHEET 12 NW 6TH STREET PLAN AND PROFILE — SHEET 12 NW 6TH STREET PLAN AND PROFILE — SHEET 12 NW 6TH STREET PLAN AND PROFILE — SHEET 12 NW 24TH AVENUE PLAN AND PROFILE — SHEET 25 NW 24TH AVENUE PLAN AND PROFILE — SHEET 26 NW 24TH AVENUE PLAN AND PROFILE — SHEET 27 NW 23RD TERRACE PLAN AND PROFILE — SHEET 30 NW 23RD TERRACE PLAN AND PROFILE — SHEET 30 NW 23RD TERRACE PLAN AND PROFILE — SHEET 33 NW 10TH COURT PLAN AND PROFILE — SHEET 33 NW 10TH COURT PLAN AND PROFILE — SHEET 33 NU 23RD TERRACE PLAN AND PROFILE — SHEET 33 NW 10TH COURT PLAN AND PROFILE — SHEET 34 NW 24TH AVENUE PLAN AND PROFILE — SHEET 33
40	C-36	NW 24TH AVENUE PLAN AND PROFILE - SHEET 36
41 42	C-37 C-38	NW 24TH AVENUE PLAN AND PROFILE — SHEET 37 NW 12TH COURT PLAN AND PROFILE — SHEET 38
43 44	C-39 C-40	NW 12TH COURT PLAN AND PROFILE — SHEET 39 NW 23RD AVENUE AND OUTFALL #7 PLAN AND PROFILE — SHEET 40
45	C-41	NW 23RD AVENUE PLAN AND PROFILE - SHEET 4!
46 47 48 49 50 51 52 53 54 55	D-1 D-2 D-3 D-4 D-5 D-6 D-7 D-8 D-9 D-10	DETAILS STANDARD DETAILS - SHEET 1 OF 10 STANDARD DETAILS - SHEET 2 OF 10 STANDARD DETAILS - SHEET 3 OF 10 STANDARD DETAILS - SHEET 4 OF 10 STANDARD DETAILS - SHEET 5 OF 10 STANDARD DETAILS - SHEET 5 OF 10 STANDARD DETAILS - SHEET 6 OF 10 STANDARD DETAILS - SHEET 7 OF 10 STANDARD DETAILS - SHEET 8 OF 10 STANDARD DETAILS - SHEET 8 OF 10 STANDARD DETAILS - SHEET 8 OF 10 STANDARD DETAILS - SHEET 9 OF 10 STANDARD DETAILS - SHEET 10 OF 10

TITLE SHEET AND LOCATION MAP

1 of 55 DRAWING: G-1

ALL CONSTRUCTION SHALL BE DONE IN A SAFE MANNER, SPECIFICALLY, THE RULES AND REGULATIONS
OF THE OCCUPATIONAL SAFETY MET HADMINISTRATION AND THE MANUAL OF UNIFORM TRAFFIC
CONTROL DEVICES SHALL BE STRICTLY OSSERVED.

3. ALL CONSTRUCTION SHALL CONFORM TO THE STANDARDS AND REQUIREMENTS OF THE AGENCIES HAVING JURISDICTION OVER THE R/W WHERE THE PROJECT IS CONSTRUCTED.

CONTRACTOR SHALL PREPARE AND SUBMIT MOT PLANS TO CITY OF POMPANO BEACH FOR REVIEW AND APPROVAL FOR WORK TO BE DONE WITHIN OR ADJACENT TO IMPROVED RIGHT-OF-WAY.

6. CONTRACTOR SHALL MAINTAIN ACCESS TO PRIVATE PROPERTY AT ALL TIMES.

7. LOCATIONS OF EXISTING FACILITIES AS SHOWN ON CONSTRUCTION DEAWINGS ARE APPROXIMATE AND ARE BRIWN FROM ANNUABLE RECORDS. THE ENGINEER ASSUMES NO RESPONSIBILITY FOR THE ACCURACY OF THE FACILITIES SHOWN HOP FOR ANY FACILITY NOT SHOWN. THE CONTRACTOR SHALL LOCATE OR EXPOSE ALL LITLIFIES WITHIN THE PROPOSES WORK AREAS AND AT CRITICAL LOCATIONS TO VERIFY UTILITY LOCATIONS, AND PIPE LAYING SCHEDULES PROOR TO SUBMITHING SHOP DRAWNINGS. THIS SHALL BE DONE WITHIN 30 DAYS AFTER NOTICE TO PROCEED. THE INFORMATION ORTHAND (CLEVATION, SEPARATION DISTANCE, PIPE MATERIAL AND SIZE, ETC.) SHALL BE MACE PART OF THE CONTRACTOR'S SUBMITTAL FOR ALL PIPHIG.

8. CONTRACTOR SHALL OBTAIN THE SERVICES OF SUNSHINE STATE ONE CALL OF FLORIDA (811), INC. AS REQUIRED BY FLORIDA STATUTES. CONTRACTOR SHALL BE RESPONSIBLE FOR DAMAGE TO ANY EXISTING UTILITIES.

9. REUSE MAINS ARE TO BE LAID WITHIN 0.2 FEET OF THE DESIGN PROFILE.

10. COVER SHALL BE A MINIMUM OF 3.0 FEET (TYPICAL) FOR WATERMAINS UNLESS OTHERWISE NOTED ON DRAWINGS.

11. ALL DELETERIOUS MATERIAL SHALL BE PROPERLY DISPOSED OF BY THE CONTRACTOR AT HIS EXPENSE.

12. IF UPON EXCAVATION, AN EXISTING UTILITY IS FOUND TO BE IN CONFLICT WITH THE PROPOSED CONSTRUCTION OR TO BE OF A SIZE OR MATERIAL DIFFERENT FROM THAT SHOWN ON THE DRAWINGS, THE CONTRACTOR SHALL IMMEDIATELY DOTTY THE ENGINEER.

13. PROPOSED TRUNCATED DOMED MATS SHALL BE IN ACCORDANCE WITH FDOT STANDARD INDEX 304 AND SHALL BE ON THE FDOT QUALIFIED PRODUCTS LIST (OPL). MATS SHALL BE SAFETY YELLOW.

15. NO TRENCHES OR HOLES NEAR WALKWAYS, IN ROADWAYS OR THEIR SHOULDERS ARE TO BE LEF OPEN DURING NIGHTIIME HOURS WITHOUT EXPRESS PERMISSION FROM CITY OF POMPANO BEACH.

CONTRACTOR SHALL REPLACE ALL PAVEMENT MARKINGS REMOVED DURING CONSTRUCTION, ALL PROPOSED AND REPLACED PAVEMENT MARKINGS SHALL BE THERMOPLASTIC.

18. EXISTING TRAFFIC SIGNS TO BE RESET PER FDOT STANDARDS.

CONTRACTOR SHALL ADJUST ALL UTILITY CASTING INCLUDING SANITARY SEWER MANHOLE TOPS, INLETS, VALVE BOXES AND SIMILAR STRUCTURES AS REQUIRED TO MEET FINAL GRADES.

STATIONS SHOWN ON THE DRAWINGS ARE STATIONS BASED ON THE ESTABLISHED BASELINE AND SHALL NOT BE CONSIDERED AS DISTANCES OR AS A MEASURE OF THE LINEAR FOOTAGE OF PIPE TO BE INSTALLED.

22. THE CONTRACTOR SHALL SCHEDULE INSPECTIONS AND TESTS WITH THE CITY A MINIMUM OF 48 HOURS IN ADVANCE.

24. SITE INFORMATION BASED ON A SURVEY PREPARED BY: COMPASS POINT SURVEYORS

25. CLEARING AND GRUBBING SHALL INCLUDE REMOVAL OF ALL VEGETATION WITHIN RIGHT-OF-WAY AS REQUIRED TO CONSTRUCT THE REQUIRED IMPROVEMENTS.

26. PROJECT SITE SAFETY:

A. THE ENGINEER/OWNER OR THEIR EMPLOYEES HAVE NO AUTHORITY TO EXERCISE ANY CONTROL OVER THE CONTRACTOR, ANY SUB-CONTRACTOR OR OTHER EMPLOYEES IN CONNECTION WITH THEIR WORK OR ANY JOBSITE HEALTH OR SAFETY PRECAUTIONS.

C. ALL EXISTING OVERHEAD AND UNDERGROUND UTILITIES SHOWN ON THESE DRAWINGS OR ENCOUNTERED THROUGH THE PROGRESSION OF WORK AT THIS PROJECT SITE.

THE CONTRACTOR SHALL COORDINATE AND EMPLOY THE SERVICES OF FPL TO SUPPORT ANY EXISTING POWER POLES WITHIN THE IMMEDIATE VICINITY OF TRENCHES.

28. CONTRATOR SHALL LIMIT THE CONSTRUCTION IMPACTS TO DRIVEWAYS AS SHOWN ON THE PLANS.
THE COST OF THE SHEETING, SHORING, ETC. OF THE TRENCH SHALL BE INCLUDED IN THE COSTS OF DEEP
URILITY CONSTRUCTION AS RESESSARY TO LIMIT TRENCH WITHIN. THE LIMIT OF PRIVEWAY REPLACEMENT SHALL BE SANCUT

GENERAL INFORMATION

SETEMPAL INFOURMALION

1. ATRET TELEPRONE, FLORIDA POWER AND LIGHT, CABLE TV, GAS, ETC. ARE
TAKEN FROM FILLD INSPECTIONS AND SKETCHES PROVIDED BY UTILITIES AND
ARE SHOWN FOR THE CONTEMPLEC OF THE CONTRACTOR ONLY. THE CONTRACTOR
SHALL CONTACT ALL UTILITY OWNERS AND CONFRIN LOZIONIST OF UTILITIES NO
USES THAN A HOURS BEFORE BEGINNING CONFRUCTION. THE CONTRACTOR
SHALL ACCURRICTLY LOCATE AND UNDERSY ALL DISSING UTILITIES BEFORE
SHALL ACCURRICTLY LOCATE AND UNDERSY ALL DISSING UTILITIES BEFORE
UTILITIES COURS. AND VOAMOE RESULTING FROM THE CONTRACTORS OPERATION
SHALL BE REPAIRED AT THE CONTRACTORS EXPENSE.

2. ALL MATERIALS SHALL CONFORM TO CITY OF POMPANO BEACH STANDARD SPECIFICATIONS.

1. ALL STORM SEWER INLET GRATES TO BE COVERED WITH FILTER FABRIC DURING CONSTRUCTION.

CUT AND FILL SLOPES TO BE CONSTRUCTED IN A MANNER THAT WILL MINIMIZE EROSION. SILT FENCES TO BE USED WHERE NECESSARY.

THE QUALITY OF THE DISCHARGE WATER FROM DEWATERING AND CONSTRUCTIONS ACTIVITIES SHALL MEET STATE WATER QUALITY STANDARDS.

BROWARD COUNTY TRAFFIC ENGINEERING RFI #2

SURVEYOR'S REPORT

TYPE OF SURVEY:

TOPOGRAPHIC SURVEY ESQUIRE LAKE NEIGHBORHOOD DRAINAGE PROJECT, POMPANO BEACH, BROWARD COUNTY, FLORIDA

SURVEY PREPARED BY:

COMPASS POINT SURVEYORS, PL., 2101 N.W. 33RD STREET SUITE #100, POMPANO BEACH, FLORIDA 33069, OFFICE: 954-332-8181

1. ALL MEASUREMENTS, DISTANCES, ELEVATIONS AND FEATURES WERE PERFORMED IN STRICT ACCORDANCE WITH THE MINIMUM TECHNICAL STANDARDS SET FORTH IN CHAPTER 5J-17.050, 5J-17.051 AND 5J-17.052 FLORIDA ADMINISTRATIVE CODE.

2. METHODS FOR ALL CONTROL MEASUREMENTS WERE MADE WITH A TRANSIT AND STEEL TAPE, OR DEVICES WITH EQUIVALENT OR HIGHER DEGREES OF ACCURACY.

3. THE ACCURACY STANDARD USED FOR THIS SURVEY, AS CLASSIFIED IN THE MINIMUM TECHNICAL STANDARDS 5.1-17.050, 5.1-17.051 AND 5.1-17.052 F.A.C., IS COMMERCIAL, HIGH RISK.". THE MINIMUM RELATIVE DISTANCE ACCURACY FOR THIS TYPE OF SURVEY IS 1 FOOT IN 10,000 FEET. THIS SURVEY IS BASED ON REPETITIVE RITK GPS AND AGROUTE OTALS TATION OBSERVATIONS ON MULTIPLE PROJECT FOREZONTAL VERTICAL CONTROL POINTS TO GRANIA REDUNDANCY OF MEASUREMENT. HORIZONTAL AND VERTICAL COLOURS ACHIEVED, EXCEED THE MINIMUM ACCURACY REQUIREMENTS FOR THIS SURVEY.

1. THOSE CERTAIN PLATS WERE UTILIZED IN THE PREPARATION OF THIS SURVEY:

COLLIER CITY, P.B. 31, PG. 01

ESQUIRE LAKE ESTATES SECTION 3, P.B. 67, PG. 27
ESQUIRE LAKE ESTATES SECTION 4, P.B. 71, PG. 42
COLLIER CITY ADDITION, P.B. 73, PG. 47
CO-DAN ESTATES, P.B. 76, PG. 04

PINNACLE VILLAGE, P.B. 173, PG. 162

MULTIRESOLUTION SEAMLESS IMAGES (MISID), DOWNLOADED FROM LAND BOUNDARY INFORMATION SYSTEM (LABINS) WWW.LABINS.ORG, WERE UTILIZED IN THE PREPARATION OF THIS SURVEY.

3. ELEVATIONS SHOWN HEREON ARE IN FEET AND REFERENCED TO NORTH AMERICAN VERTICAL DATUM OF 1988 (NAVD 88). FARENT BENCH MARK: NGS PID D02644, DESIGNATION 005, ELEVATION = 10.31 FEET.

HORIZONTAL/VERTICAL CONTROL POINTS USED FOR THIS SURVEY: CONTROL POINT 16, SET MAIL AND TINTAB, 'NO ID', NW 8TH STREET STATION 51-00, FFSET DOD FEET RIGHT, NORTHING 69349.55 FEET, EASTING 69369.79 FEET, ELEVATION = 11.29 FEET AND CONTROL POINT 10, SET MAIL & TINTAB "NO ID', W 9TH STREET STATION 120-478.72, OFFSET D.DD RIGHT, NORTHING 69347.04 FEET, EASTING 693291.49 FEET, ELEVATION = 10.91 FEET, AND THE LINE ETMEEN SAID CONTROL POINT NUMBERS 10 & 10 SEING THE BASIS OF BEARING 1883 93 92 AS 3 HOWN ON THE MAY OF SURVEY.

6. BY GRAPHIC PLOTTING ONLY, THE SUBJECT PROPERTY LIES WITH ZONE AH, ELEVATION 11, AS SHOWN ON THE FLOOD INSURANCE RATE MAP COMMUNITY PANEL NUMBER 120055 0120 F, PANEL 120 OF 319, MAP EFFECTIVE DATE: AUGUST 18, 1992.

PURPOSE OF SURVEY: LOCATE SELECTED NATURAL AND ARTIFICIAL FEATURES OF A PART OF THE EARTHS SURFACE TO DETERMINE HORIZONTAL AND VERTICAL SPATIAL RELATIONS TO BE UTILIZED FOR THE PURPOSE OF DESIGN.

2. LAST FIELD DATE OF SURVEY: 07/18/14, AS REFERENCED IN FIELD BOOK 325, PAGES 1-23 AND FIELD BOOK 326 PAGES 1-59.

PRINTED DIMENSIONS SHOWN ON THE SURVEY SUPERSEDE SCALED DIMENSIONS. THERE MAY BE ITEMS DRAWN OUT OF SCALE TO GRAPHICALLY SHOW THEIR LOCATION.

5. USE OF THIS SURVEY BY ANYONE OTHER THAN THOSE PREPARED FOR OR CERTIFIED TO, WILL BE THE RE-USERS SOLE RISK WITHOUT LIABILITY TO THE

SHOWN ANYWHERE ON THIS SURVEY, THE WORD "CERTIFY" IS UNDERSTOOD TO BE AN EXPRESSION OF A PROFESSIONAL OPINION BASED UPON THE SURVEYOR'S BEST KNOWLEDGE, INFORMATION AND BELIEF, AND THAT IT CONSTITUTES NEITHER A GUARANTEE NOR A WARRANTY.

NOT APPLICABLE.

WEST PALM BEACH, FL 33401

PROFESSIONAL SURVEYOR AND MAPPER LICENSE NUMBER LS 4535

SURVEY PREPARED BY:



2101 N.W. 33RD STREET, SUITE 100, POMPANO BEACH, FL 33069 - PH. 954.332.8181 | LB No.: 7535

SURVEY LEGEND:

F.D.O.T. = FLORIDA DEPARTMENT

ASPH. = ASPHALT

HDPE = HIGH DENSITY POLYETHYLENE PIPE
INV = INVERT
I.R.C. = IRON ROD & CAP BPP = BLACK PLASTIC PIPE BST = BELLSOUTH TELEPHONE C/L = CENTERLINE = CENTERLINE
= CALCULATED
= CALCULATED FROM
FIELD TRAVERSE
= CHAIN LINK FENCE
= CONCRETE LIGHT POLE = LENGTH L.F. = UNEAR FEET
LSA = LANDSCAPE AREA
LW.D.D. LAKE WORTH DRAINAGE DISTRICT MP = METAL PIPE N/A = NOT ACCESSIBLE N/D = NAIL AND DISK CMP = CORRUGATED METAL PIPE CONC. = CONCRETE CP = CONCRETE PIPE OHW = OVERHEAD WIRE = CENTRAL ANGLE = DUCTILE IRON PI O.R.B. = OFFICIAL RECORD BOOK
P.B. = PLAT BOOK
PBC = PALM BEACH COUNTY DEP. = DEPRESSED (CURB) P.B.C.R. = PALM BEACH COUNTY RECORDS = ELEVATION = EDGE OF PAVEMENT

PP = PLASTIC PIPE PRM = PERMANENT REFERENCE MARKER
PVC = POLYVINYL CHLORIDE OF TRANSPORTATION
F.P.L. = FLORIDA POWER AND LIGHT

R/C = ROD AND CAP

SEC. = SECTION STA. = STATION

T.O.N. = TOP OF NUT

T.O.P. = TOP OF PIPE T.O.W. = TOP OF WALL

U.E. = UTILITY EASEMENT UNK = UNKNOWN VERT. = VERTICAL

V.G. = VALLEY GUTTER VCP = VITRIFIED CLAY PIPE

WPP = WOOD POWER POLE

CMU = CONCRETE MASONARY UNIT

RWM = RIGHT OF WAY MAP

RCP = REINFORCED CONCRETE PIPE RW = RIGHT OF WAY

R = RADIUS
ERCP = ELLIPTICAL REINFORCED CONCRETE PIPE F F = FINISH FLOOR ELEVATION

SURVEY SYMBOL LEGEND:

AIR RELEASE VALVE FPL MANHOLE ELECTRIC OUTLET RED FLAG UNKNOWN TYPE MANHOLE BFP-D-BACK FLOW PREVENTER DECORATIVE MAILBOX W WATER METER WHITE FLAG SANITARY MANHOLE IV M IRRIGATION VALVE
SV M SANITARY VALVE LIMITS OF LANDSCAPING
LSA LIMITS OF TREE CANOPY
BUSH/HEDGE wv 🖂 WATER VALVE ß SPIGOT = ORANGE FLAG SIGN CO . CLEAN OUT = GREEN FLAG -OHW- OVERHEAD UTILITY WIRE - GUY WIRE ANCHOR -BPM- BLUE PAINT MARKS X 0.00 EXISTING ELEVATION -- RPM-- RED PAINT MARKS - FIRE HYDRANT SITE BENCHMARK - GPM- GREEN PAINT MARKS OPM—ORANGE PAINT MARKS
—PPM—PURPLE PAINT MARKS
—WPM—WHITE PAINT MARKS MONITORING WELL CPP

CONCRETE POWER POLE SET NAIL AND DISC LB #6599 SPRINKLER HEAD GROUND LIGHT LIGHT POST Ó-- ☼ WOOD POLE STREET LIGHT M MAILBOX FIBER OPTIC MARKER WOOD GUIDE POLE EM ELECTRIC METER
ELECTRIC HANDHOLD CONCRETE SIGNAL LIGHT POLE DECORATIVE LIGHT POST CONCRETE LIGHT POST UNKNOWN HANDHOLD MONITORING WELL CABLE/TV HANDHOLD PANEL ELECTRICAL PANEL ELECTRIC BOX TRAFFIC SIGNAL BOX TRAFFIC HANDHOLD ICV IRRIGATION CONTROL VALVE IN CONC. BOX FIBER OPTIC HANDHOLE G.T. GAS TEST BOX U.GAS UNDERGROUND GAS MARKER PARKING METER RISER : UNKNOWN RISER BOX YD YARD DRAIN RCWV RECLAIMED WATER VALVE CUP CONCRETE UTILITY POLE YD SQUARE YARD DRAIN CTV CABLE PEDESTAL ELECTRIC TRANSFORMER W WATER METER C COMMUNICATION PEDESTAL CURB INLET

SURVEY TRE	E LEGEND:		
DO" O -ACACIA	00" ∰ - UNKNOWN	00" 🔘 -CITRUS	OOWTHY PAPAYA
OO" -PALM SPECIES	00° 23 - BOTTLEBRUSH	00° & -CACTUS	00 O -CYPRESS
00" 🍪 - BANANA	00" AAPLE	- MANGO	00" -GUMBO-LIME
00" 🚳 - FICUS	00" ()-MAHOGANY	COCCO - HEDGE	
00" ♣ - SEAGRAPE	00° ()-OAK	⊕ -BUSH	
	NOTE: VERIFICATION OF TREE SPECIES S PROFESSIONAL ENGAGED IN THE FIELD OF		A

BROWARD COUNTY NOTES

THE FOLLOWING ITEMS ARE NOT REVIEWED OR ACCEPTED BY BROWARD COUNTY:

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DANGIA

CORIDA

T. M.

BROWARD COUNTY TRAFFIC ENGINEERING DIVISION'S REVIEW DOES NOT INCLUDE A REVIEW AND ACCEPTANCE OF THE PROJECT'S DESIGN OR OPERATION. THESE ITEMS ARE TO BE REVIEWED AND APPROVED BY THE CITY ENGINEER.

DEBONAND COUNTY TREFFIC ENGINEERING DOINGN DOES NOT REVIEW AND APPROVE OR INSPECT AND ACCEPT THE FOLLOWING ITEMS FOR MINITEMACE: PAREMENT MARKINGS ON OR ADJACENT TO PAVE BRICKS, PAINTED ASPHALT, STAMED ASPHALT, OR PAVEMENT MARKINGS AND GENERAL PROPERTY MARKINGS AND SECRET BROKES, ROUSED INTERSECTIONS AND RELATED MARKINGS AND SIGNING, UN-MARKINGS PAINTED/DECORATIVE CROSSWALKS AND RELATED MARKINGS AND SIGNING, UN-MARKINGS FOR SPECIAL PROPERTY OF A SIGNING, UN-MARKINGS FOR SPECIAL PROPERTY OF A SIGNING, UN-MARKINGS FOR SPECIAL PROPERTY OF A SIGNING, UN-MARKINGS FOR SPECIAL PROPERTY SIGNING AND SIGNING, UN-MARKINGS FOR SPECIAL PROPERTY SIGNING AND SIGNING, UN-MARKING PAINTED MARKINGS AND SIGNING, UN-MARKING PAINTED PAINTED MARKINGS AND SIGNING, UN-MARKING PAINTED MARKINGS AND SIGNING, UN-MARKING PAINTED PAINTED MARKINGS AND SIGNING, UN-MARKING PAINTED PAINTED MARKINGS AND SIGNING, UN-MARKING PAINTED PAI

3. THE CITY ENGINEER IS RESPONSIBLE FOR THE REVIEW AND APPROVAL OF THE DESIGN AND OPERATION OF THE PROJECT, AND FOR THE INSPECTION AND ACCEPTANCE OF THE FOLLOWING ITELS THAT WILL BE MAINTAINED BY THE CITY PAREMENT MARKINGS ON OR PAVER BRICKS, PAINTED ASPHALT, STAMPED ASPHALT OR PAVEMENT MARKINGS MODE OF PAVER BRICKS, PAVEMENT MARKINGS ON OR ACADICANT TO PAINTED ASPHALT, INSEED INTERSECTIONS AND RELATED MARKINGS AND SIGNING, UN-INARRANTED MID-BLOCK CROSSWALKS PAYER BROCKS, PAINTED ASPHALT, STAMED ASPHALT ON PAYERLENT IMMORRAS MADE OF PAYER BROCKS, PAYER BROCKS, PAYER AND ASPHALT ASPHALT DAY ASPHALT OF PAYER BROCKS, PAYER BROCKS, PAYER AND ASPHALT ASPHALT BROWNING AND SCHING, OH-HOROWINED CROSSINALISS AND SCHING, OH-HOROWINED CROSSINALISS AND SCHING, OH-HOROWINED CROSSINALISS, AND SCHING, OH-STEPET PAYERING MADE BROCKS, AND SCHING, OH-STEPET PAYERING MADE BROCKS, AND SCHING, OH-STEPET PAYERING MADE SCHING, OH-STEPET PAYERING MAD SCHING, OH-STEPET PAYERING MADE SCHING, OH-STEPET PAYERING MADE

BAR IS ONE INCH ON FULL SIZE (22×34) ORIGINAL DRAWING. ADJUST SCALES AS NECESSARY.

ENGINEER NO.: 1800 CLIENT

PROJECT NO .: CAD REF.: <u>1800G02</u>

CITY OF POMPANO BEACH ESQUIRE LAKE NEIGHBORHOOD STORMWATER IMPROVEMENTS

DESIGNED: M.R.T. J.A.J./K.C. CHECKED: D.L.M./A.C REBECCA, TRAVIS, P. APPROVED: D.L.M.

APRV'D BY

DRAWN:

a BAXTE COOPMAN company


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www.baxterwoodman.com EB-31795

SURVEY LEGEND AND GENERAL NOTES

JUNE 2018 2 of 55 DRAWING: G-2

NO. DATE

4/17/18

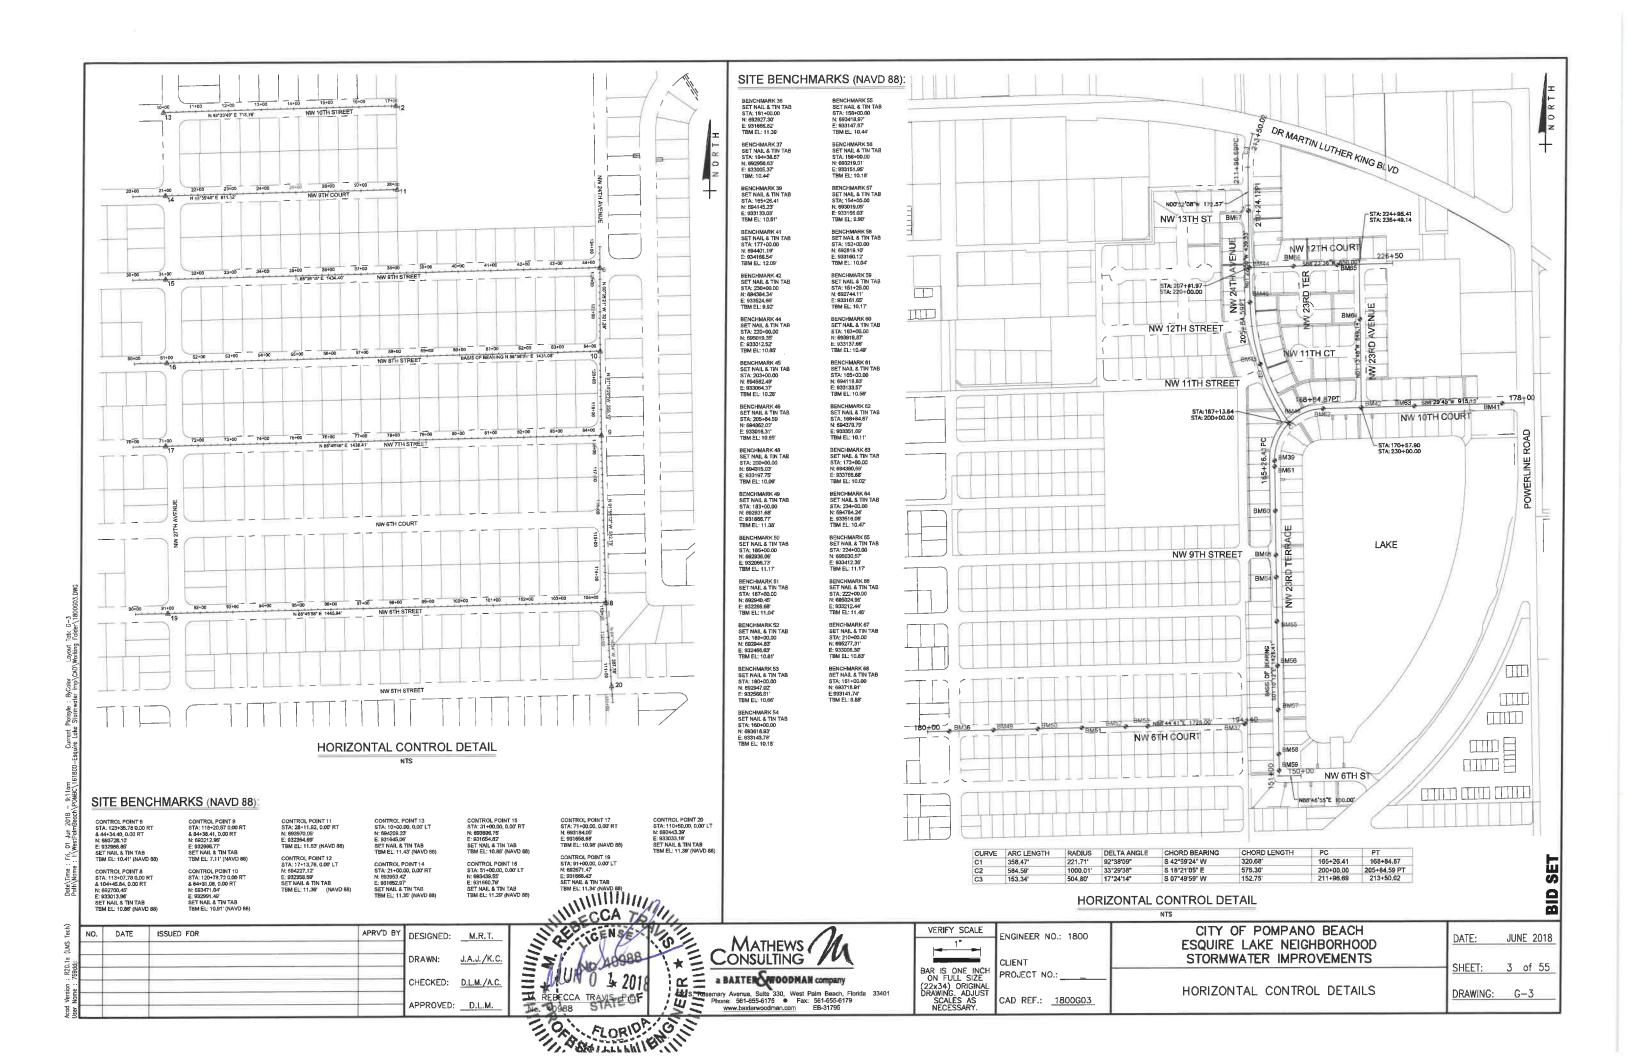

OR WARTIN	
DR MARTIN LUTHER KING BLVD	
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C-38 W 2M of C-39	
NW 127H 55	
NW 11TH CT	
NW 117H ST C-32 W JONE 01 C-333	
OUTFALL #7	
3W 4H 5 3 1 1 1 1 1 1 1 1 1 1 1 1 1 1 1 1 1 1	
IN 9TH ST. C-8A OUTFALL #5	
EC9 MW 6PH ST C-10 C-11 MW 8PH ST C-12	
C-13 W 7H ST C-16 8 1 1 1 1 1 1 1 1 1	
CONTRAL 64	
Wind C 18 C 19 We SH CT C 20	
C-21 W 674 5 C-22 W 674 5 C-23 W 674 5 C-24	
E CONTRACTOR OF THE PROPERTY O	

City	of	Por	mpa	no	Be	ach
PER LINE				~		

ESQUIRE LAKE NEIGHBORHOOD TREE DISPOSITION

Dwg	Location	Tree #	Botanical Name	Common Name	Diam	Size	Condition	Est. Value	Disposition
C-7	STA 38+52, 16' RT	1	Phoenix Robellini	Pygmy Date Palm	1"	3' ht. x 4' spr.	97%	\$50	Remove & replace with new tree on 2456 NW 9th St.
C-18	STA 187+80, 16' RT	2	Adonidia Merrillii	Christmas Palm	8"	4' ht. x 2' spr.	94%	\$270	Remove & replace with new tree on 2502 NW 6th Ct.
C-18	STA 187+82, 16' LT	3	Adonidia Merrillii	Christmas Palm	4"	11' O.A.	94%	\$230	Remove & replace with new tree on 2501 NW 6th Ct.
C-19	STA 189+74, 14' RT	4	Budica Buceras	Black Olive	10"	15' ht. x 10' spr.	53%	\$1,000	Remove & replace with new tree on 2444 NW 6th Ct.
C-19	STA 192+19, 15' RT	5	Busera Simaruba	Gumbo Limbo	8"	22' ht. x 8' spr.	30%	\$1,300	Remove & replace with new tree on 2420 NW 6th Ct.
C-19	STA 192+31, 16' RT	6	Busera Simaruba	Gumbo Limbo	12"	20' ht. x 14' spr.	75%	\$2,700	Remove & replace with new tree on 2420 NW 6th Ct.
C-20	Between 641/651 NW 23rd Terrace	7	Mangifera Indica	Mango Tree	3"	10' ht. x 4' spr.	94%	\$110	Remove & replace within yard of 641 NW 23rd Terr, mir 5' from easement line.
C-26	STA 114+43, 9' RT	8	Cupaniopsis Anacardioides	Carrottwood	(6) 4"	20' ht. x 20' spr.	50%	\$190	Remove & replace within yard of 621 NW 23rd Terr, min 5' back of ROW line.
C-26	STA 114+50, 9' RT	9	Cupaniopsis Anacardioides	Carrottwood	(4) 3"	20' ht. x 20' spr.	50%	\$50	Remove & replace within yard of 621 NW 23rd Terr, min 5' back of ROW line.
C-26	STA 114+53, 10' RT	10	Quercus Virginiana	Live Oak	24"	28' ht. x 24' spr.	91%	30,100	Root Prune, provide tree protection, tree to REMAIN.
C-25	STA 115+73, 10' RT	11	Yucca Aloifolia	Spanish Bayonet	(3) 4"	15' ht. x 10' spr.	72%	\$380	Remove & replace within yard of 641 NW 23rd Terr, mir 5' back of ROW line.
C-32	STA 169+88, 19' LT	12	Adonidia Merrillii	Christmas Palm	4"	14' O.A.	91%	\$300	Remove & replace with new tree on 2301 NW 10th Ct.
C-32	STA 170+20, 20° LT	13	Adonidia Merrillii	Christmas Palm	4"	16' O. A.	95%	\$340	Remove & replace with new tree on 2301 NW 10th Ct.
C-34	STA 302+67, 2' LT	14	Schefflera Actinophyla	Scheflera	12"	25' ht. x 14' spr.	81%	\$220	Remove & replace with new tree on 1030 NW 23rd Terr.
C-34	STA 302+69, 6' LT	15	Schefflera Actinophyla	Scheflera	12"	24' ht. x 15' spr.	81%	\$190	Remove & replace with new tree on 1030 NW 23rd Terr.
C-40	STA 230+35, 22' RT	16	Adonidia Merrillii	Christmas Palm	4"	14' O.A.	91%	\$300	Remove & replace with new tree on 2301 NW 10th Ct.
C-41	STA 235+62, 15' LT	17	Cocos Nucifera	Coconut Palm	12"	20' O.A.	90%	\$770	Remove & replace with new tree on 2300 NW 12th Ct.
C-41	STA 236+02, 17' LT	18	Syagrus Romanzoffiana	Queen Palm	10"	12' O.A.	81%	\$230	Remove & replace with new tree on 2300 NW 12th Ct.

1. Condition & Estimated Values are based on the Council of Tree & Landscape Appraisers Guide for Plant Appraisal, 9th Edition. Palms were appraised with the Replacement Cost Method & Trees with the Trunk

Method. Survey conducted on March 16, 2018.

2. As per City Ordinance Sections 50.02(A)(4) and Section 100.35(B), street trees shall not be placed on top of, or Seither side of any city owned utility infrastructure. No trees, shrubbery or obstruction shall be paked within a 3-foot radius of a city owned sewer lateral, cleanout or water and/or reuse meter.

All tree work will require permitting by a Registered Broward County Tree Trimmer.
 Refer to Drawing D-10 for details.
 Landscape material to be paid from Landscape Material Allowance. Installation and intigation (bubbler) to be paid from Landscape.

 Λ

		FE	NCING TO	BE REM	OVED &	REPLACED
Dwg.	Location	Street Address	Туре	Height	Length	Disposition
C-20	Between NW 24th Ave & NW 23rd Terr	651 NW 23rd Terrace	Conc block	6'	96'	Remove & replace with 96 LF - 6' tall concrete block wall
C-20	STA 153+52, 64' LT	651 NW 24th Avenue	Metal	4'	28'	Remove & replace with 28 LF - 4' tall aluminum rail fence
C-20	153+62, 132' RT	650 NW 23rd Terrace	Chain Link	4'	173'	Remove & replace with 4' tall aluminum rail fence from ROW line to 15' back, then transition to 4' tall chainlink fence and install to connect to edge of privacy wall at lake.
C-25	113+93, 10' RT	611 NW 24th Ave	Wood	6'	63'	Remove & replace with 63 LF - 6' tall wood shadowbox fence.
C-25	114+39, 8' RT	621 NW 24th Ave	Chain Link	6'	44'	Remove & replace with 44 LF - 6' tall wood shadowbox fence.
C-26	115+16, 9' RT	631 NW 24th Ave	Chain Link	5'	42'	Remove & replace with 42 LF - 6' tall wood shadowbox fence.
C-26	115+16, 9' RT	631 NW 24th Ave	Wood	6'	45'	Remove & replace with 45 LF - 6' tall wood shadowbox fence.
C-34	167+52, 127° RT	2360 NW 10th Court	Chain Link	4	114'	Remove & replace with 4' tall aluminum rail fence from ROW line to 15' back, then transition to 4' tall chainlink fence and install to connect to existing fence at rear of property.

Notes:
(1) All wood and chainlink fencing to be removed & replaced shall follow Florida Building Code, 2017 Edition. All other fence types and privacy wall will require submission of signed and sealed shop drawings for removal & replacement.
(2) Refer to Drawing D-10 for details.

1 - allow)						ASHIP 48 SOUTH PANGS - BECCA KEY MAP NTS
Γ	NO.	DATE	ISSUED FOR	APRV'D BY	DESIGNED: M.R.T.	No. 40988 0
	Λ	2/28/18	CITY BUILDING DEPARTMENT RFI #1	M.R.T.		
	2	3/13/18	CITY BUILDING DEPARTMENT RFI #2	M.R.T.	DRAWN: <u>J.A.J./K.C.</u>	
	4	4/05/18	CITY BUILDING DEPARTMENT RFI #3	M.R.T.		三地NO STATE OF
	6	5/08/18	CITY BUILDING DEPARTMENT RFI #4	M.R.T.	CHECKED: D.L.M./A.C.	1 23 11 14 10 16:
					APPROVED: D.I.M.	M. REBECCA TRAVEORED

MATHEWS /
CONSULTING BAXTE WOODMAH company

Resemany Avenue, Suite 330, West Palm Beach, Florida 33401

Phone: 561-655-6175 Fax: 561-655-6179

www.baxtervoodman.com EB-31795

MINIMAL SININ

VERIFY SCALE
1"
BAR IS ONE INCH ON FULL SIZE
(22x34) ORIGINAL DRAWING, ADJUST
SCALES AS NECESSARY.

	ENGINEER NO.: 1800	
н	CLIENT PROJECT NO.:	


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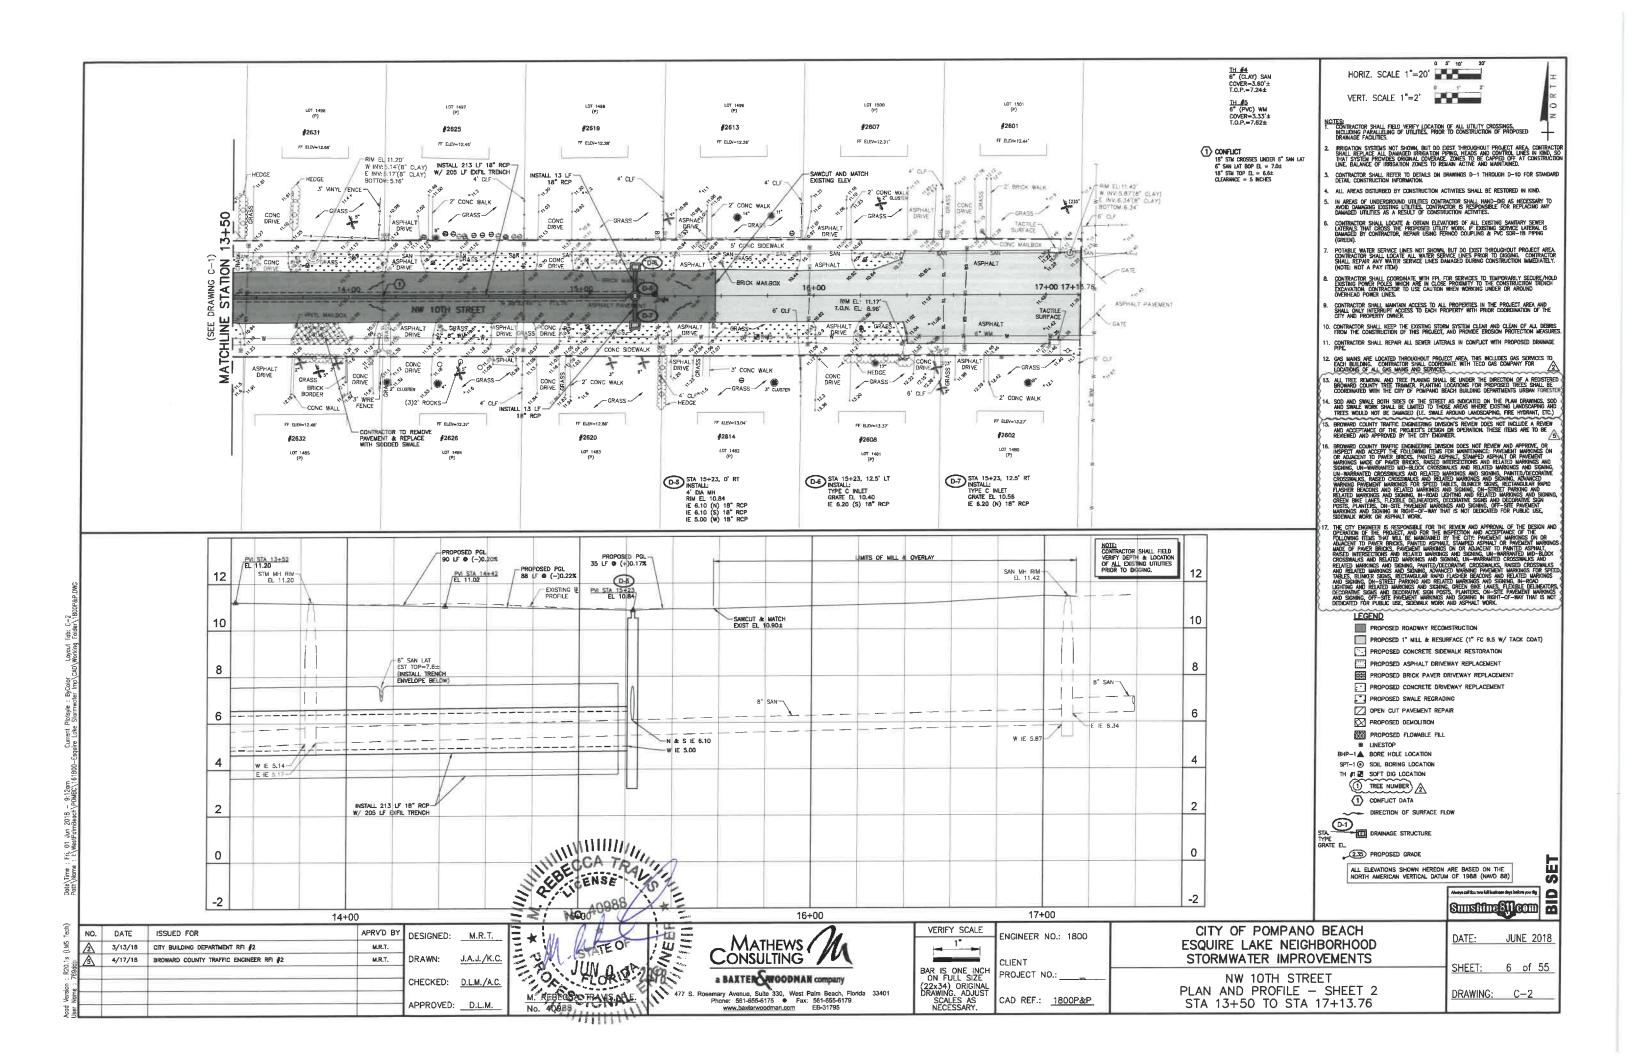
CITY OF POMPANO BEACH
ESQUIRE LAKE NEIGHBORHOOD
STORMWATER IMPROVEMENTS


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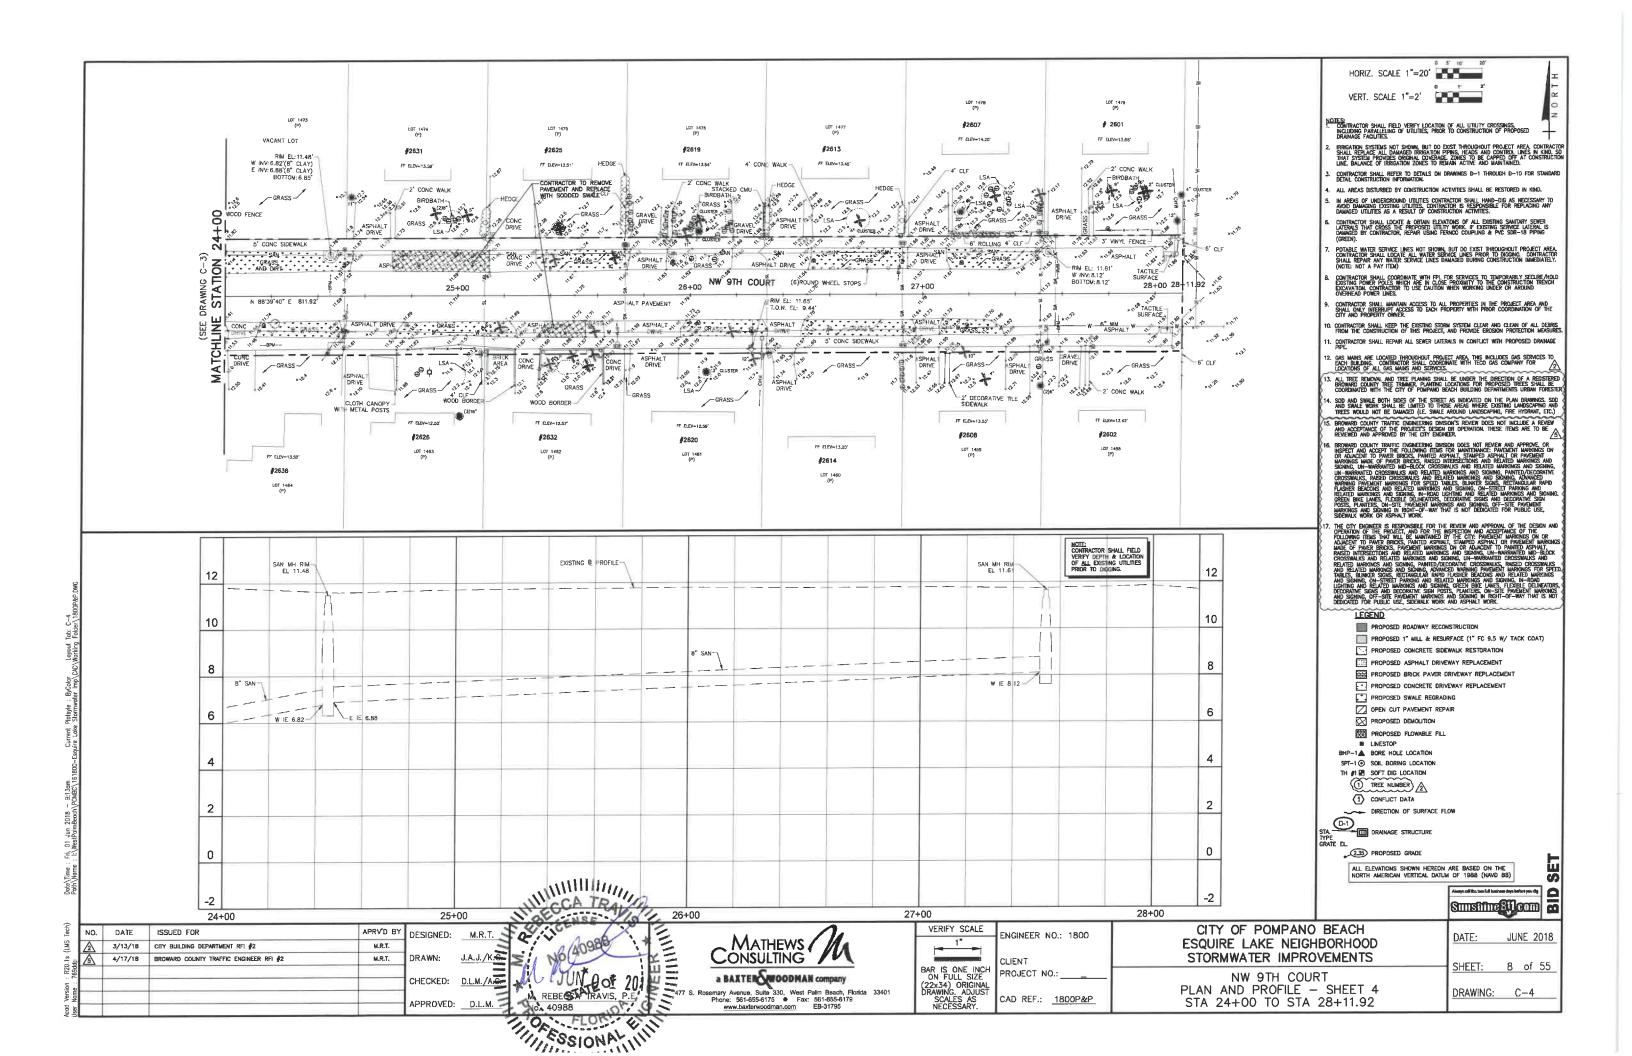
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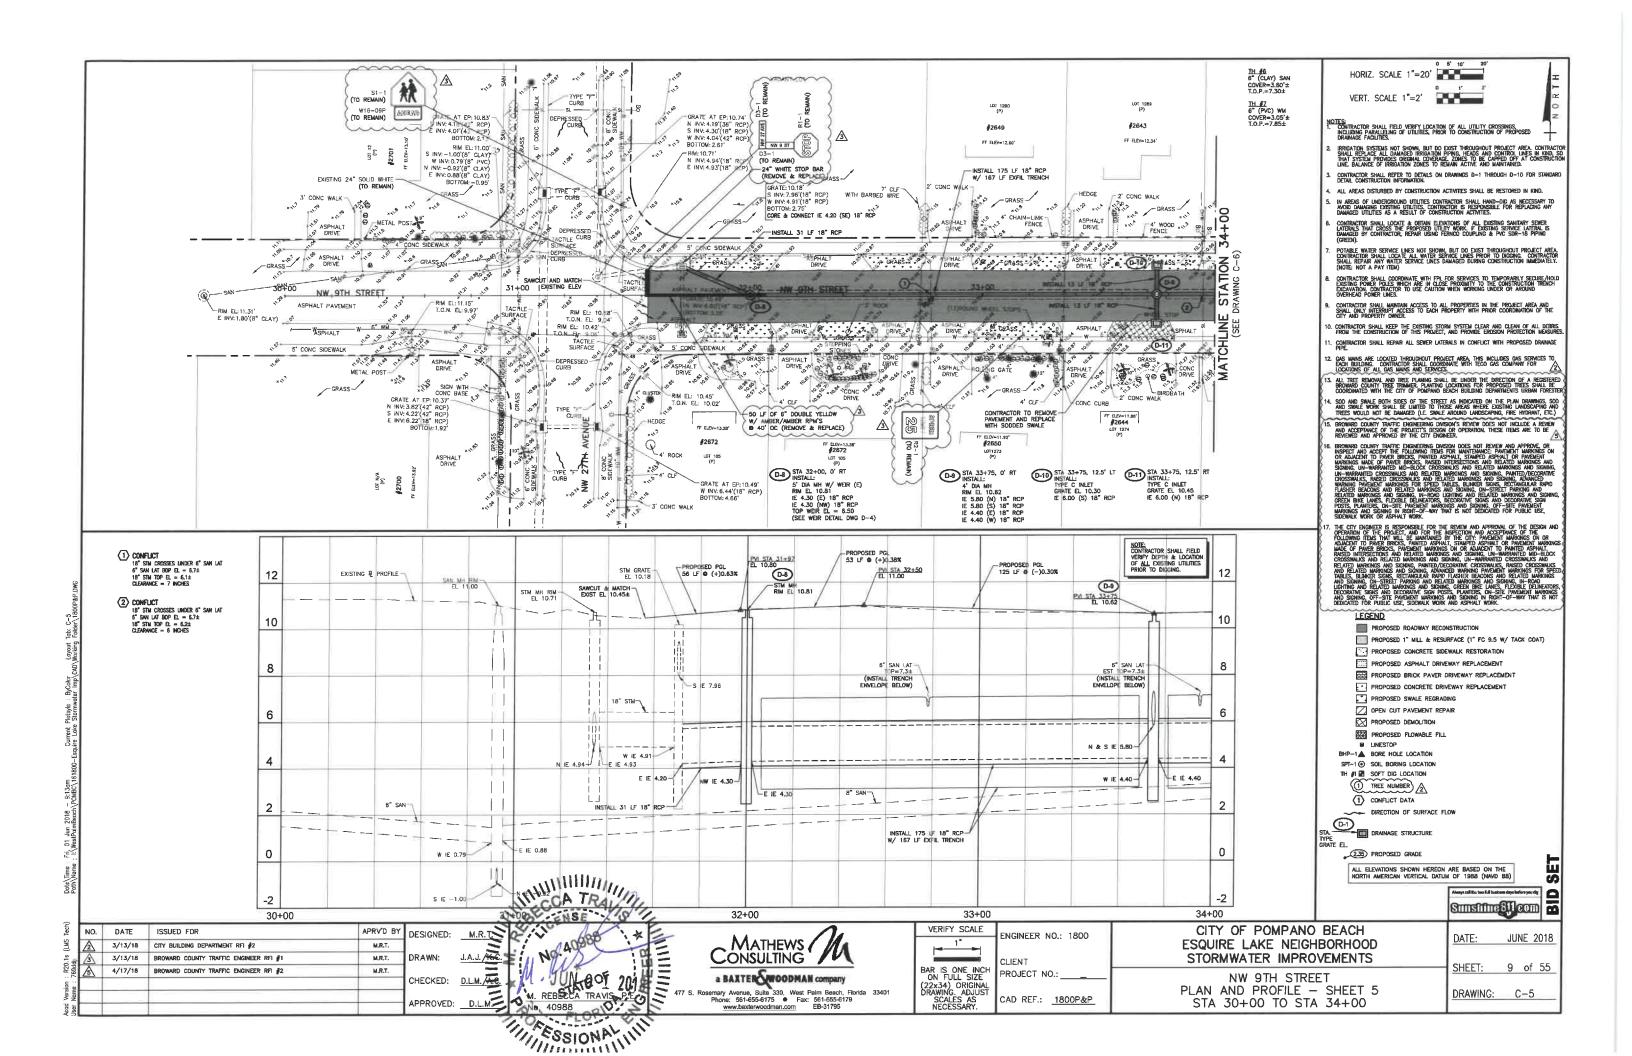
KEY MAP










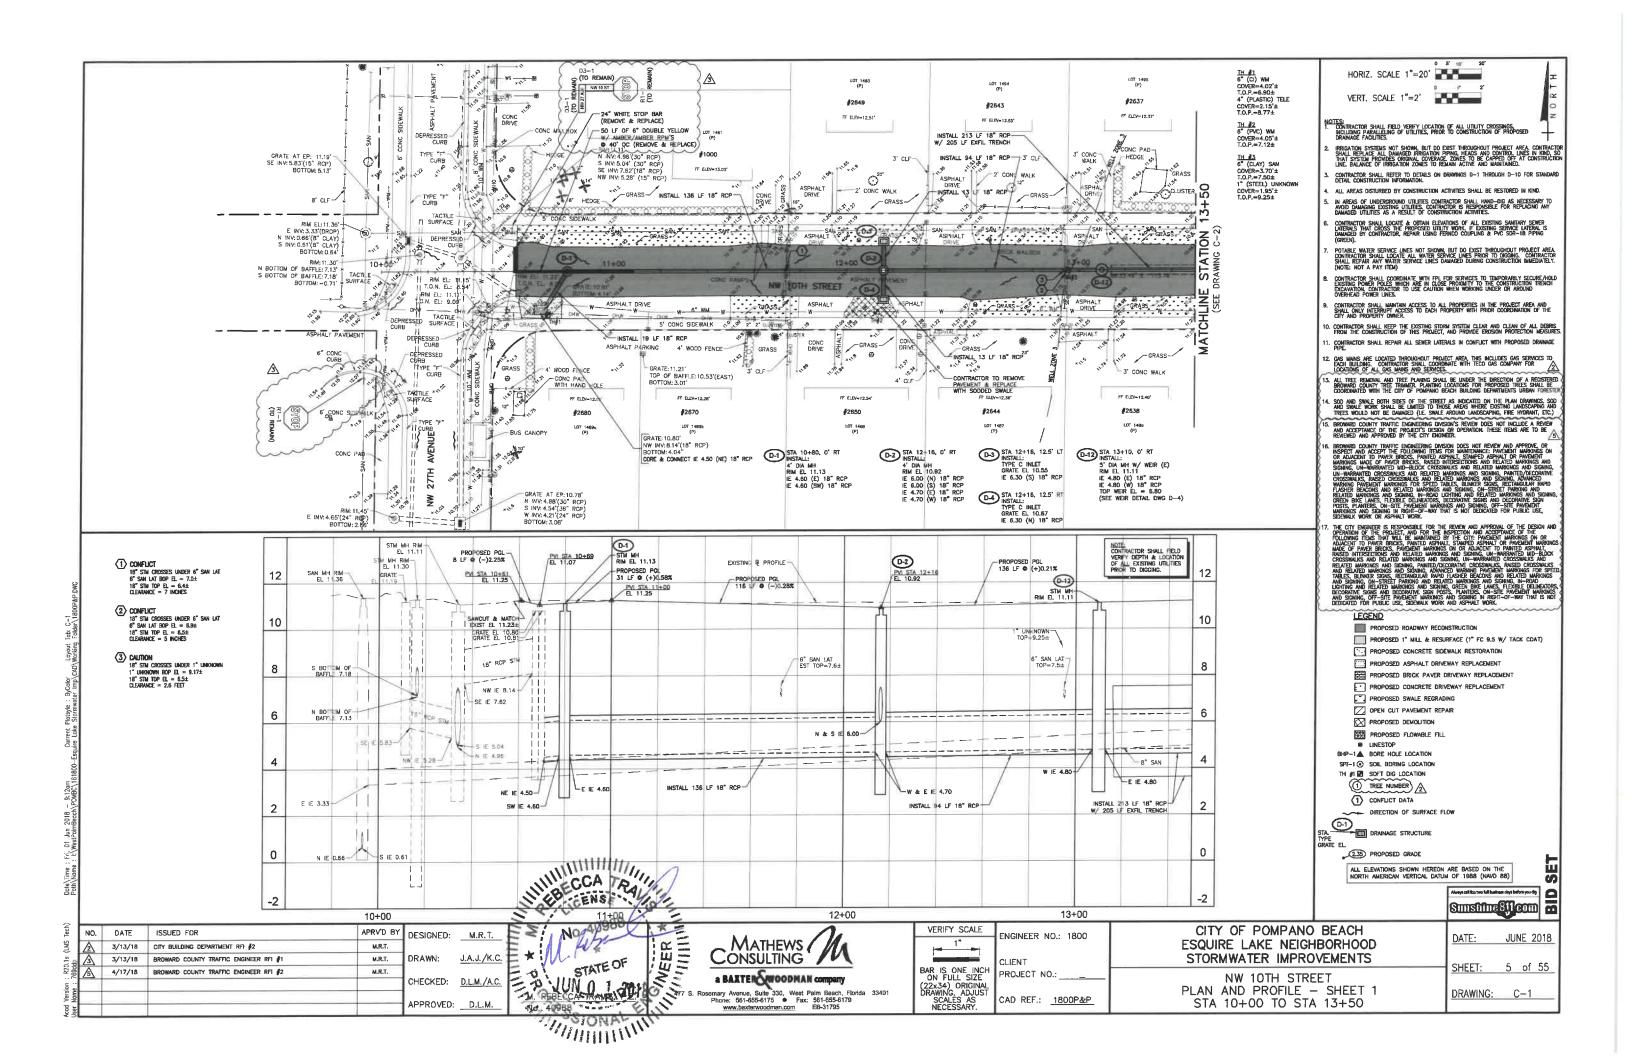


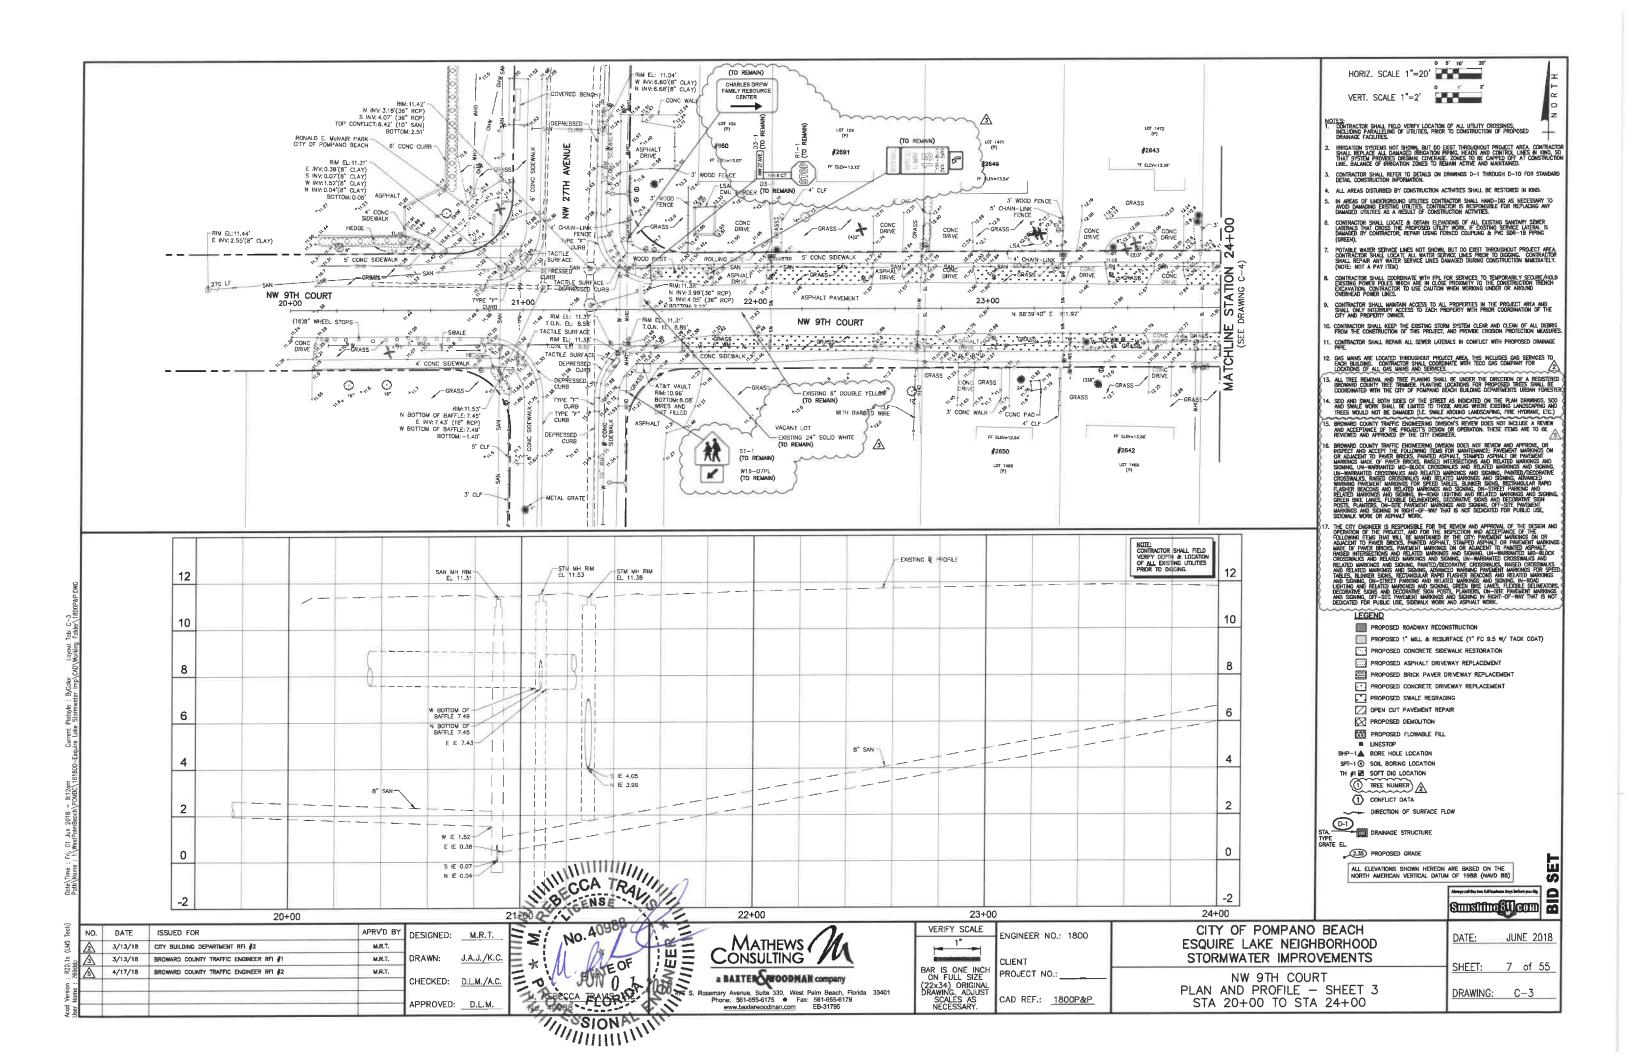


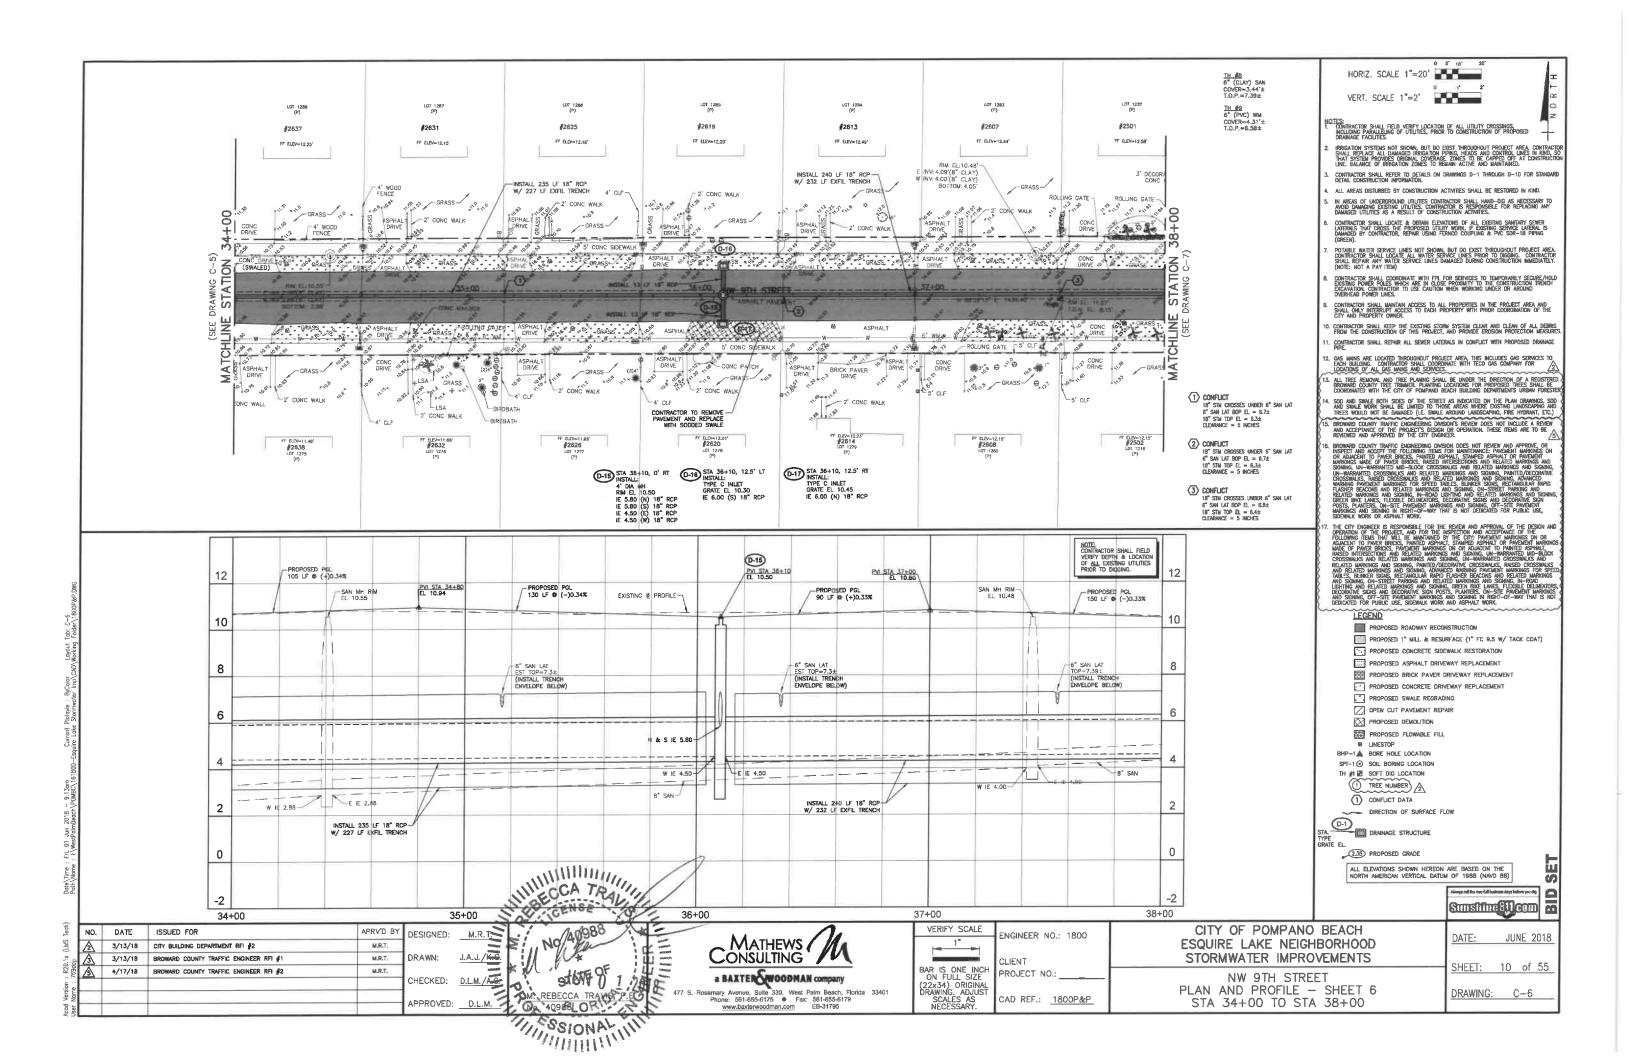


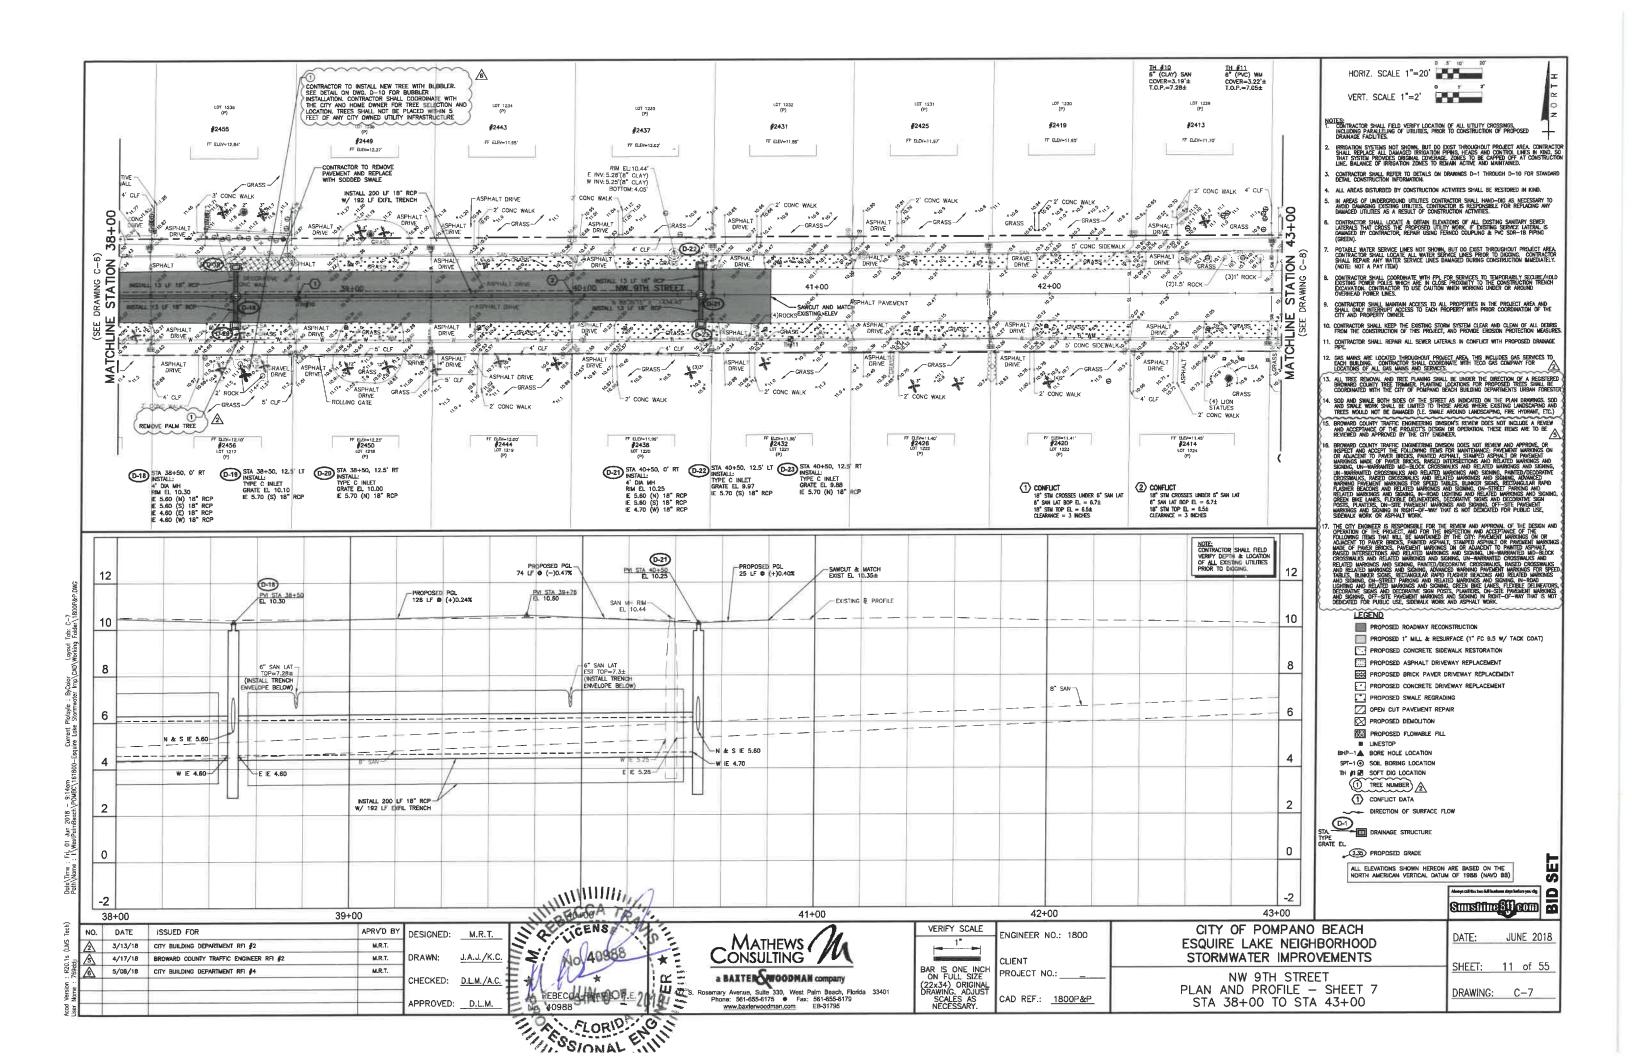


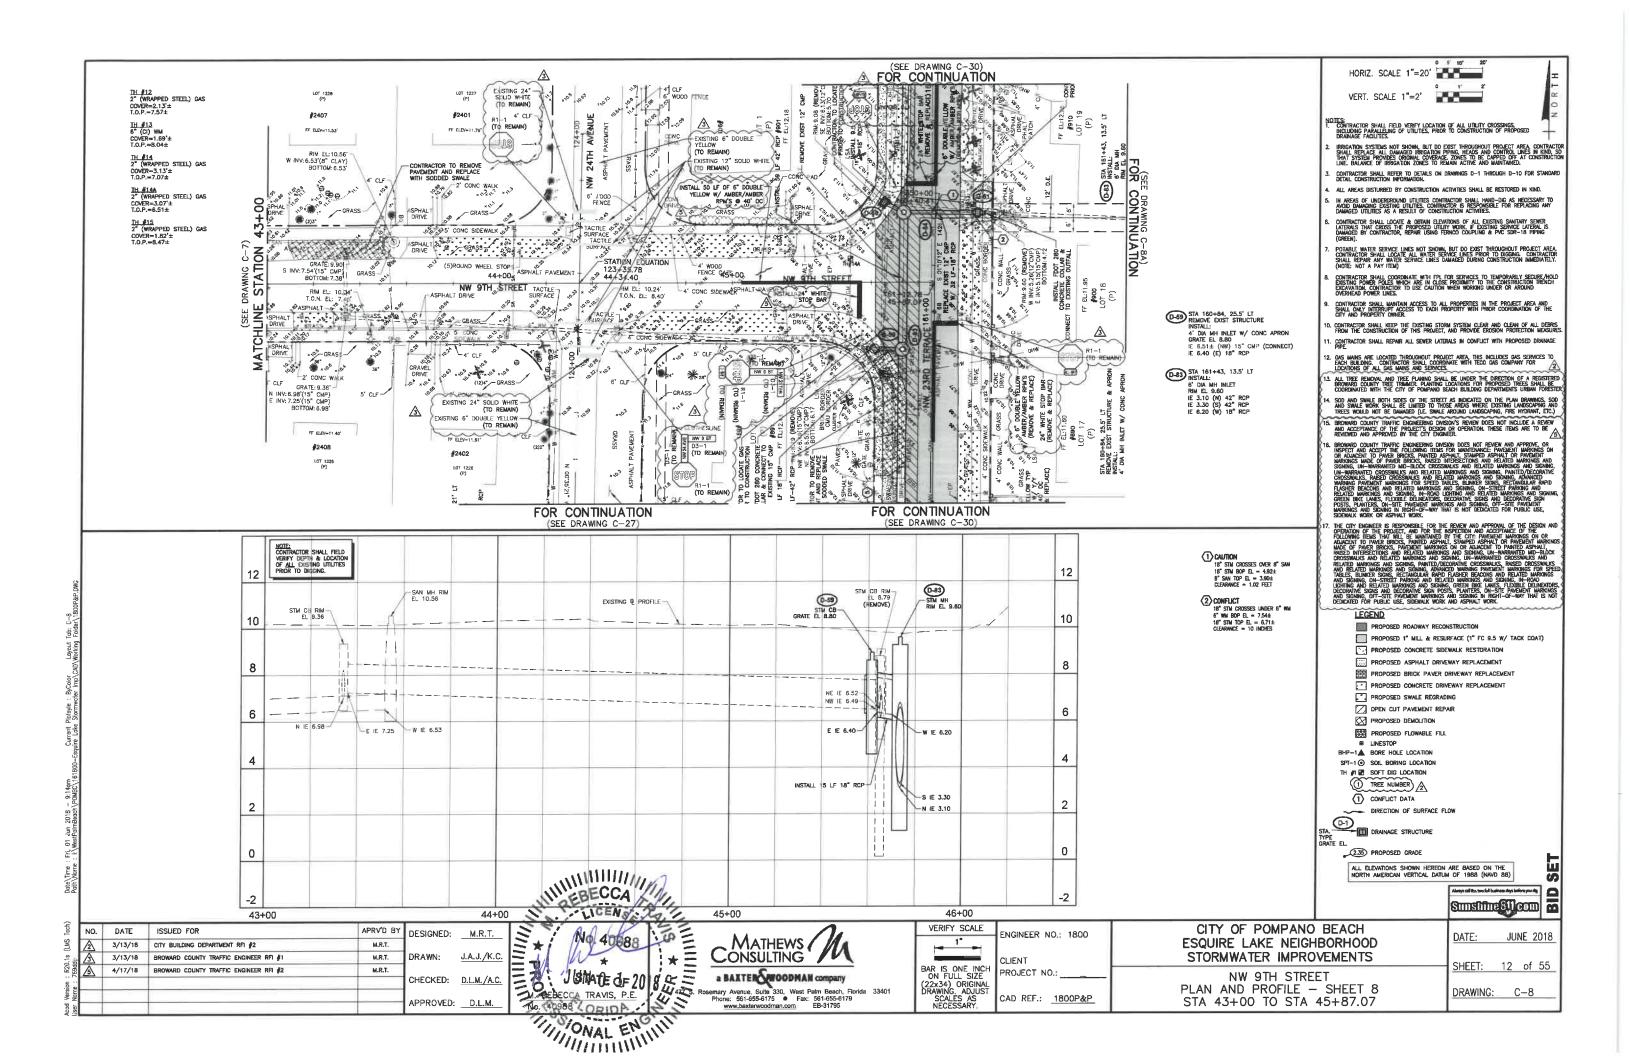


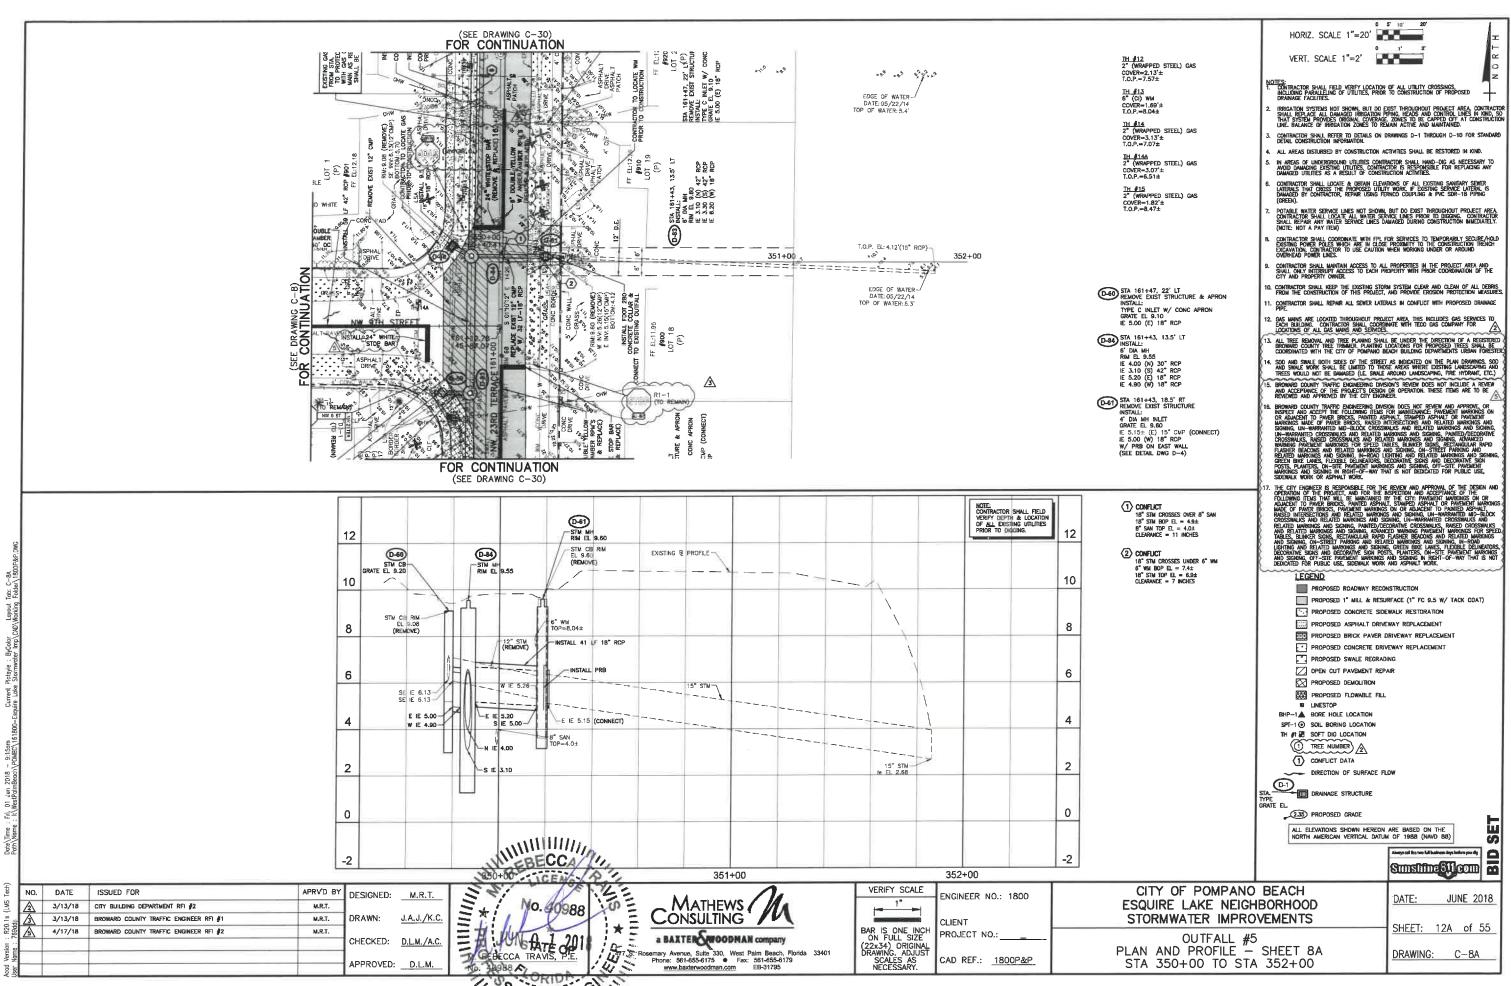


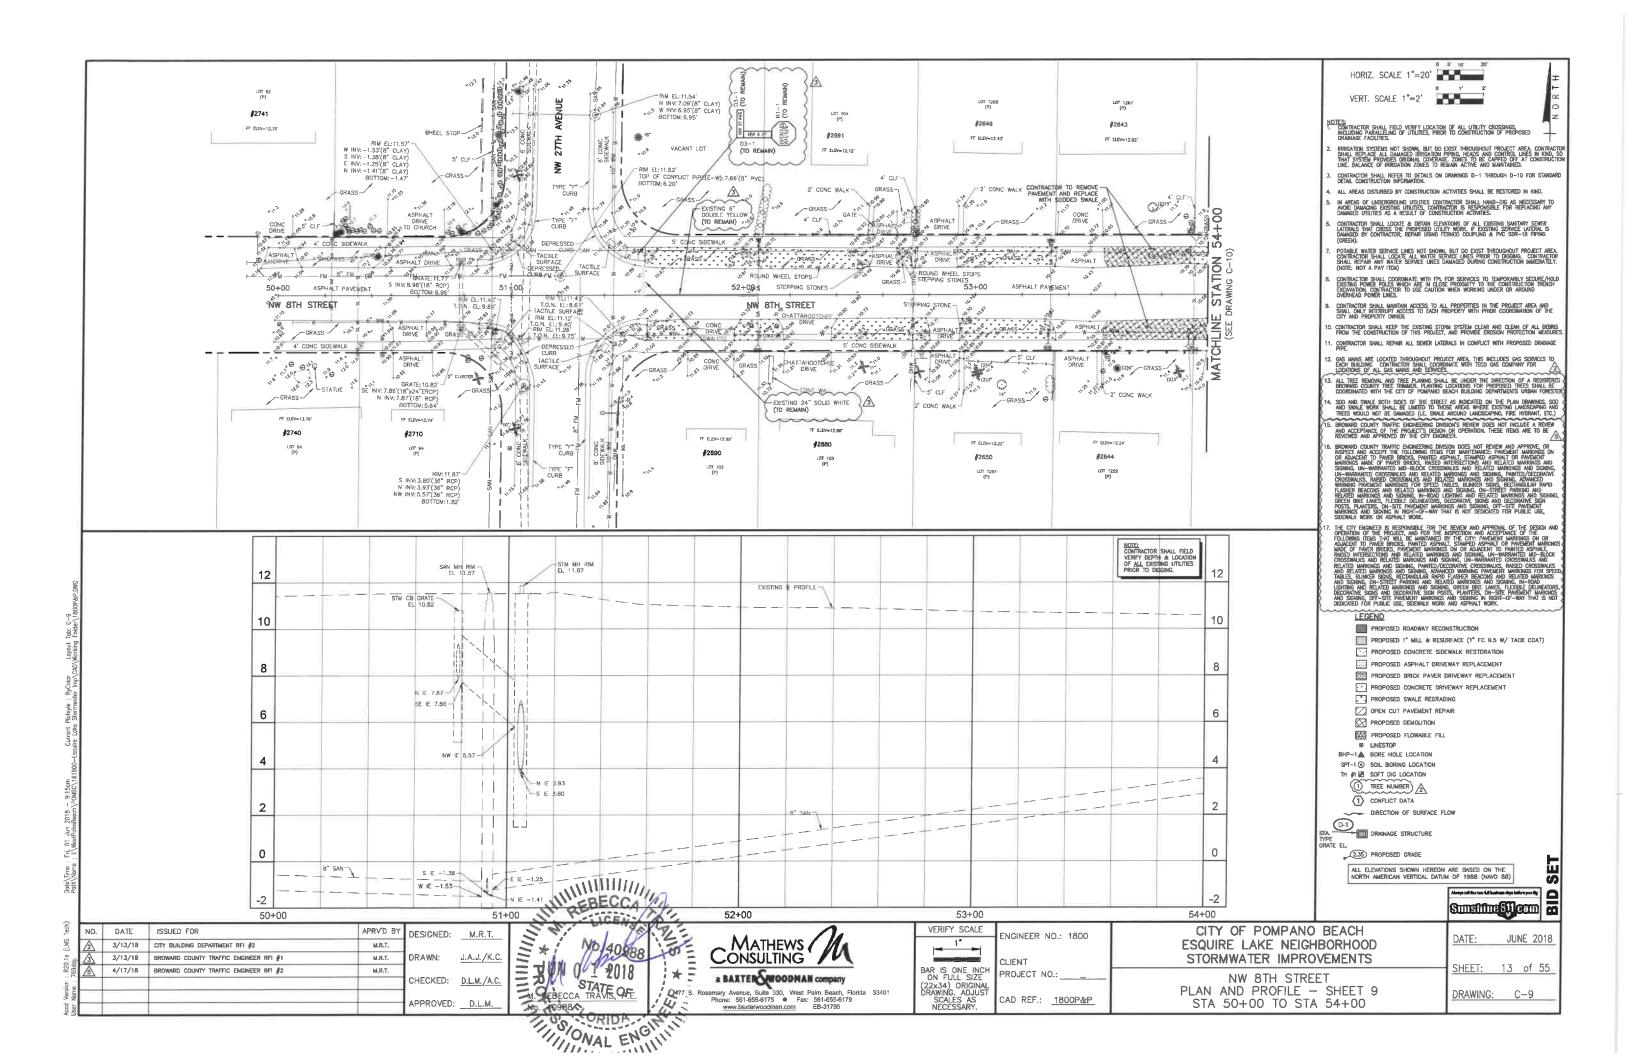


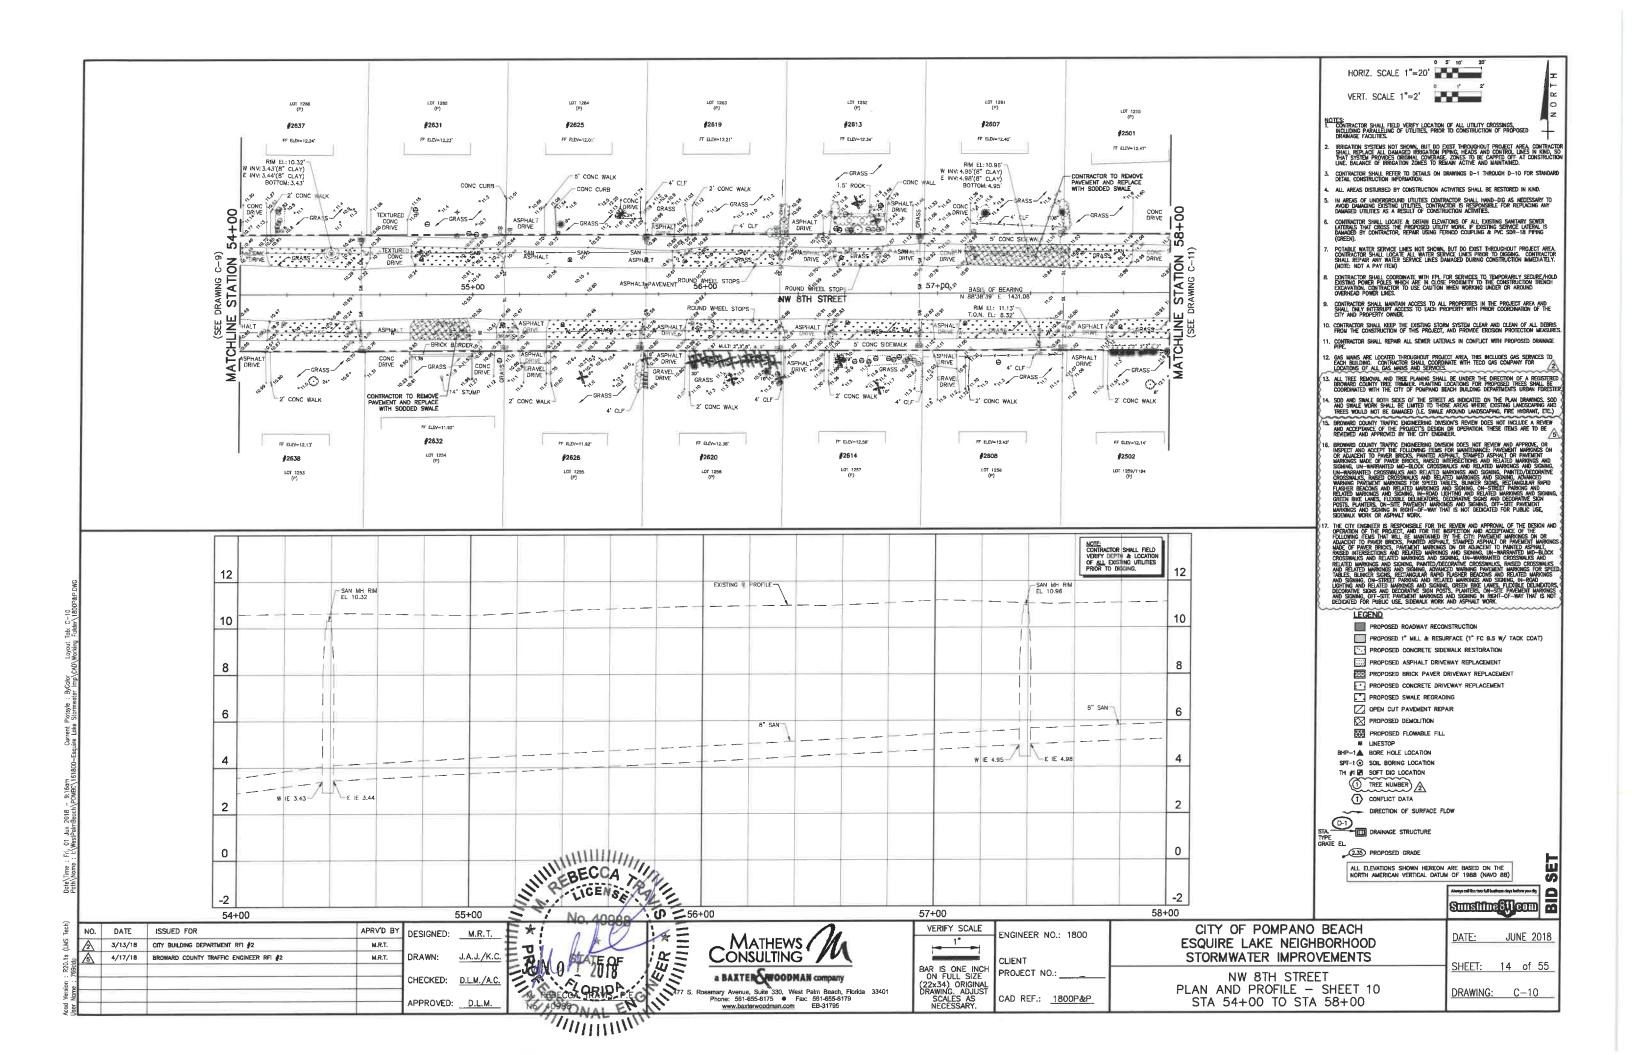


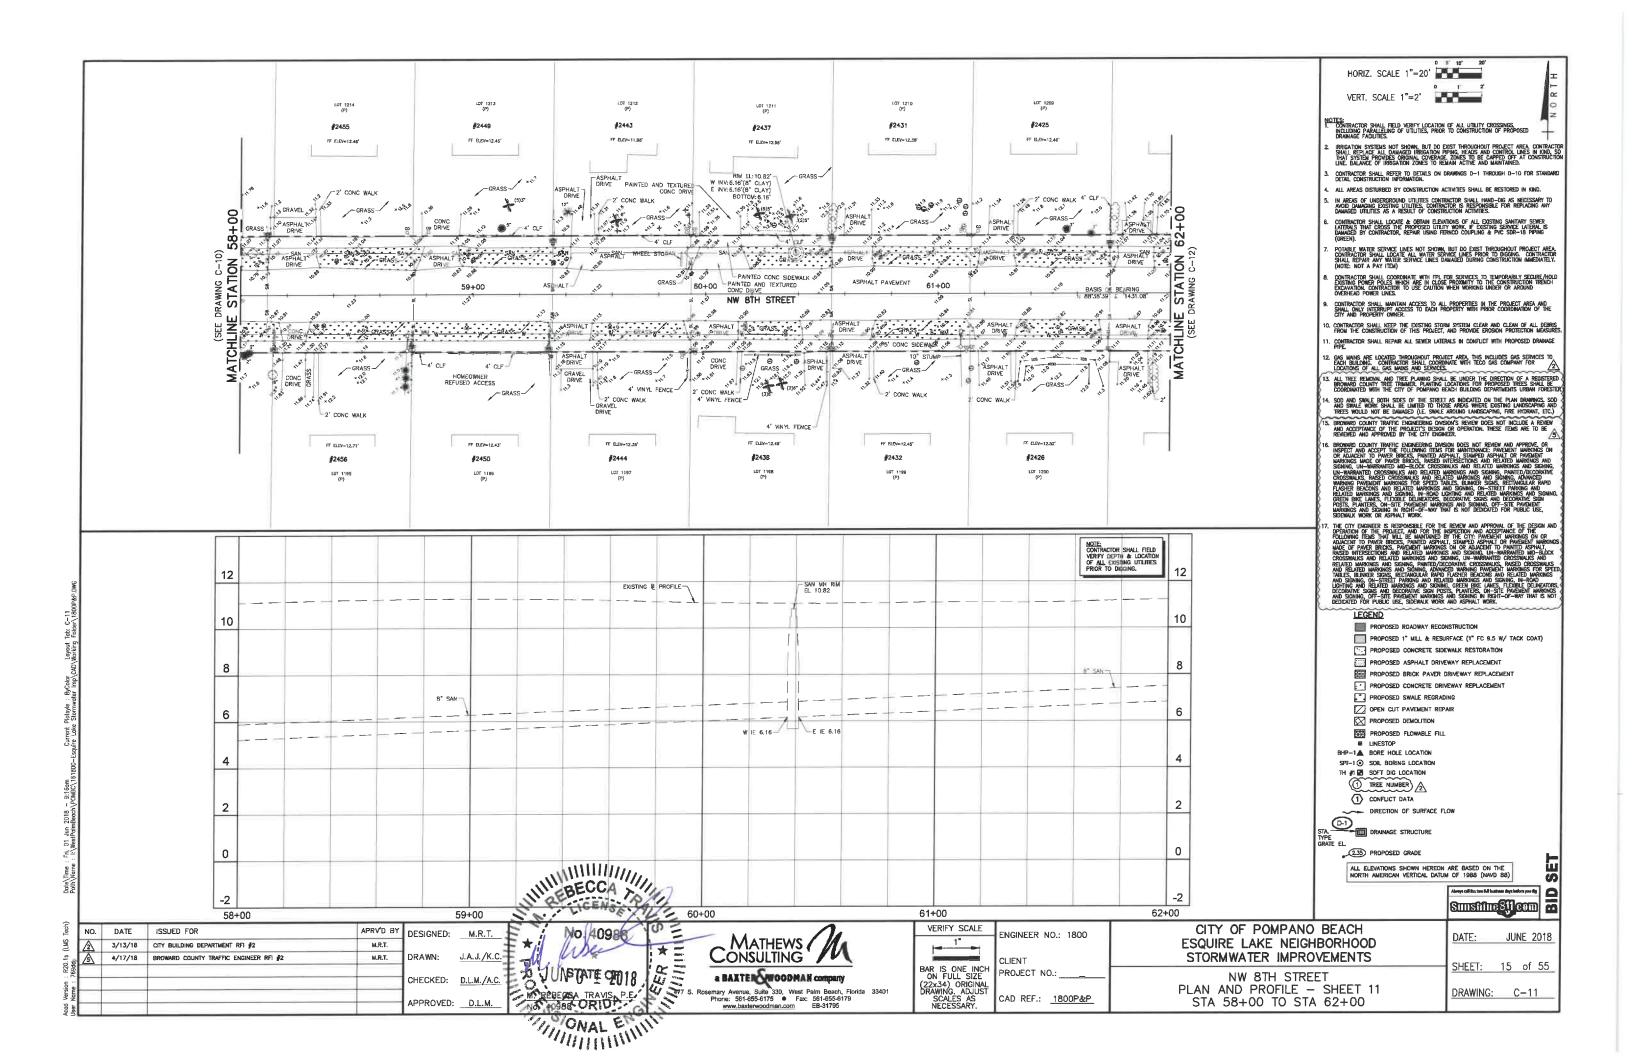


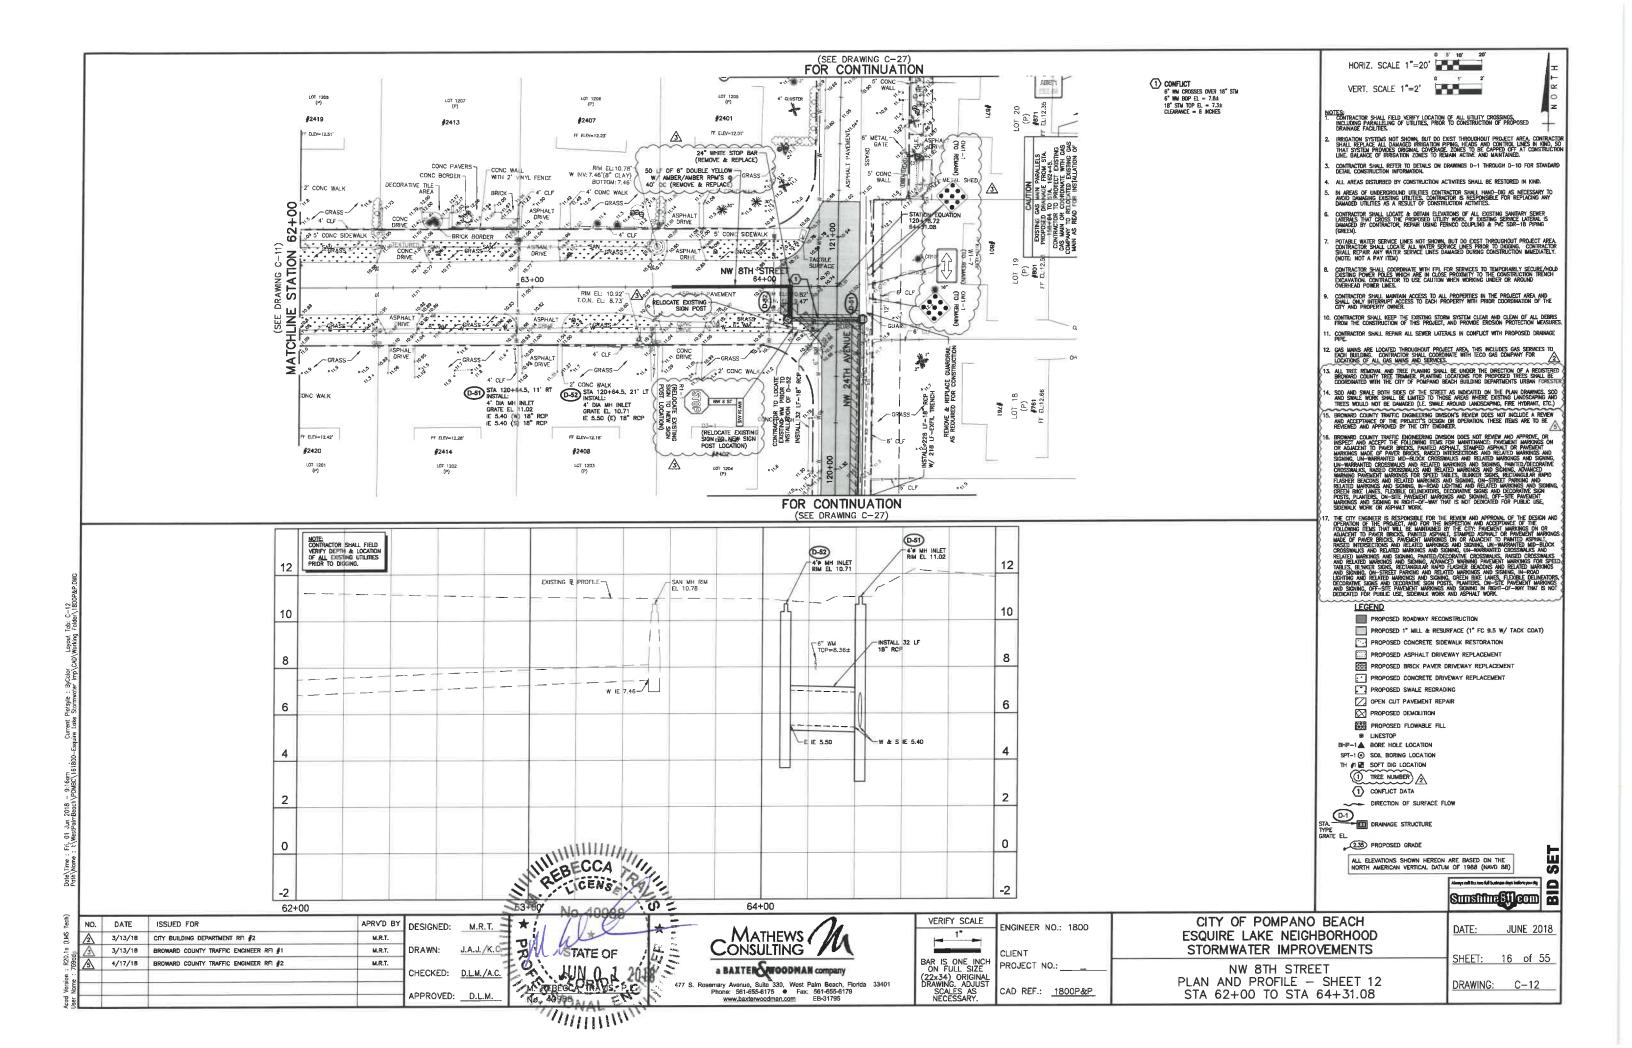


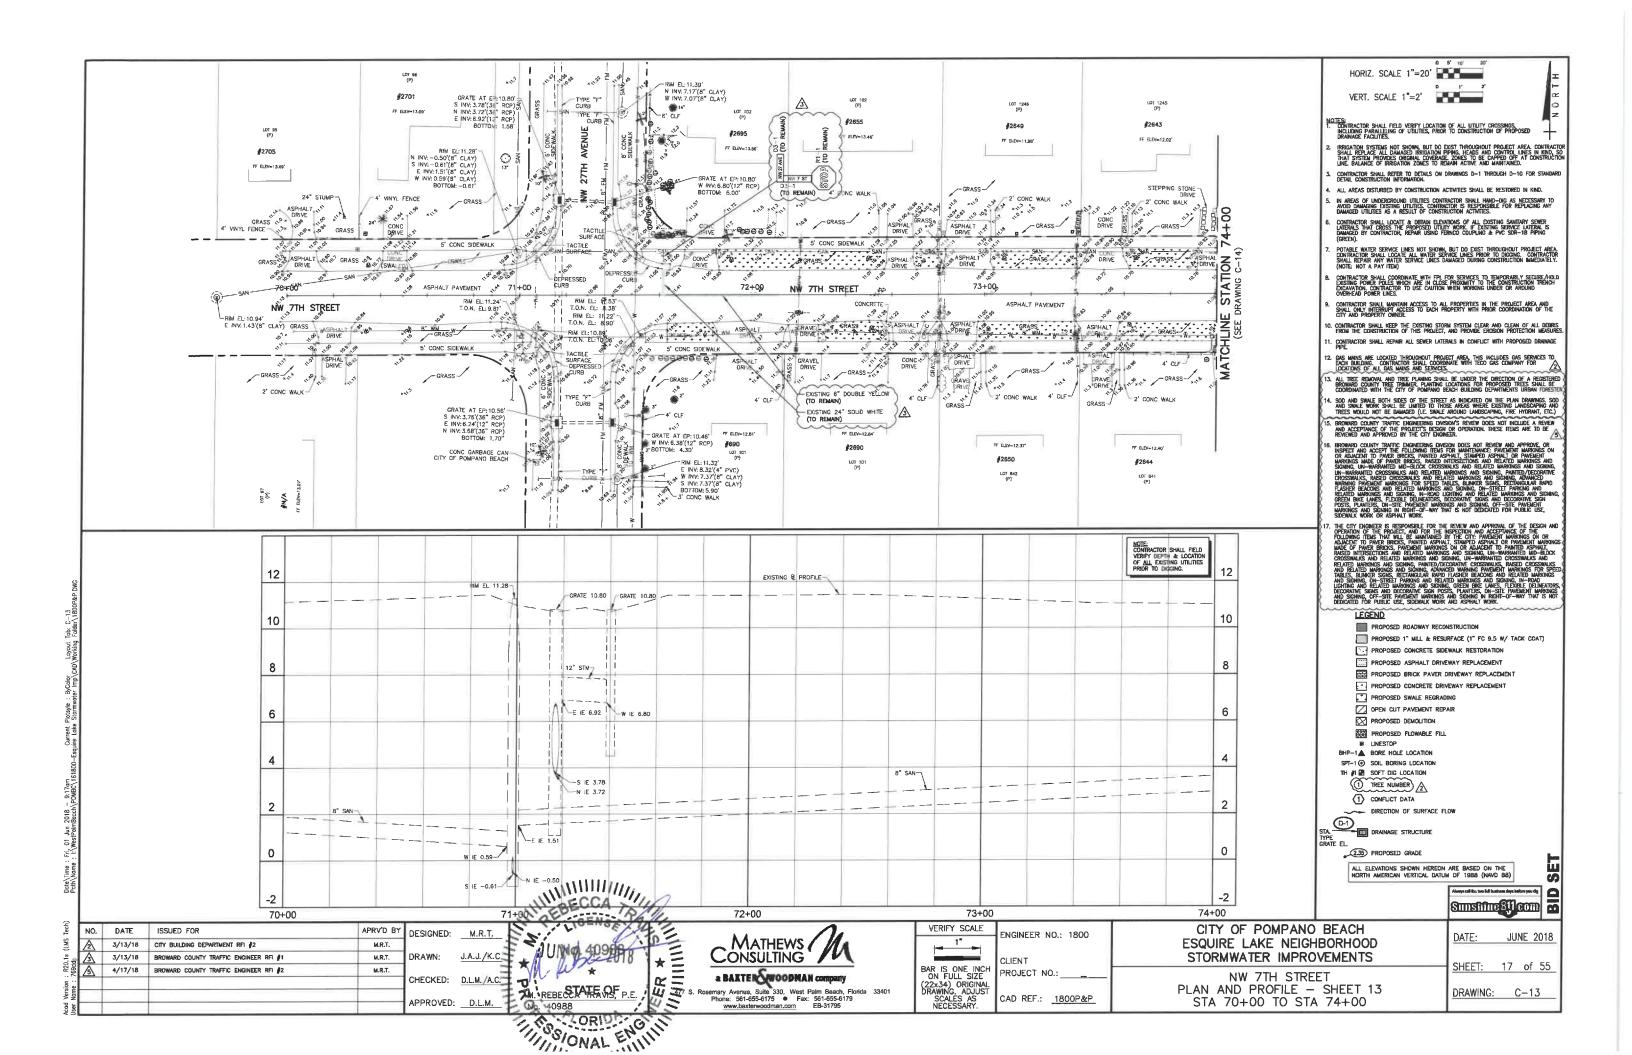


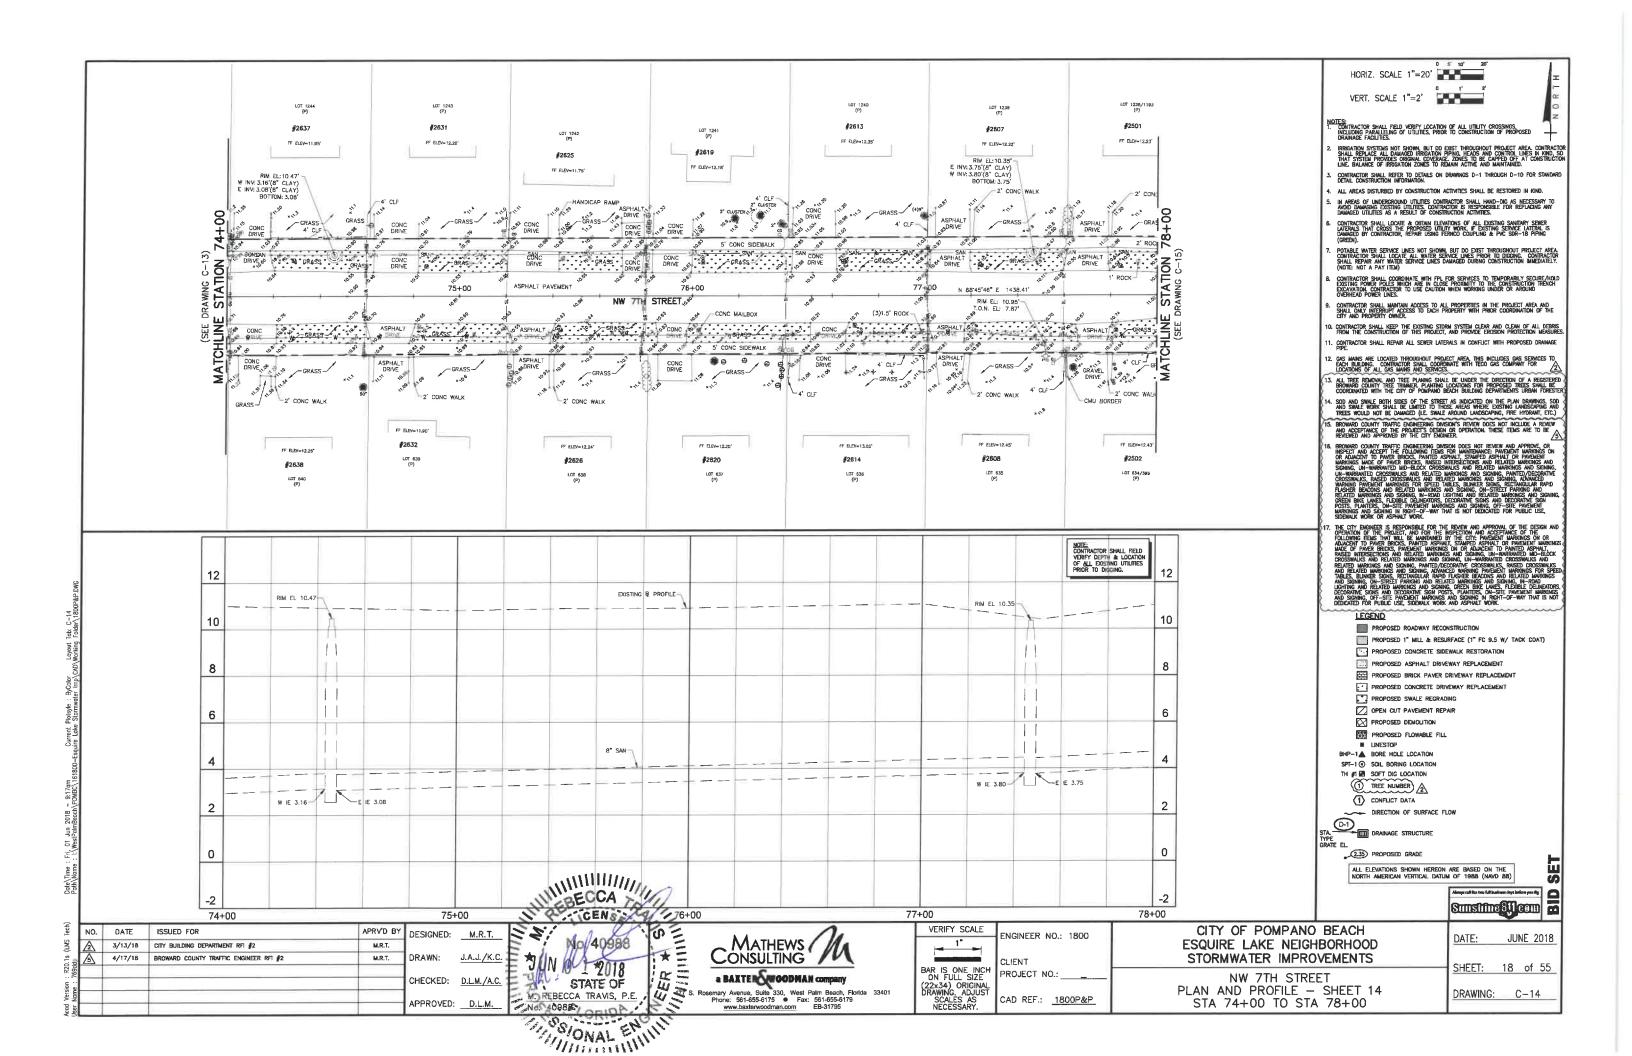


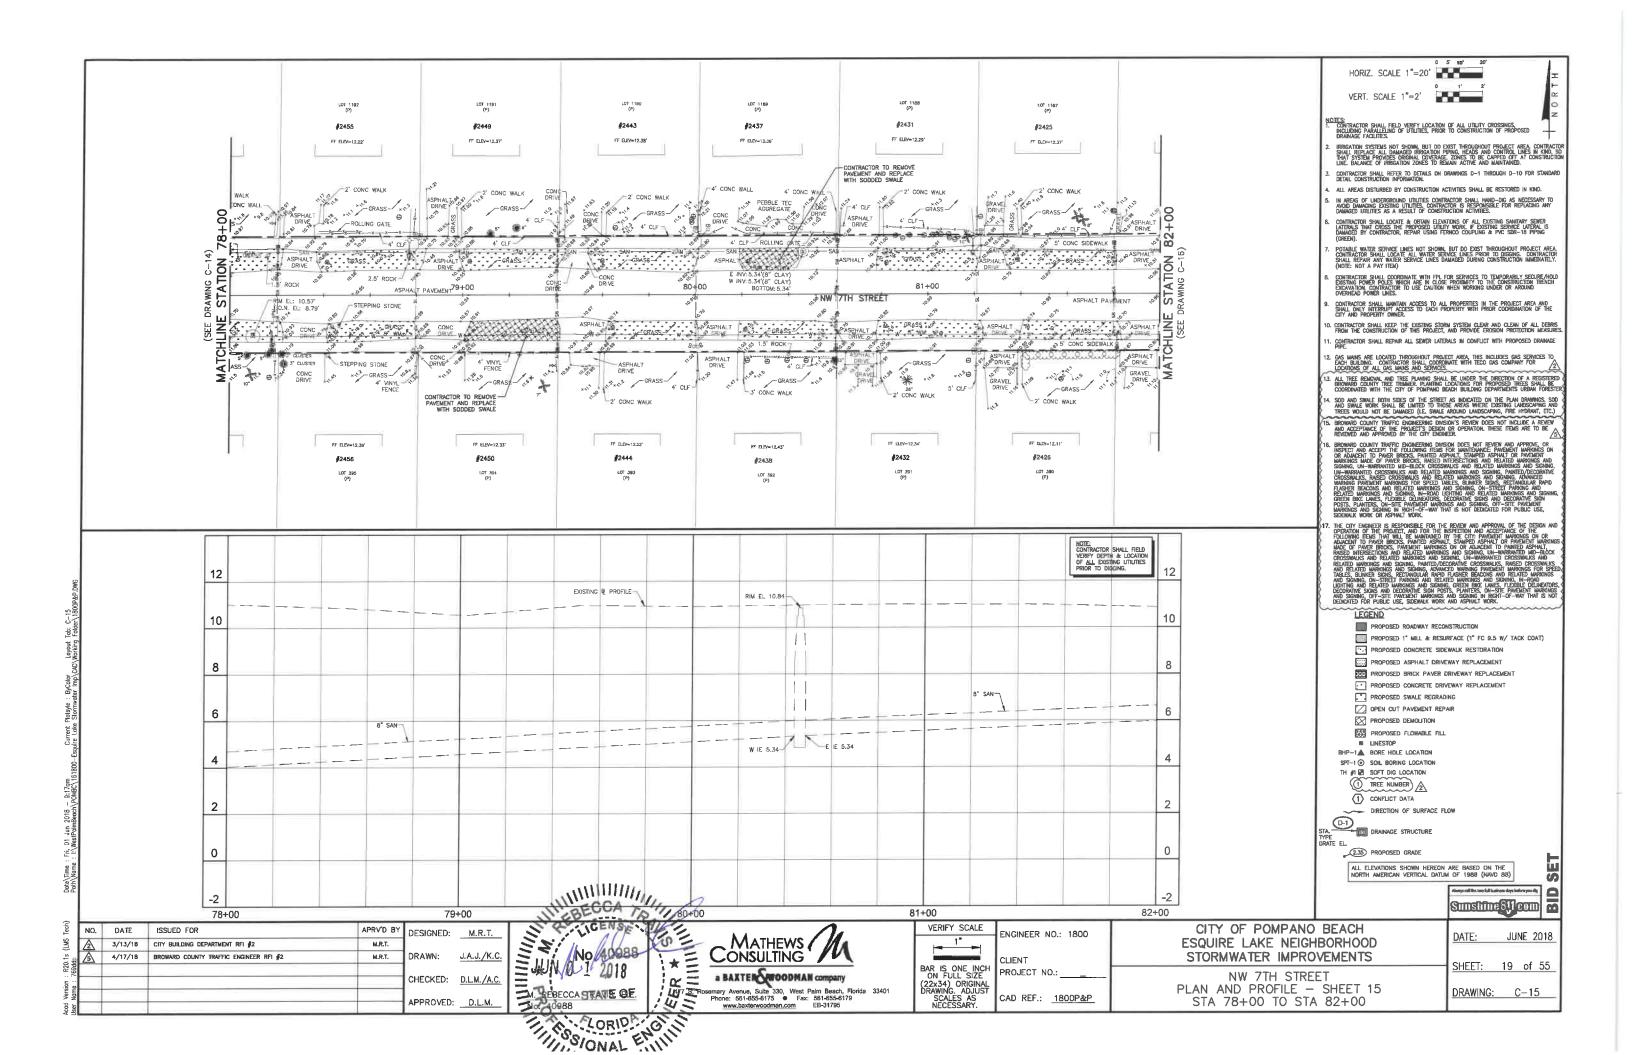


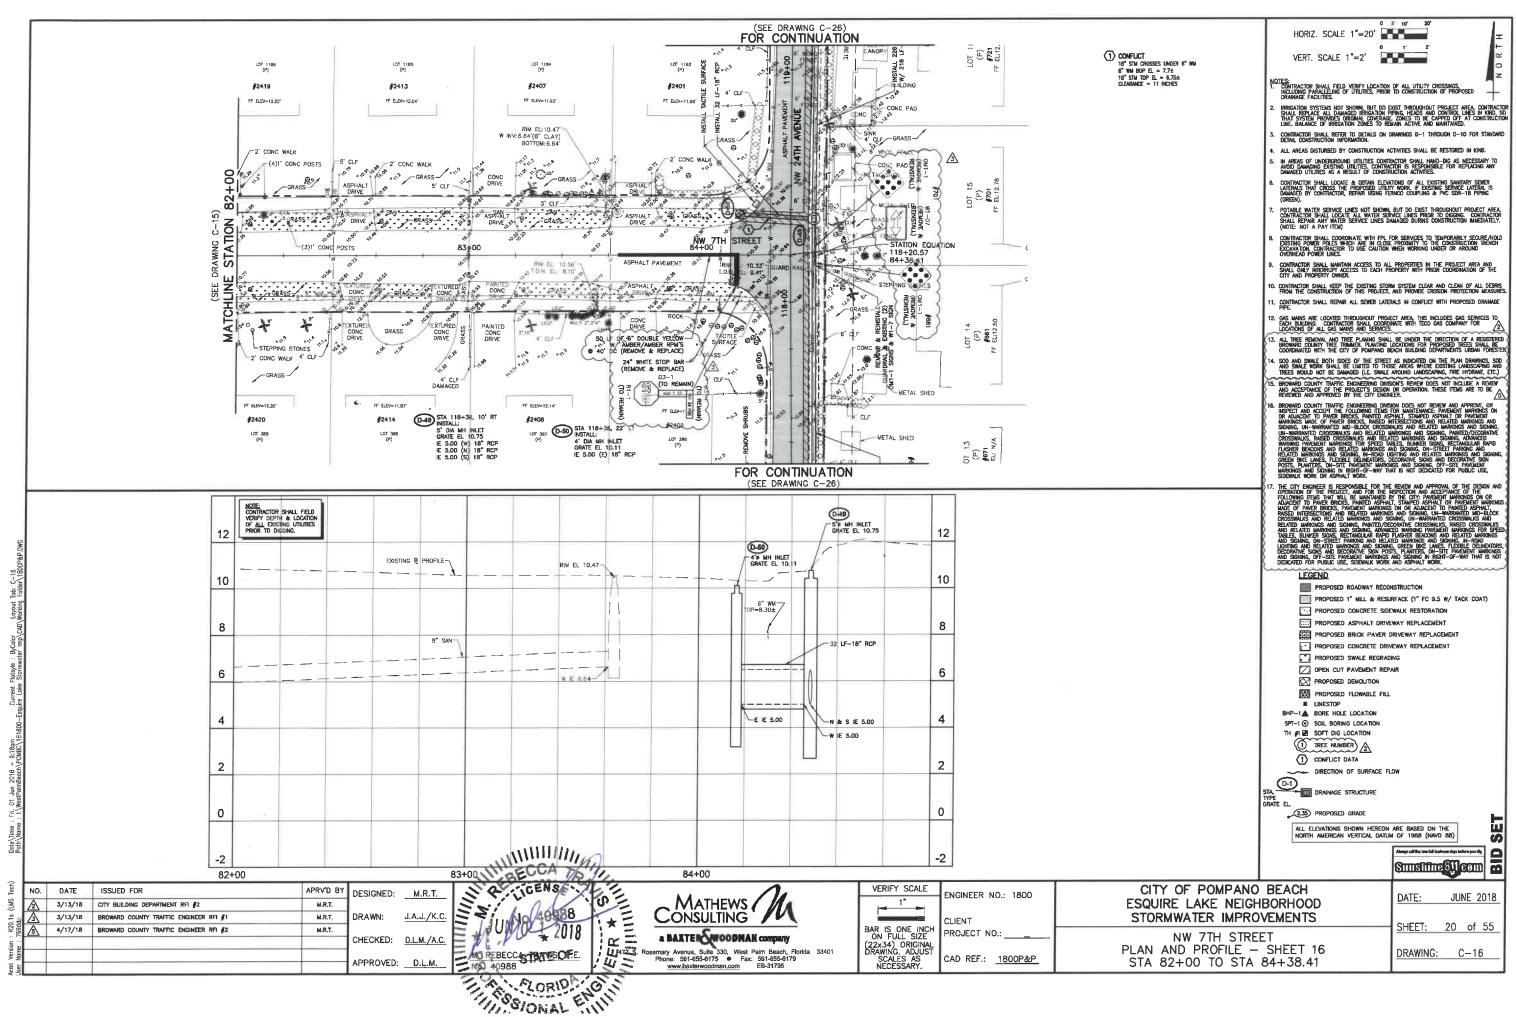


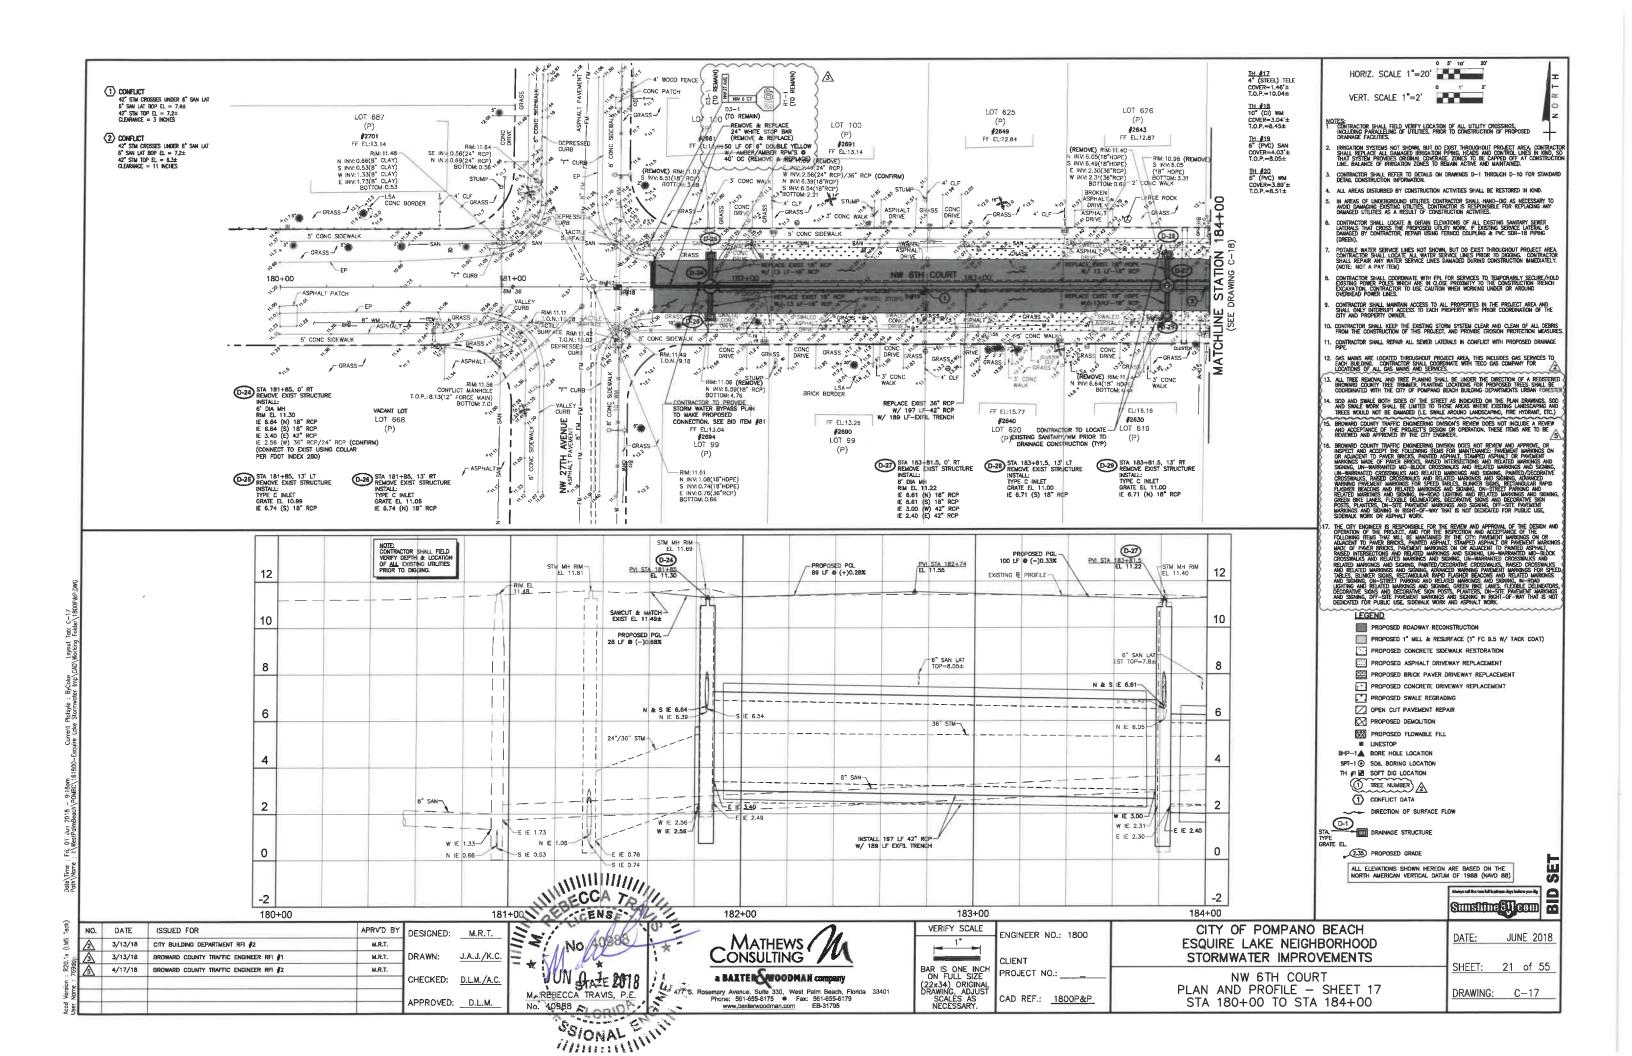


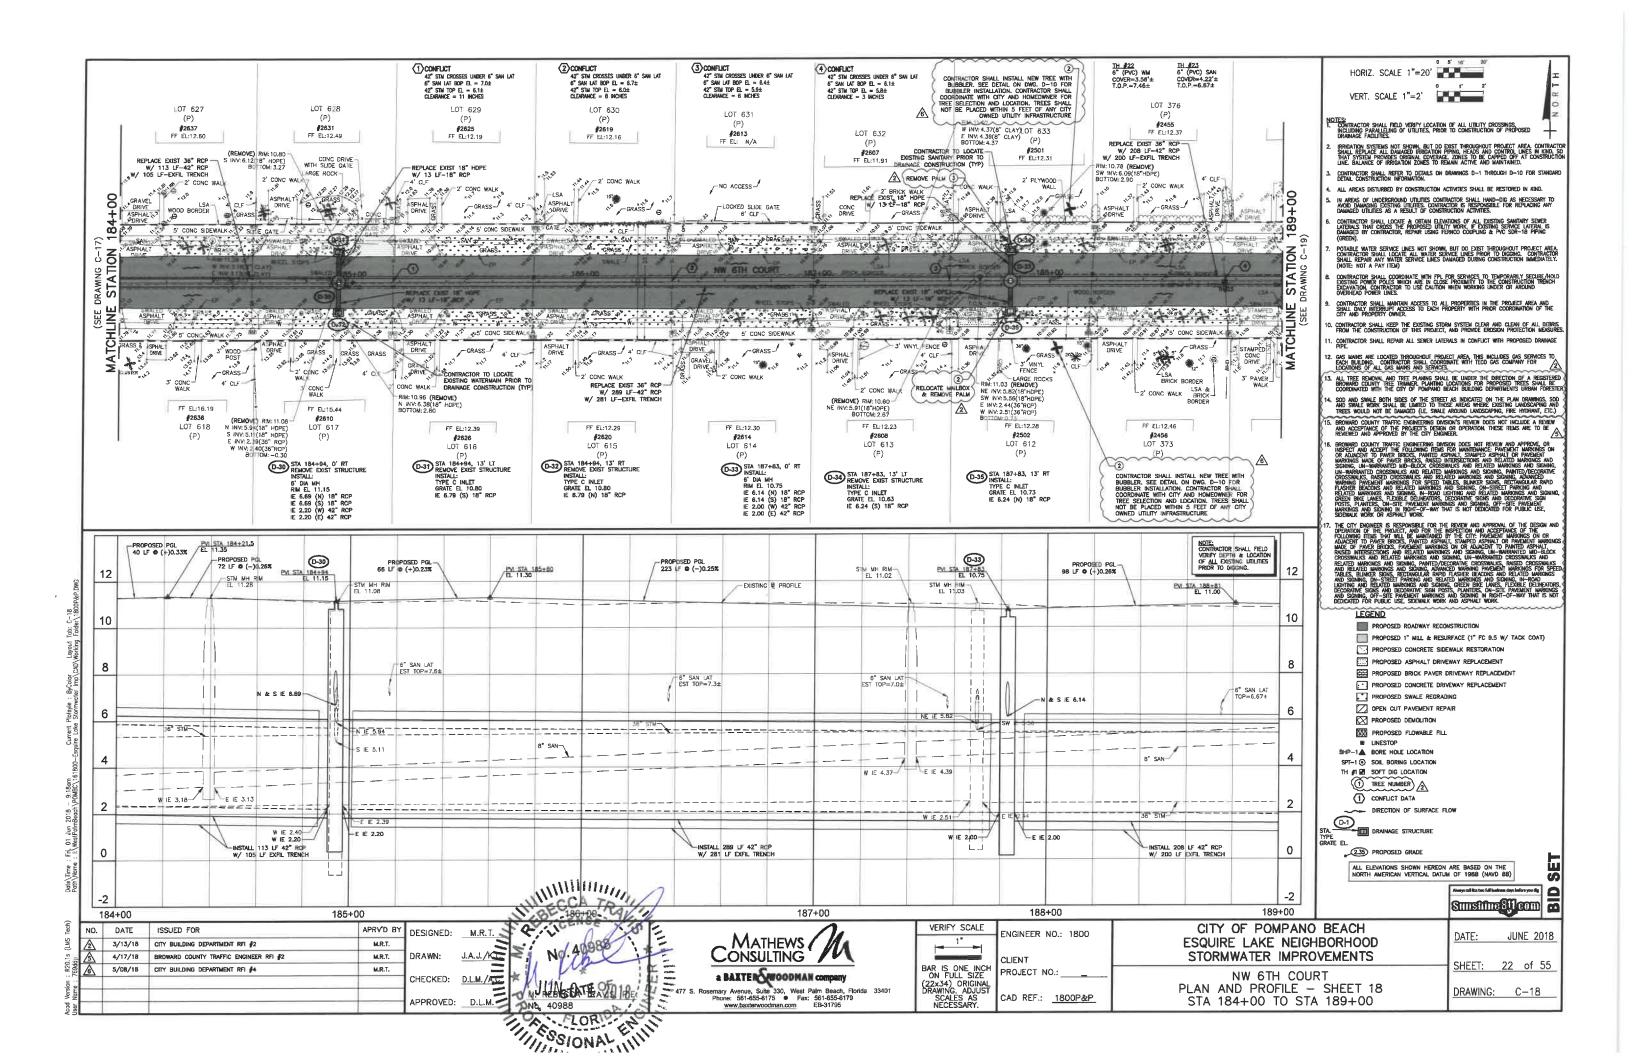


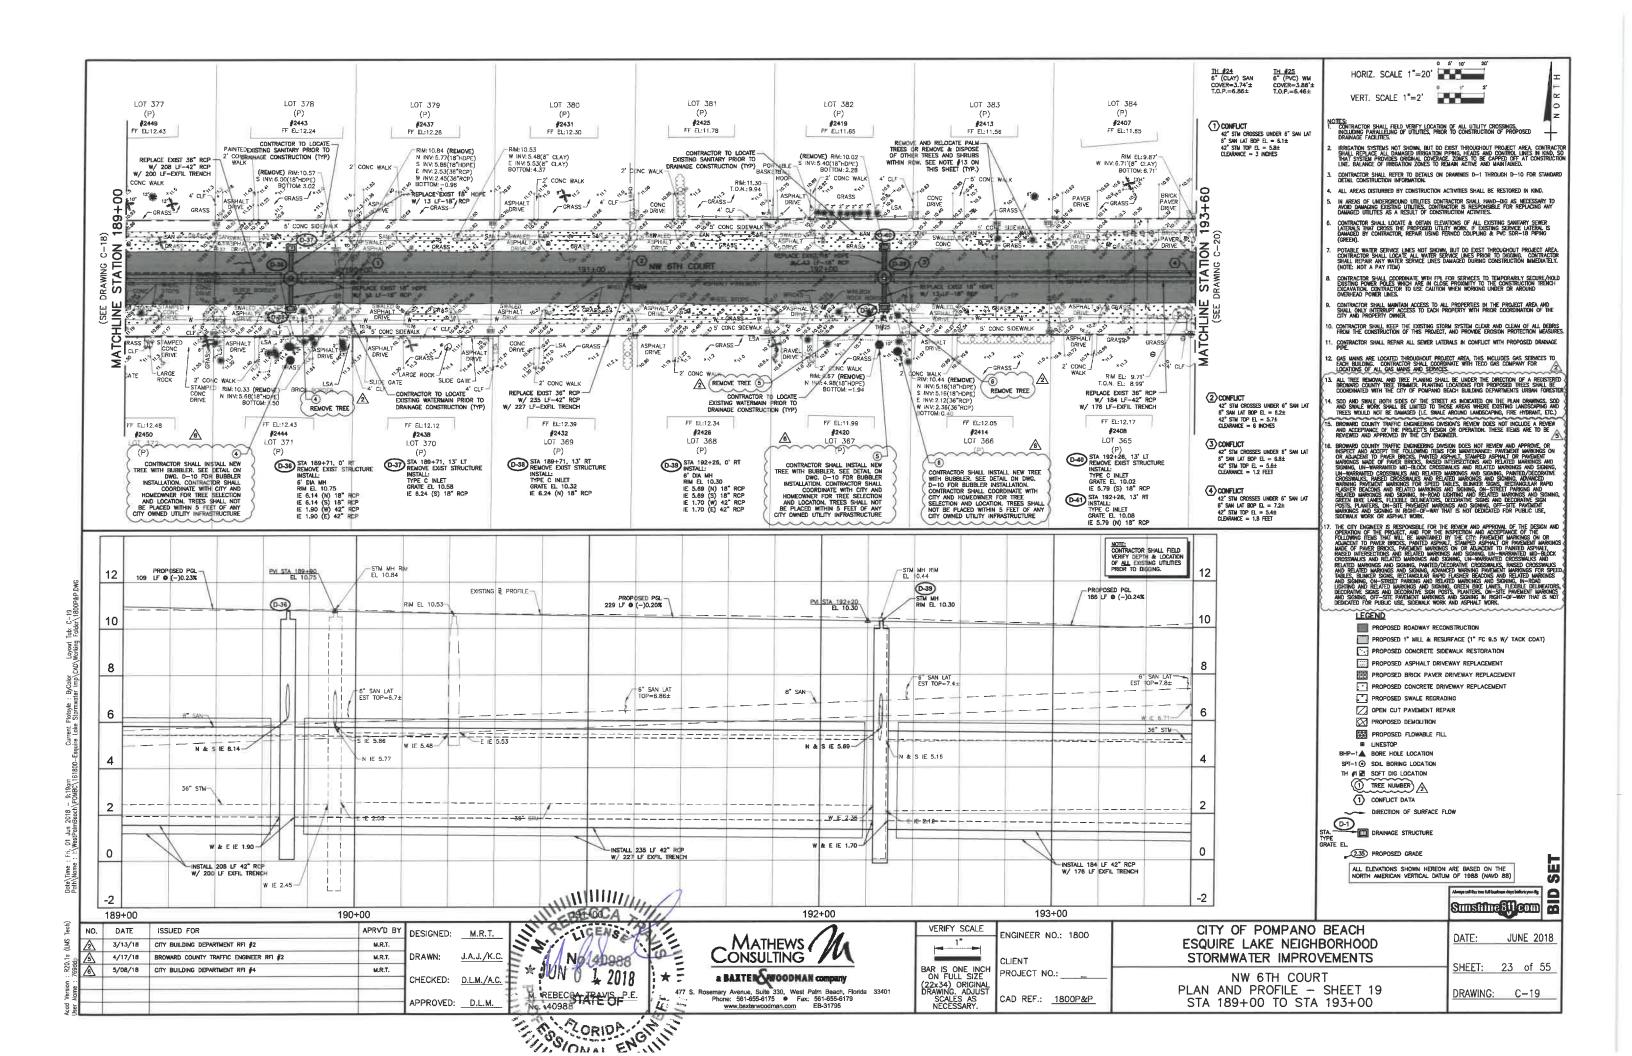


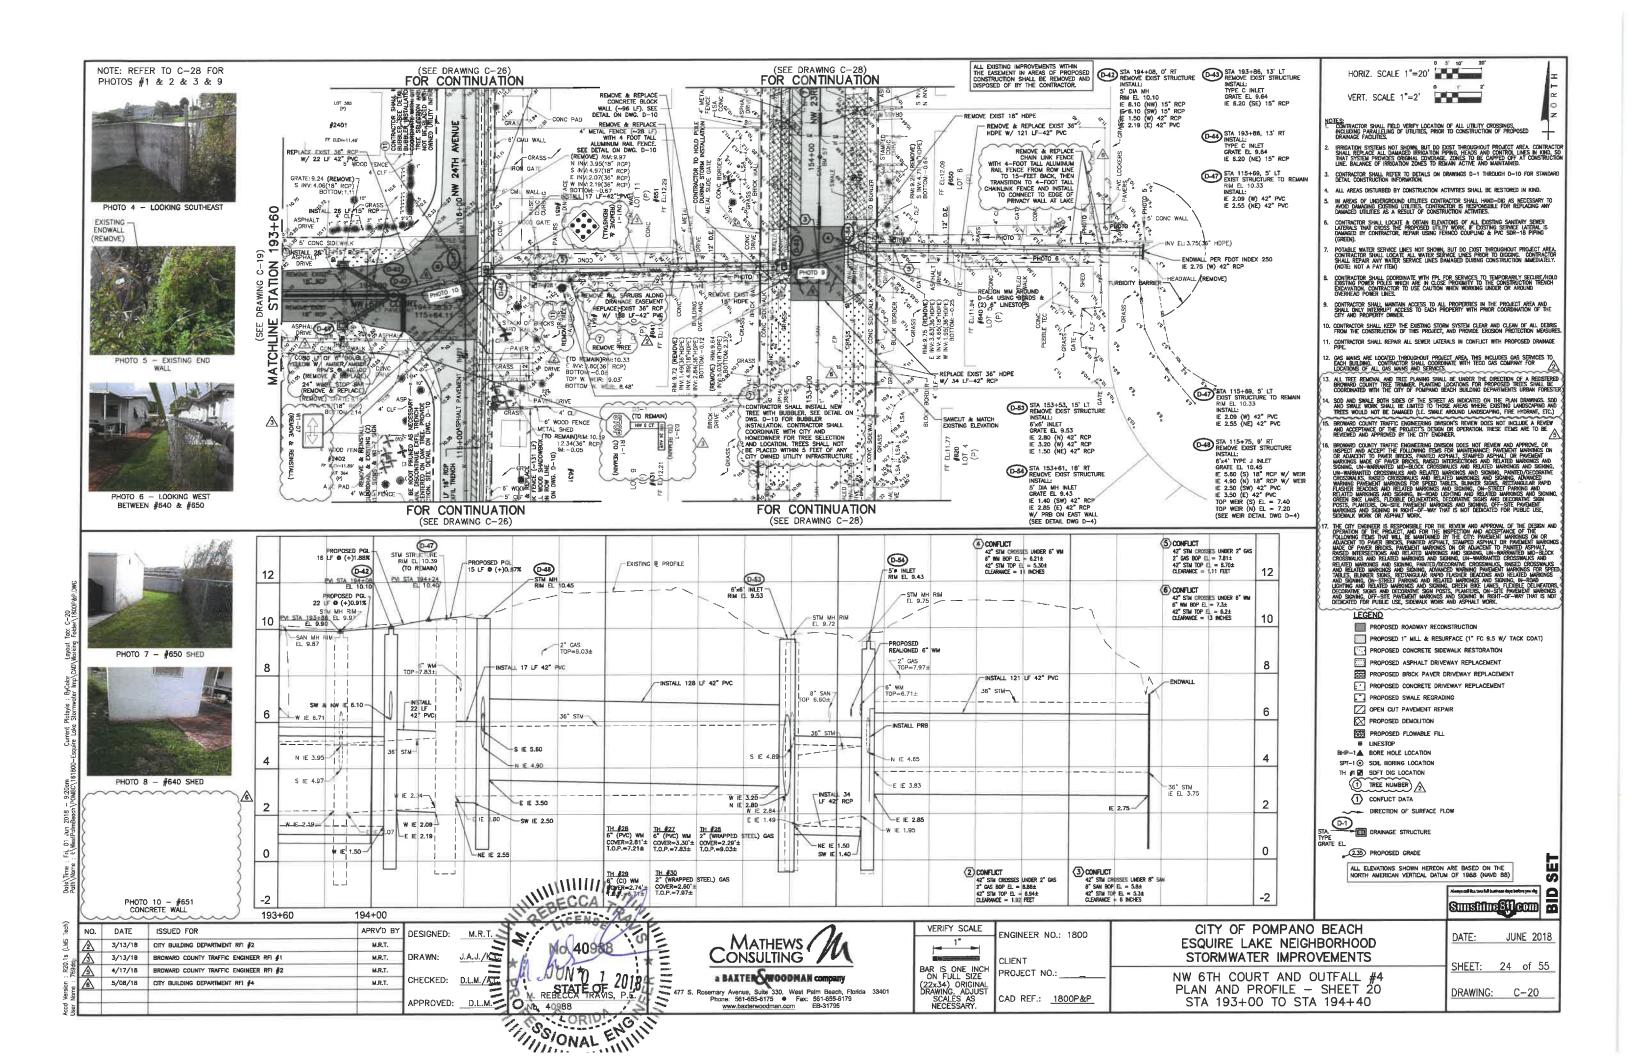


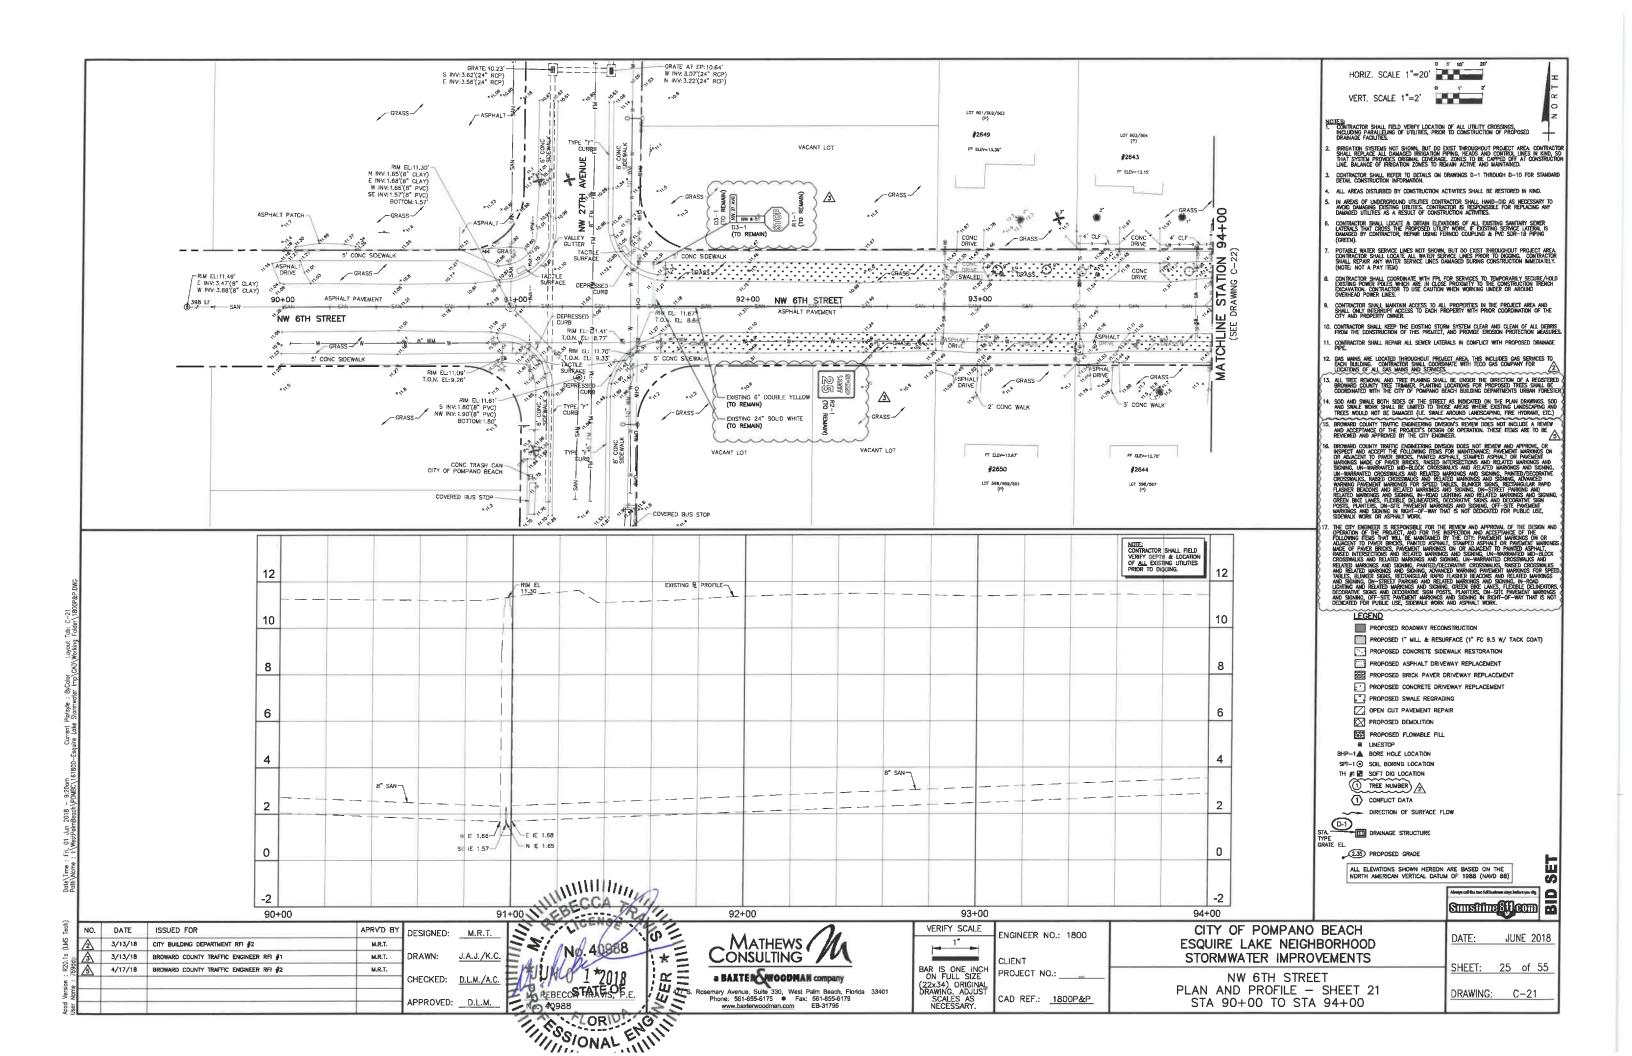


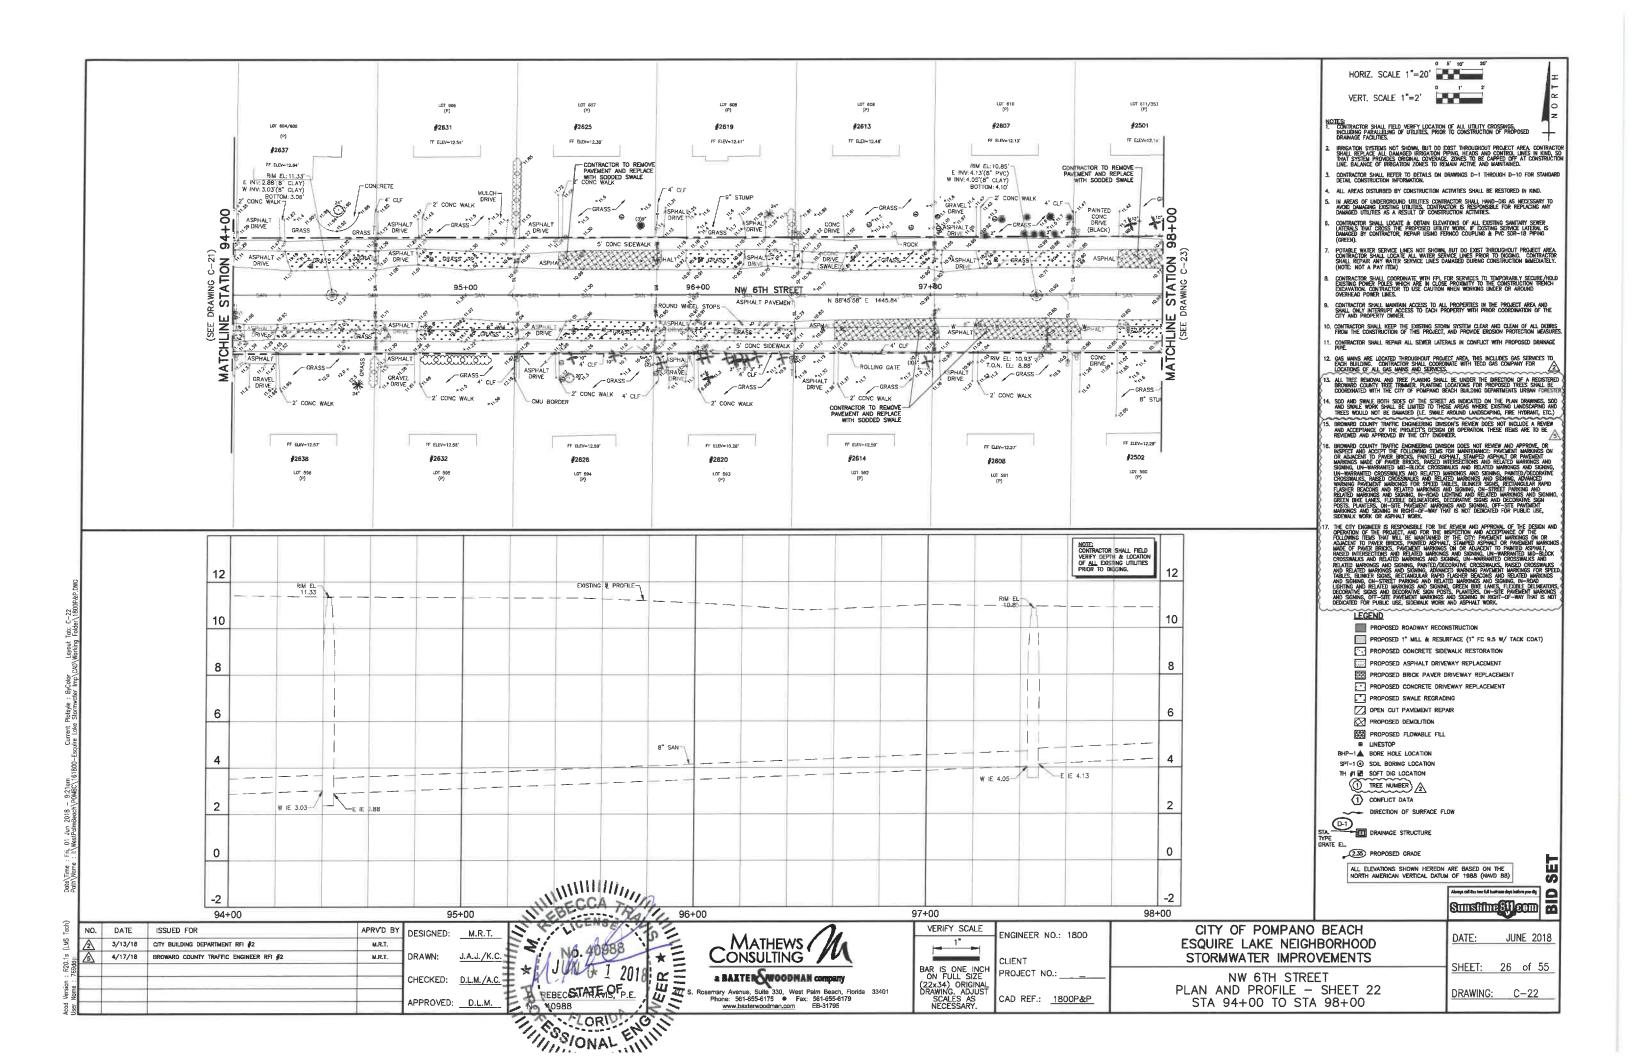


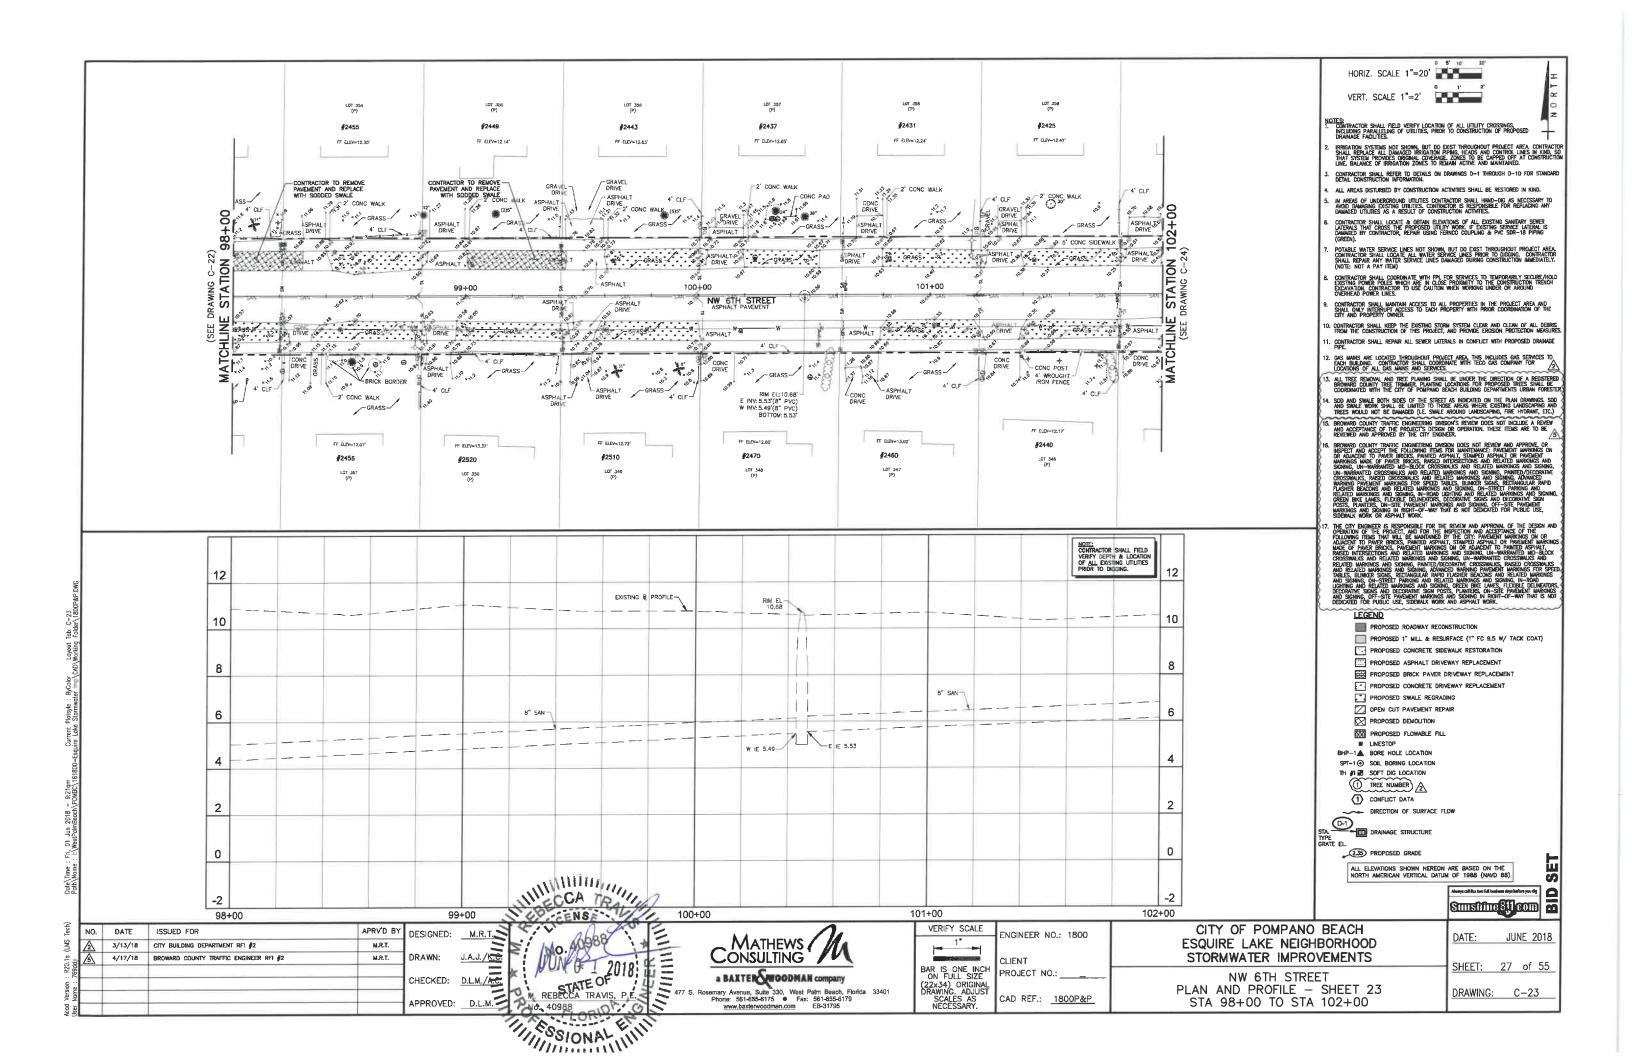


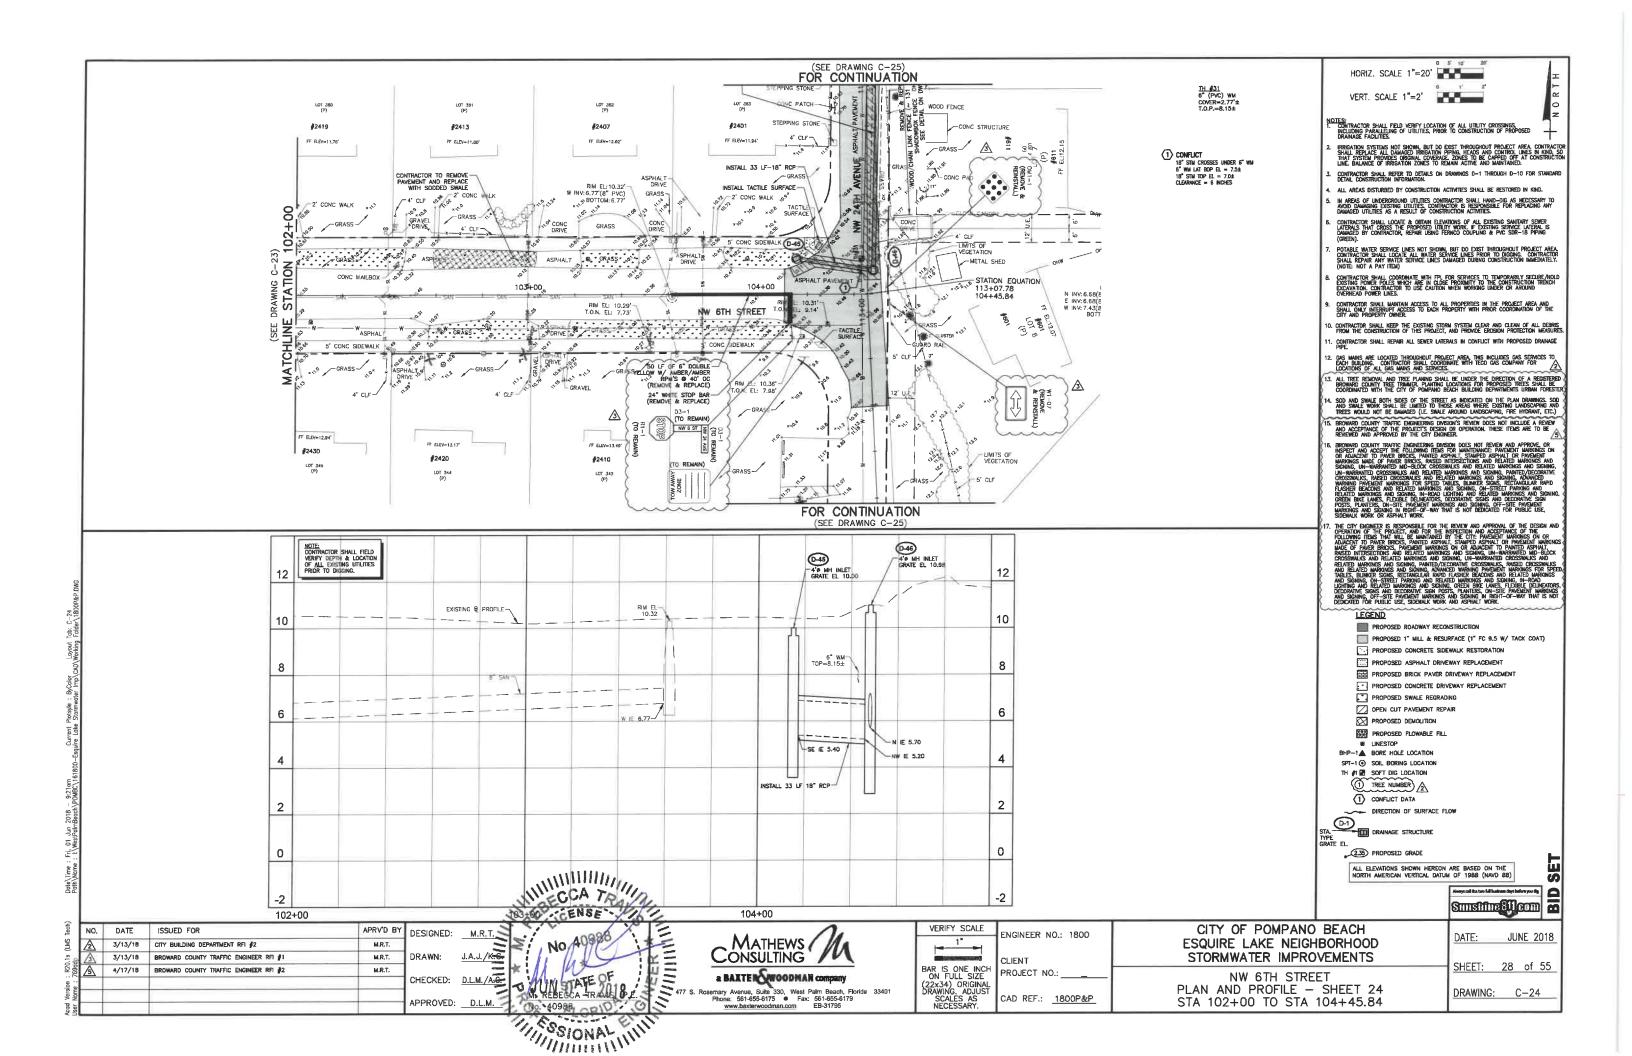


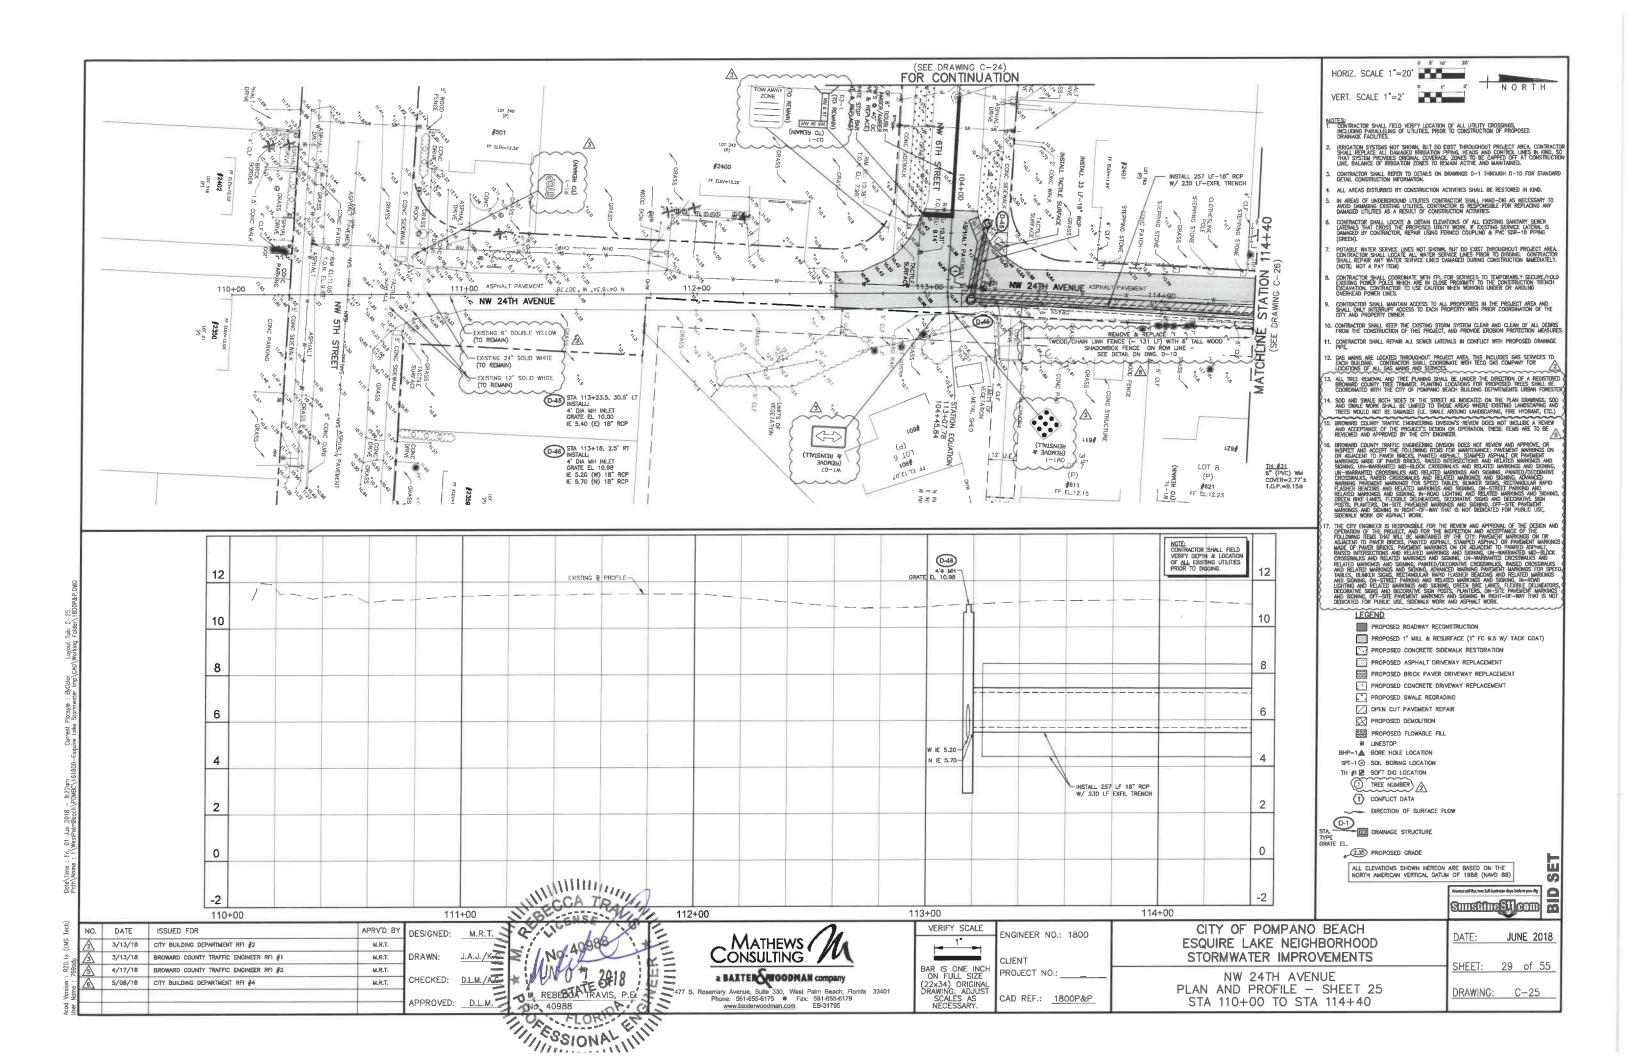


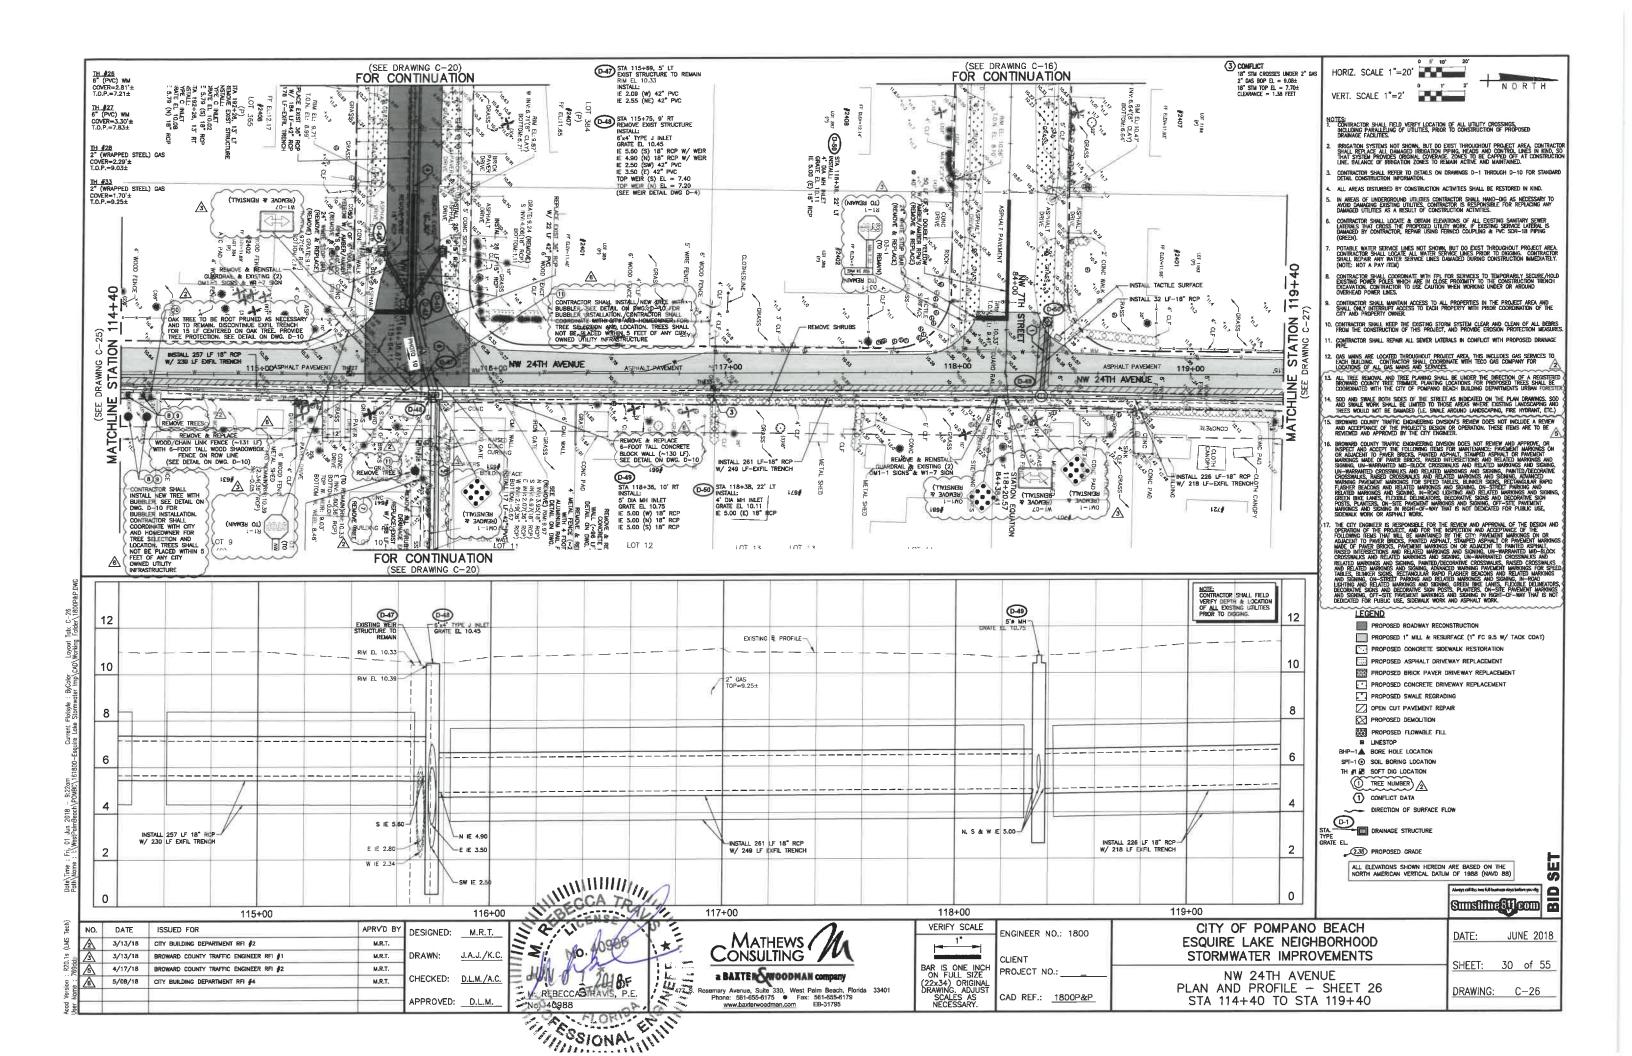


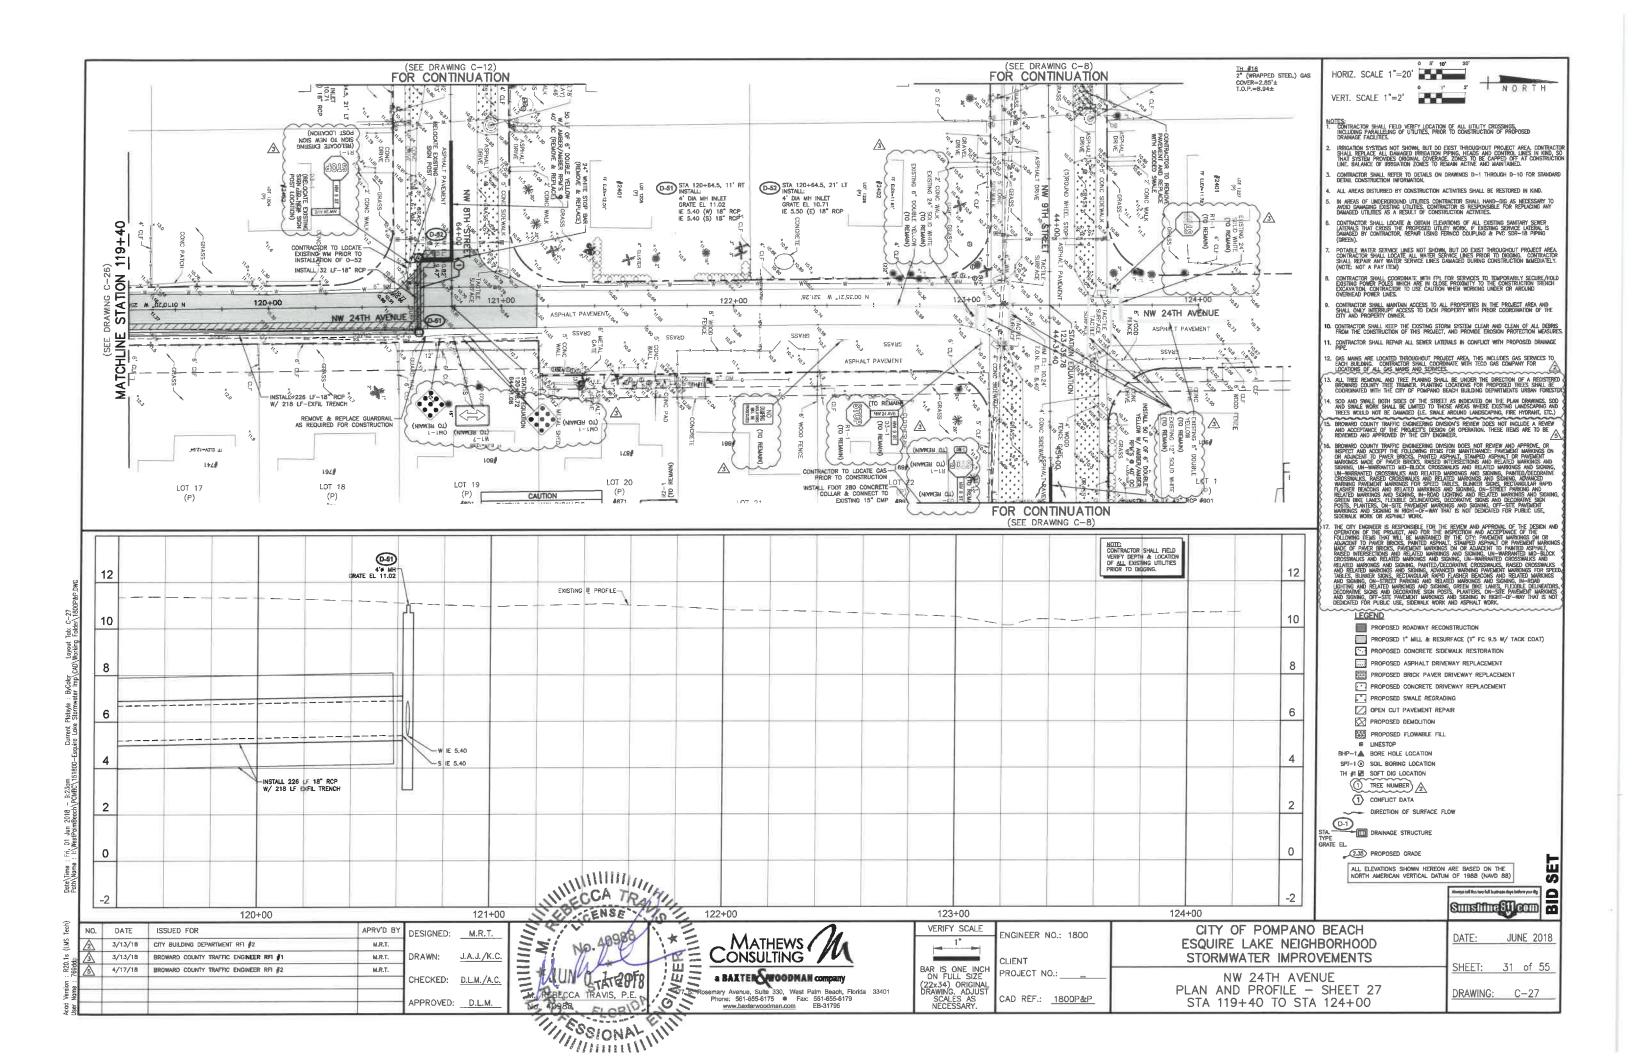


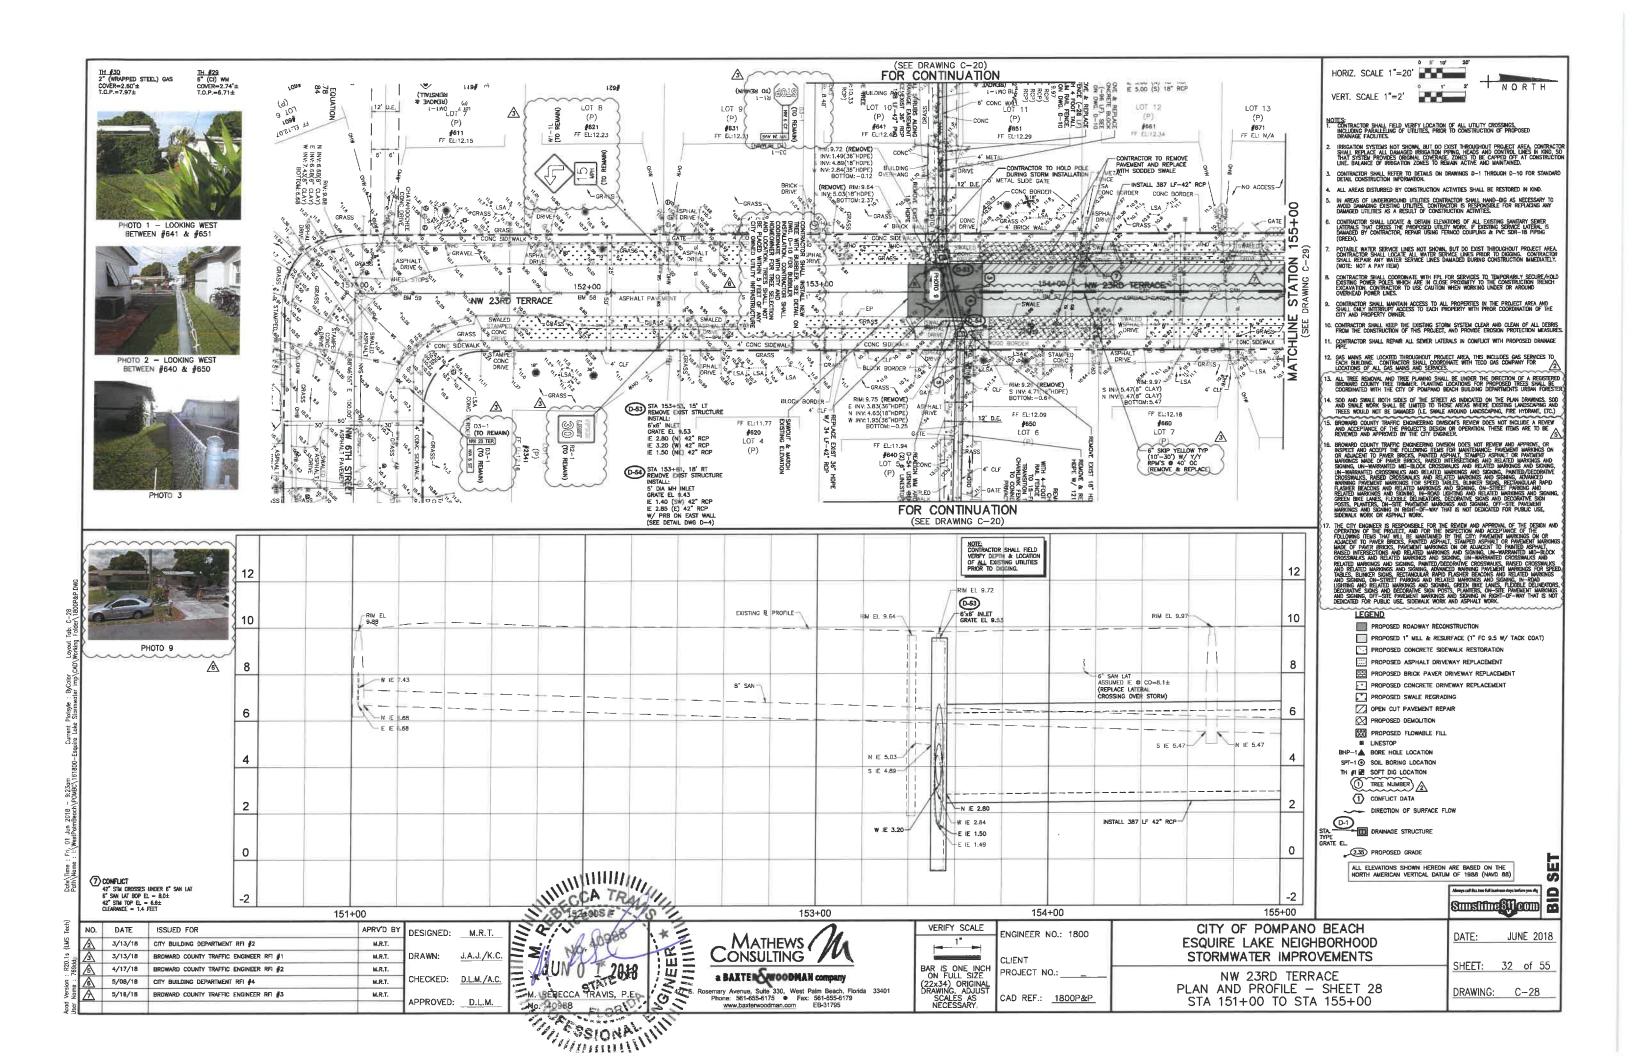


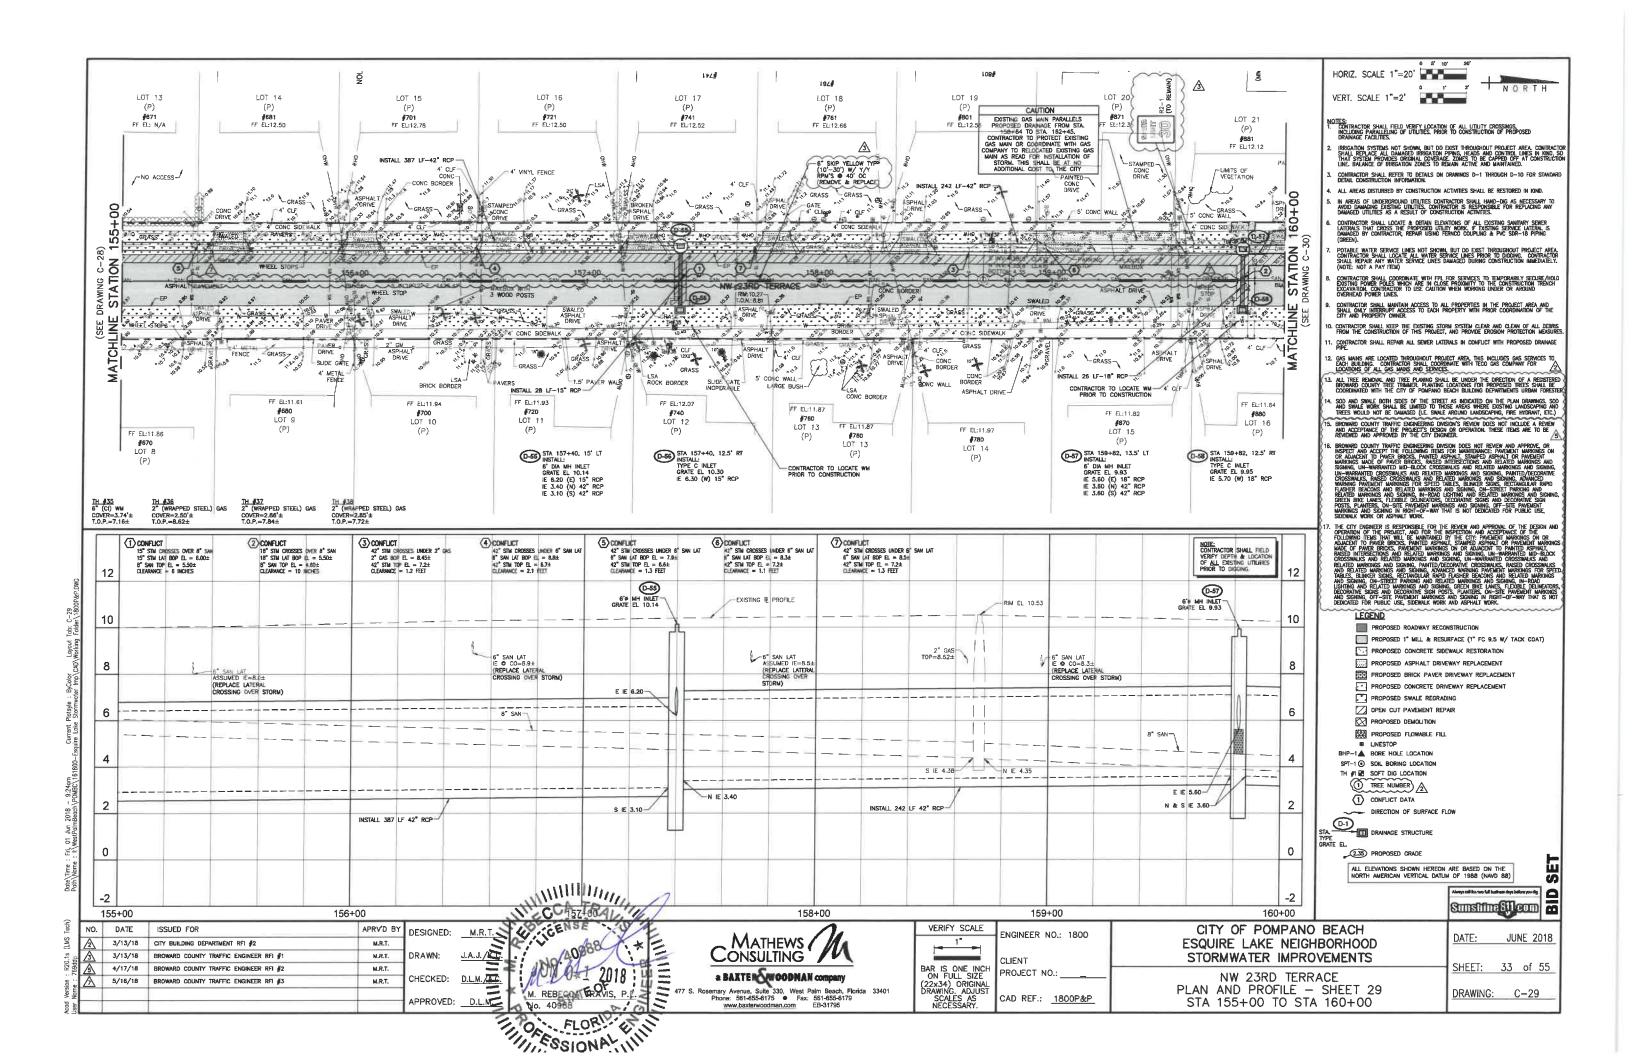


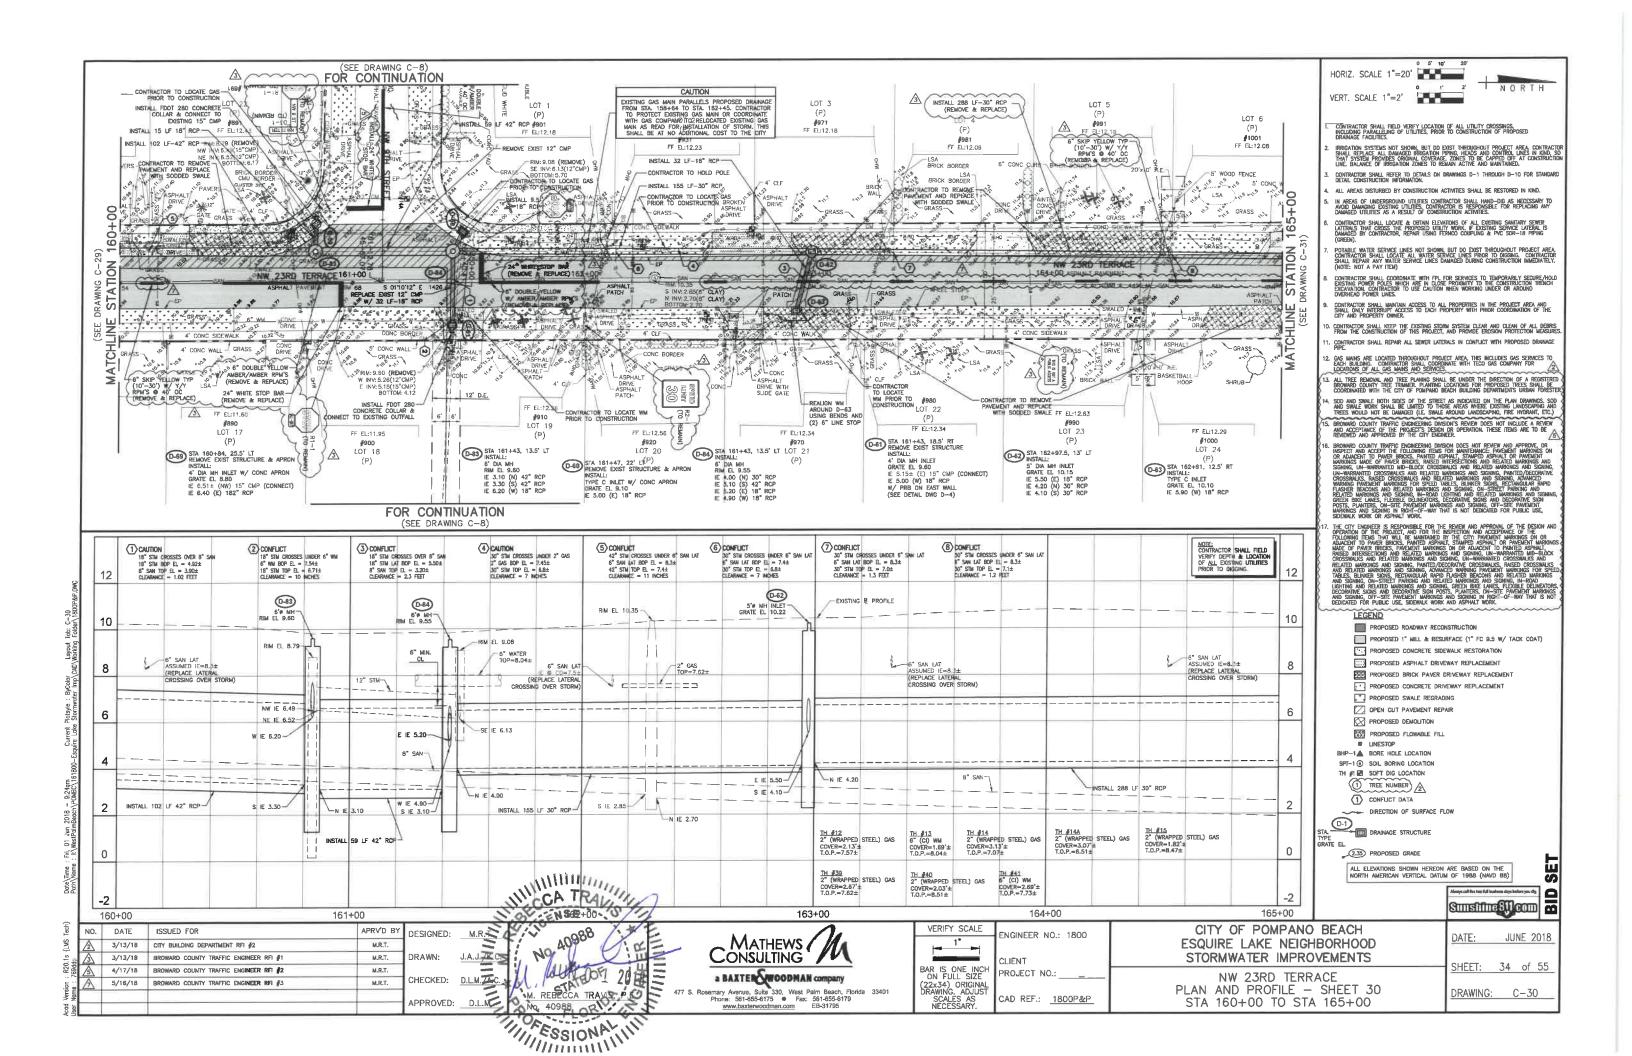

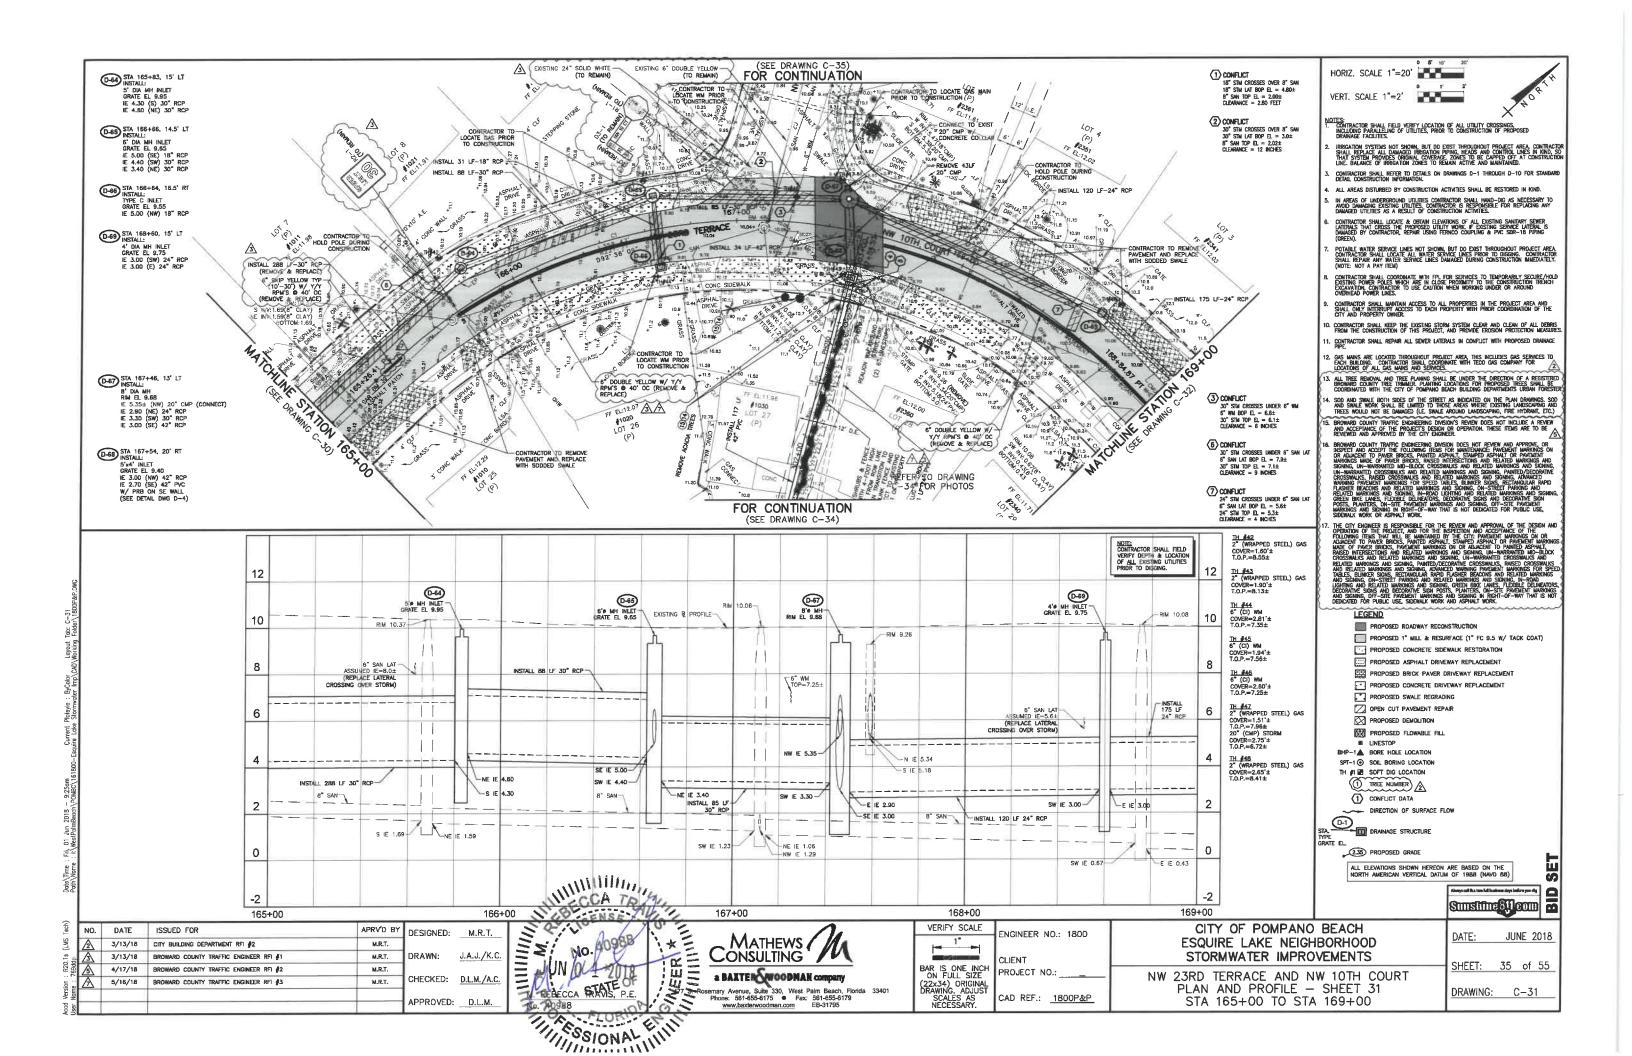


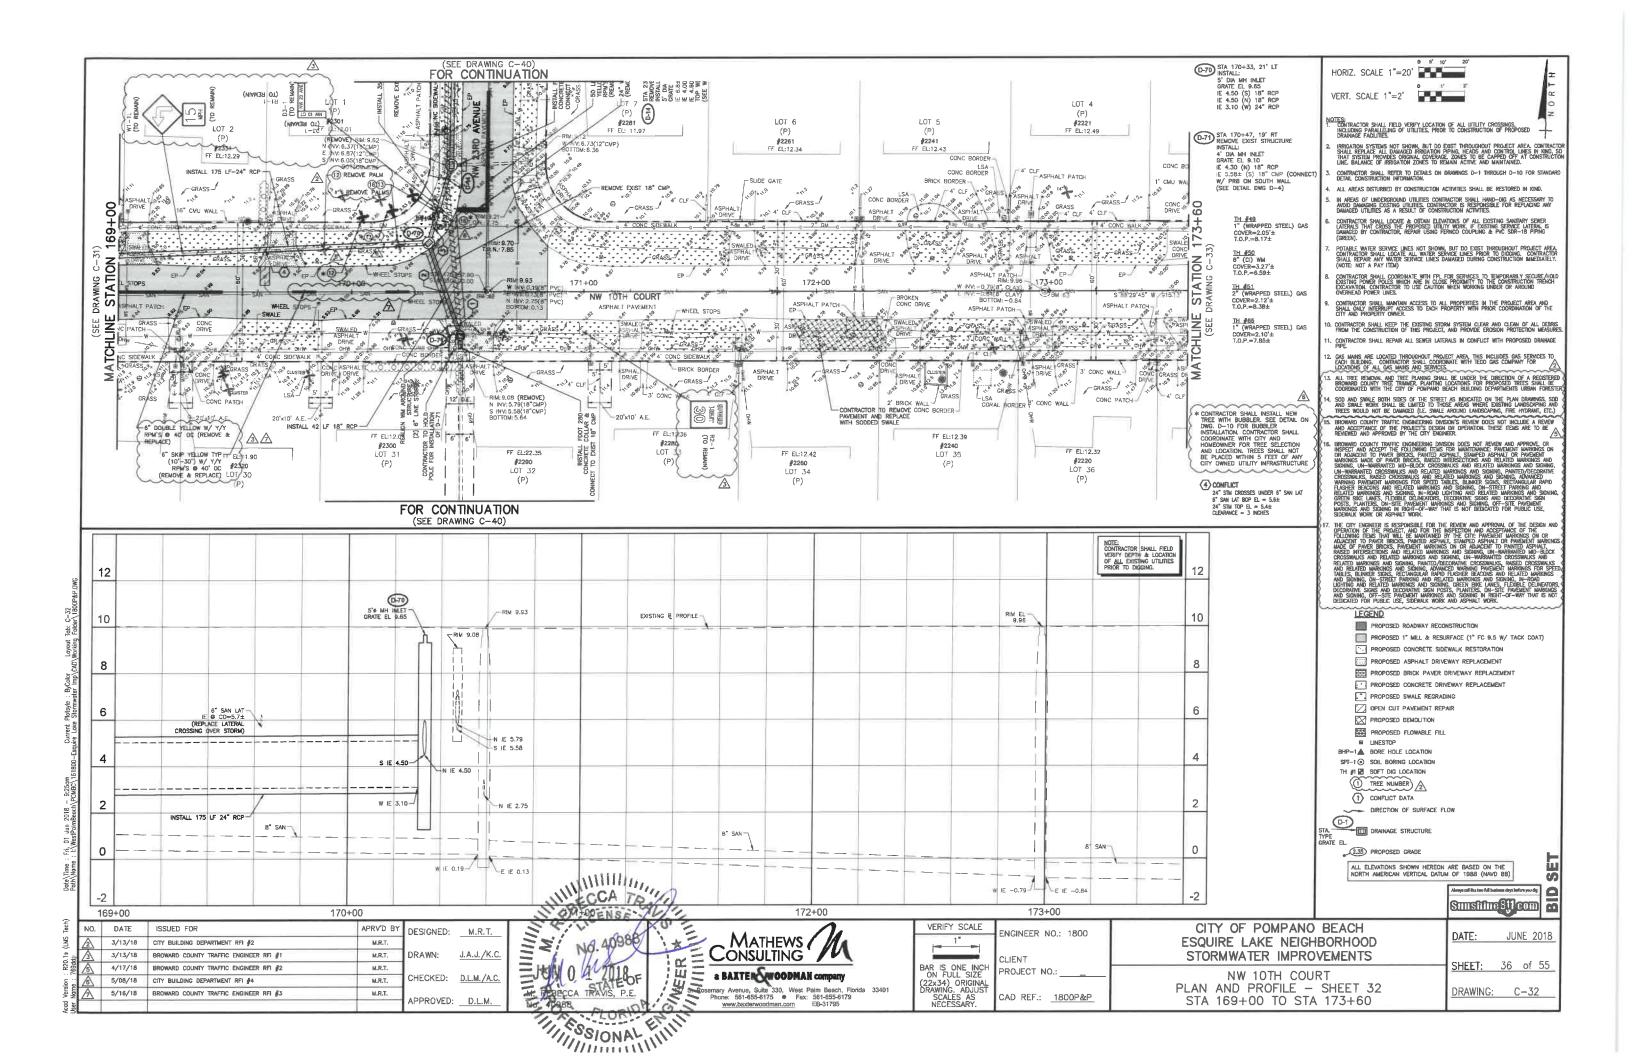


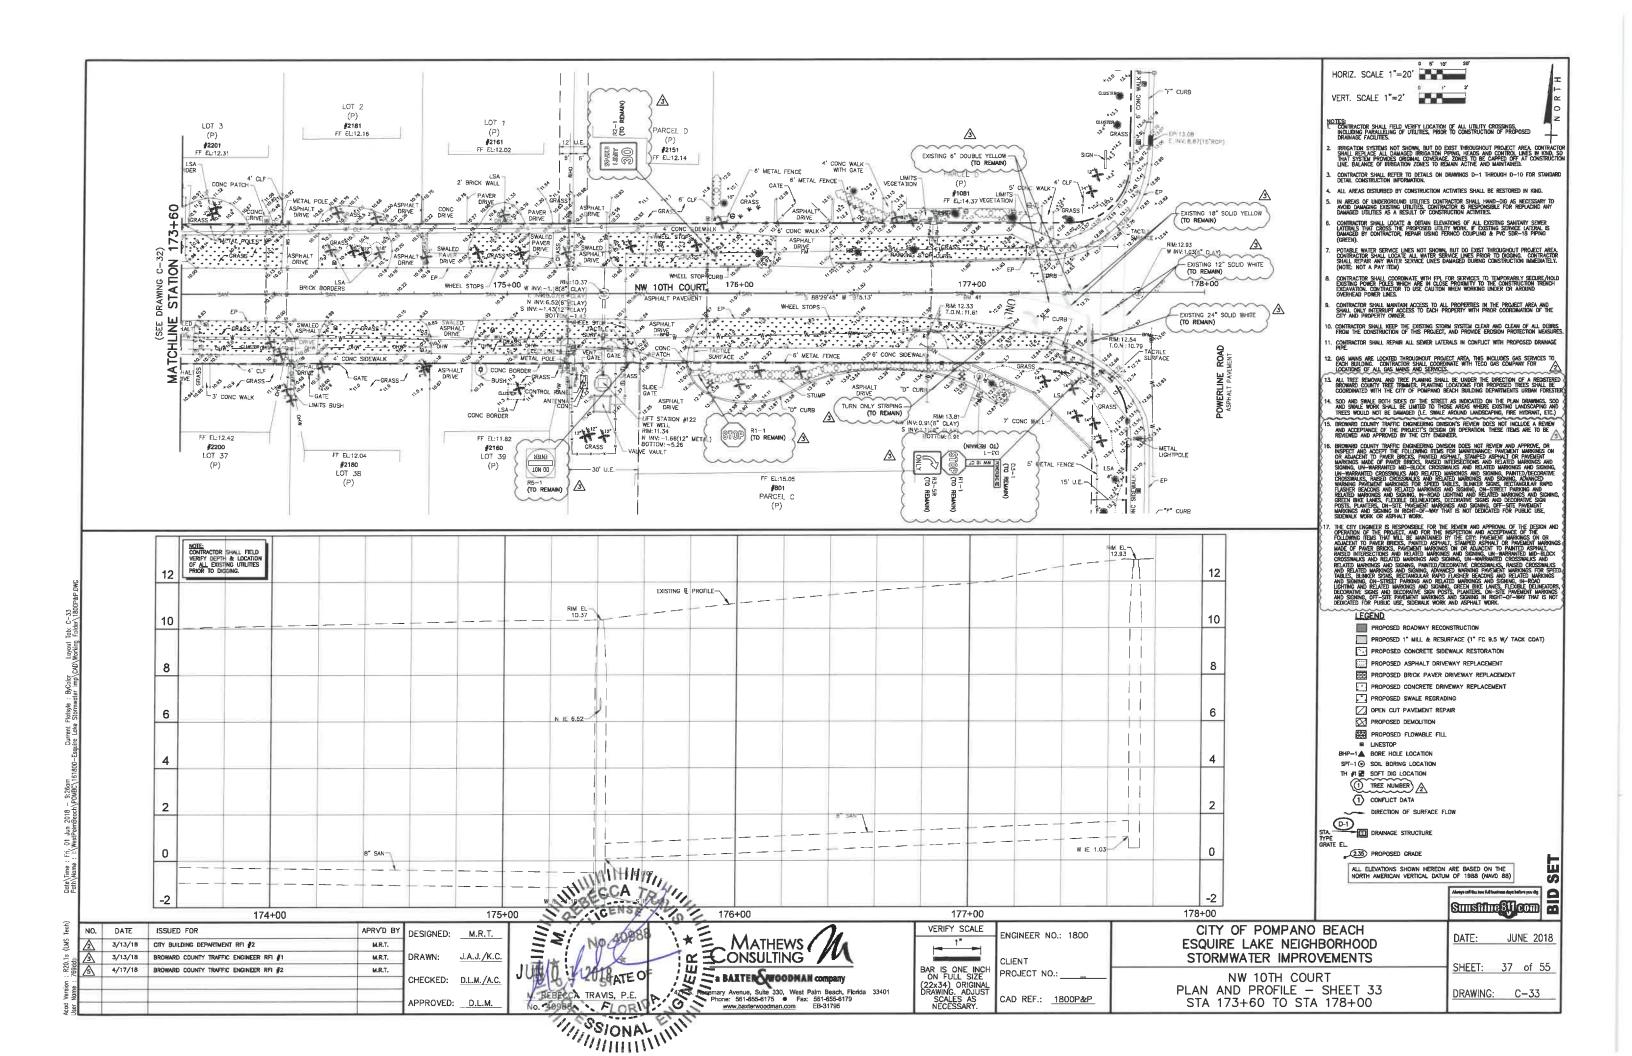


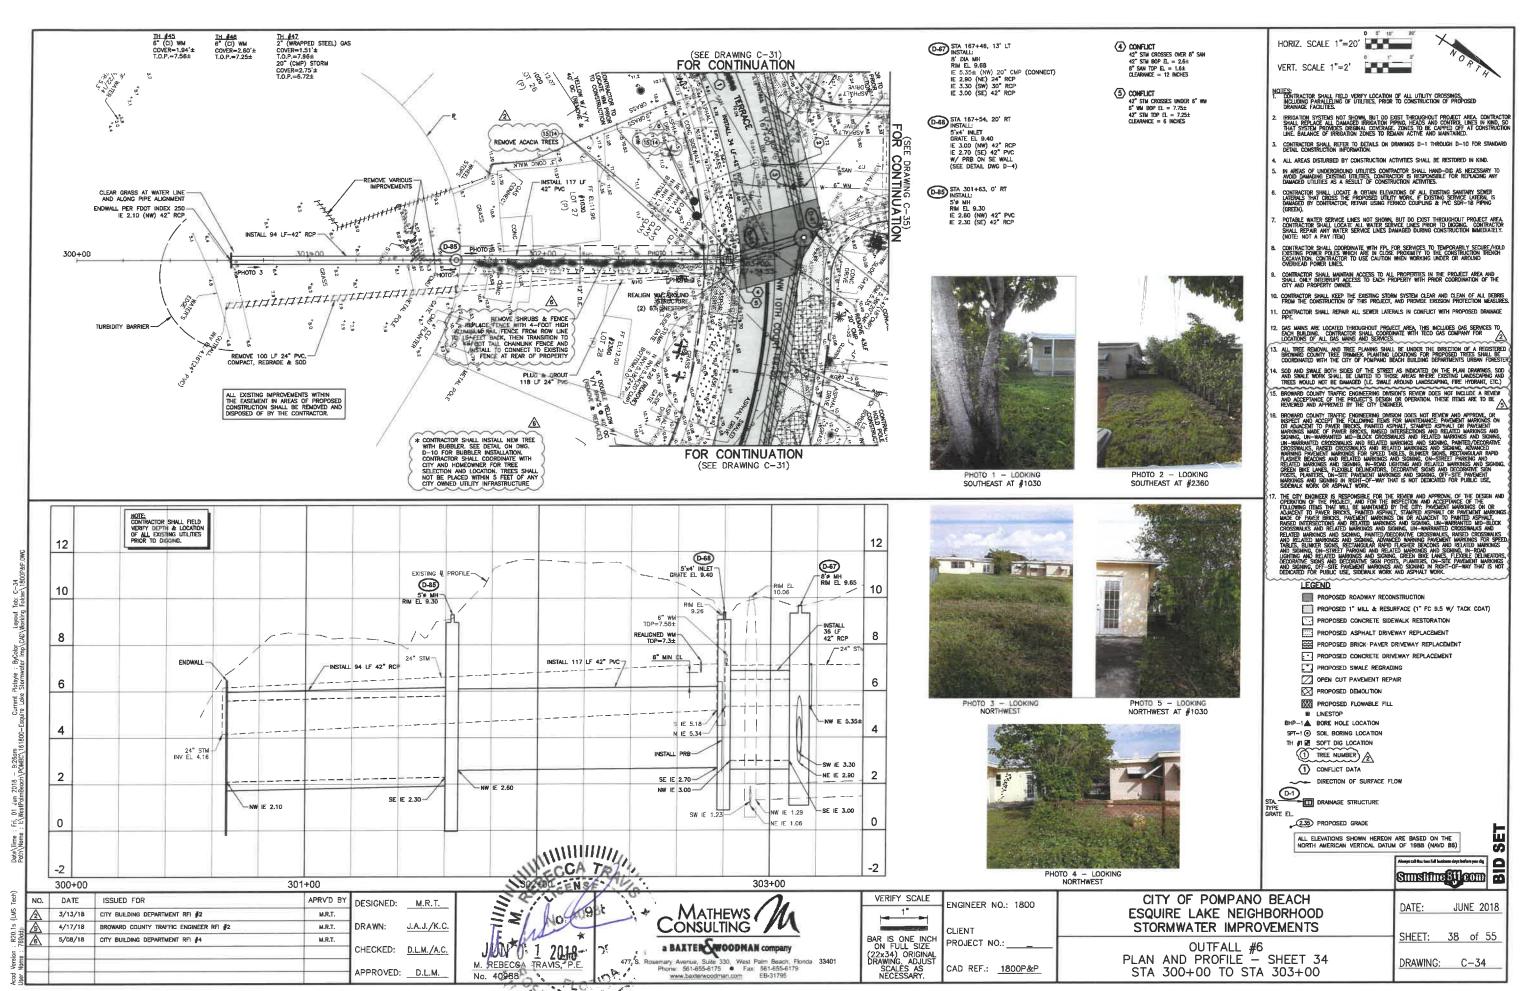



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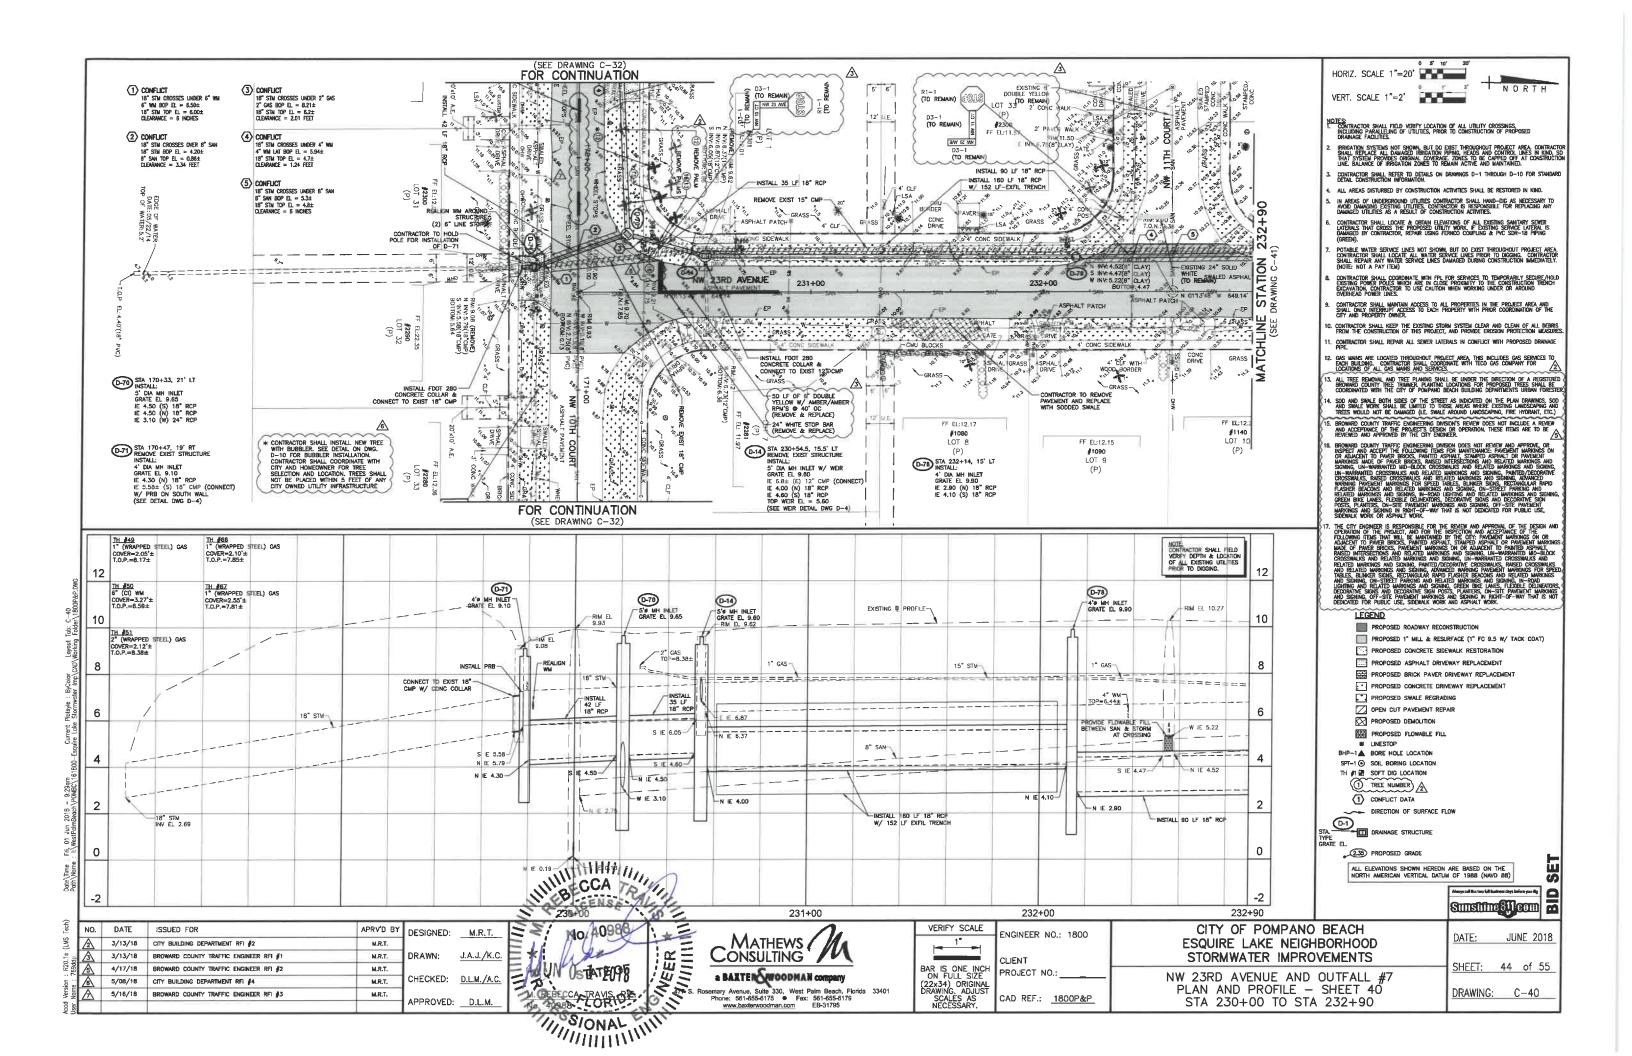


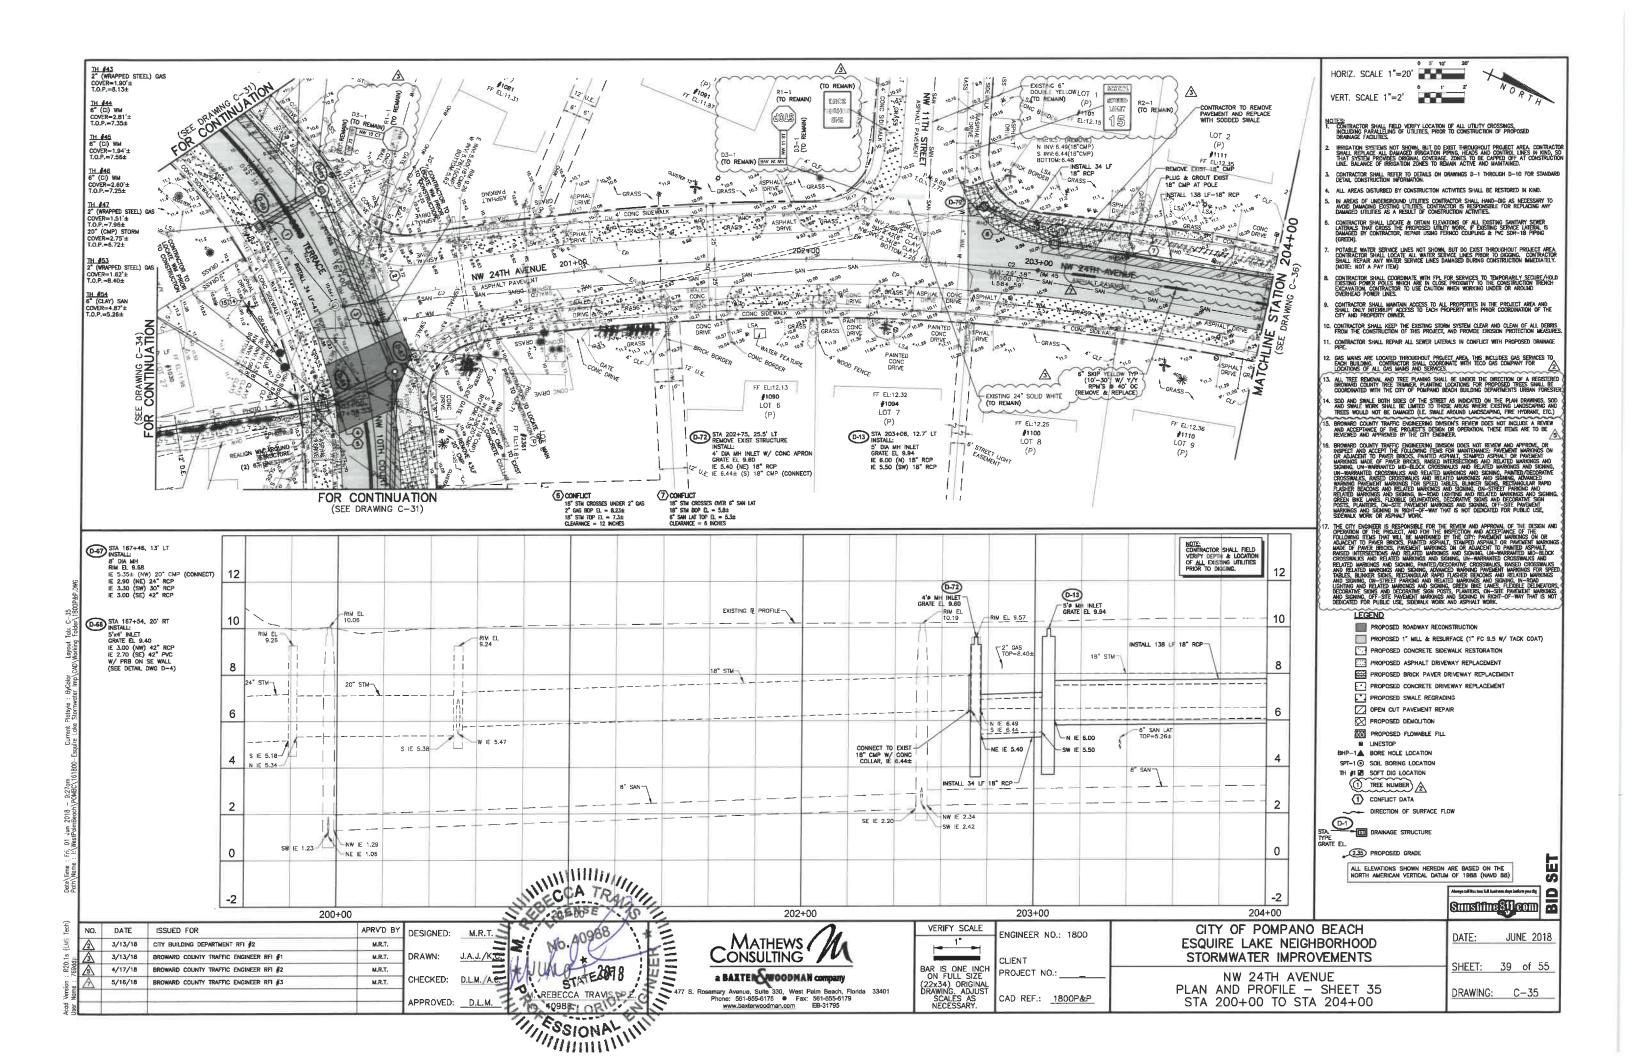


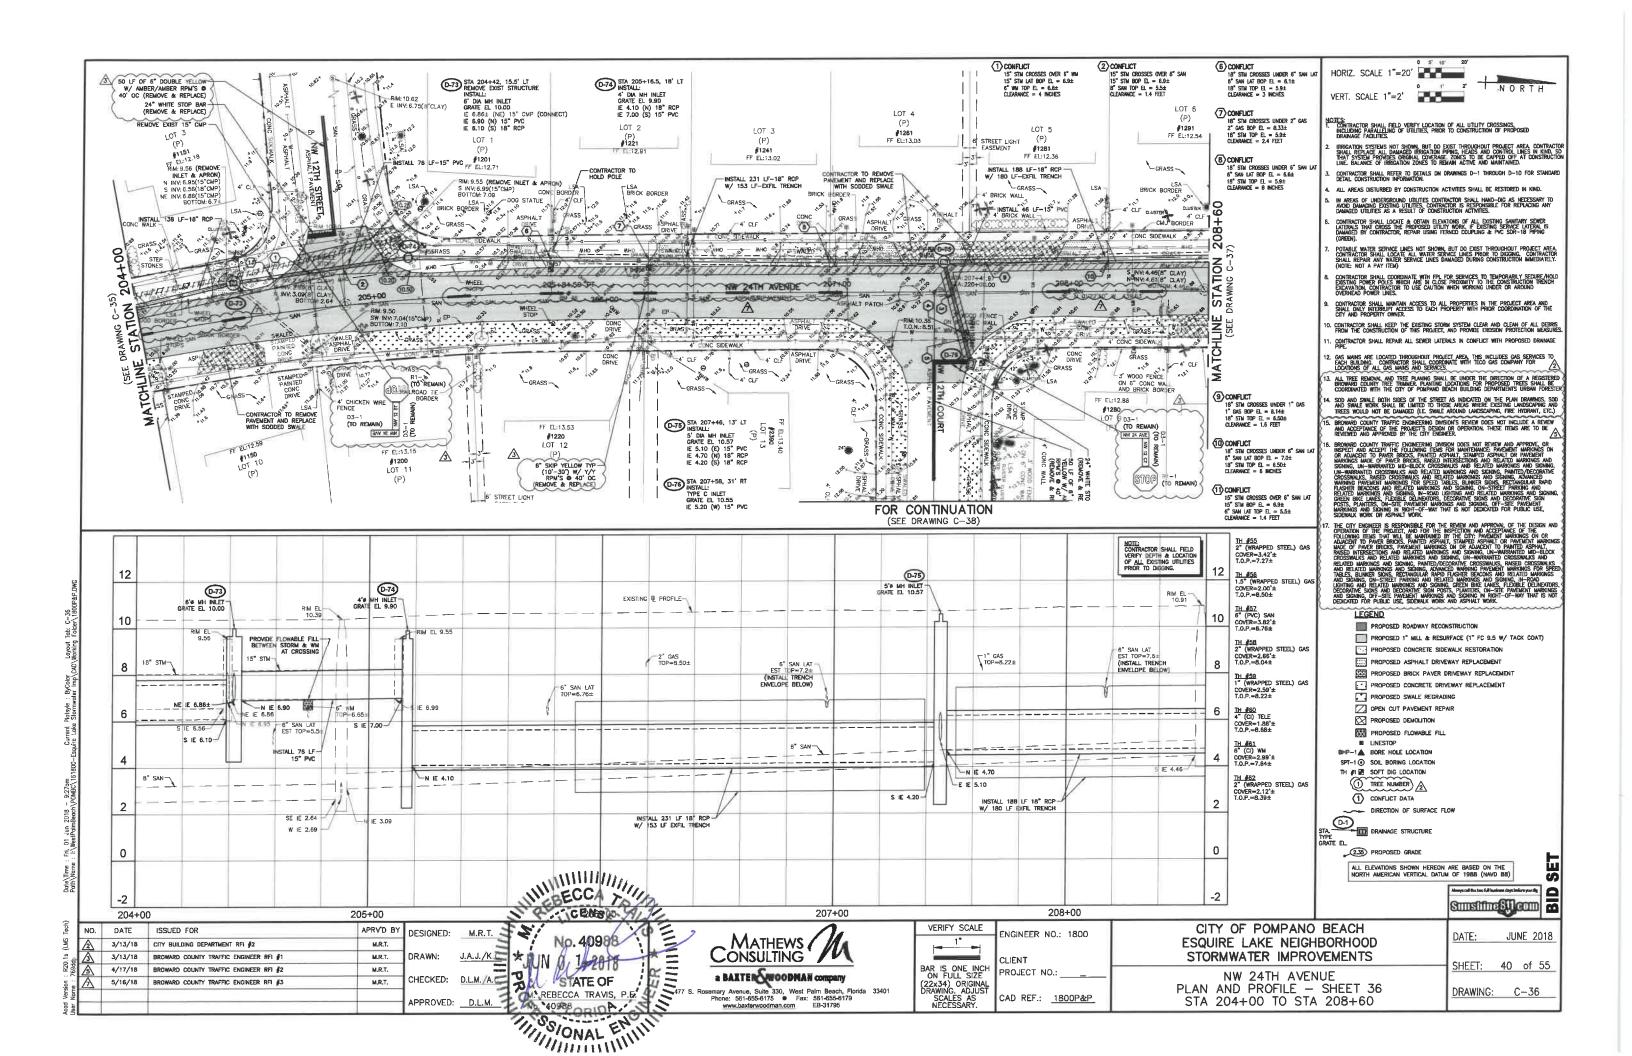


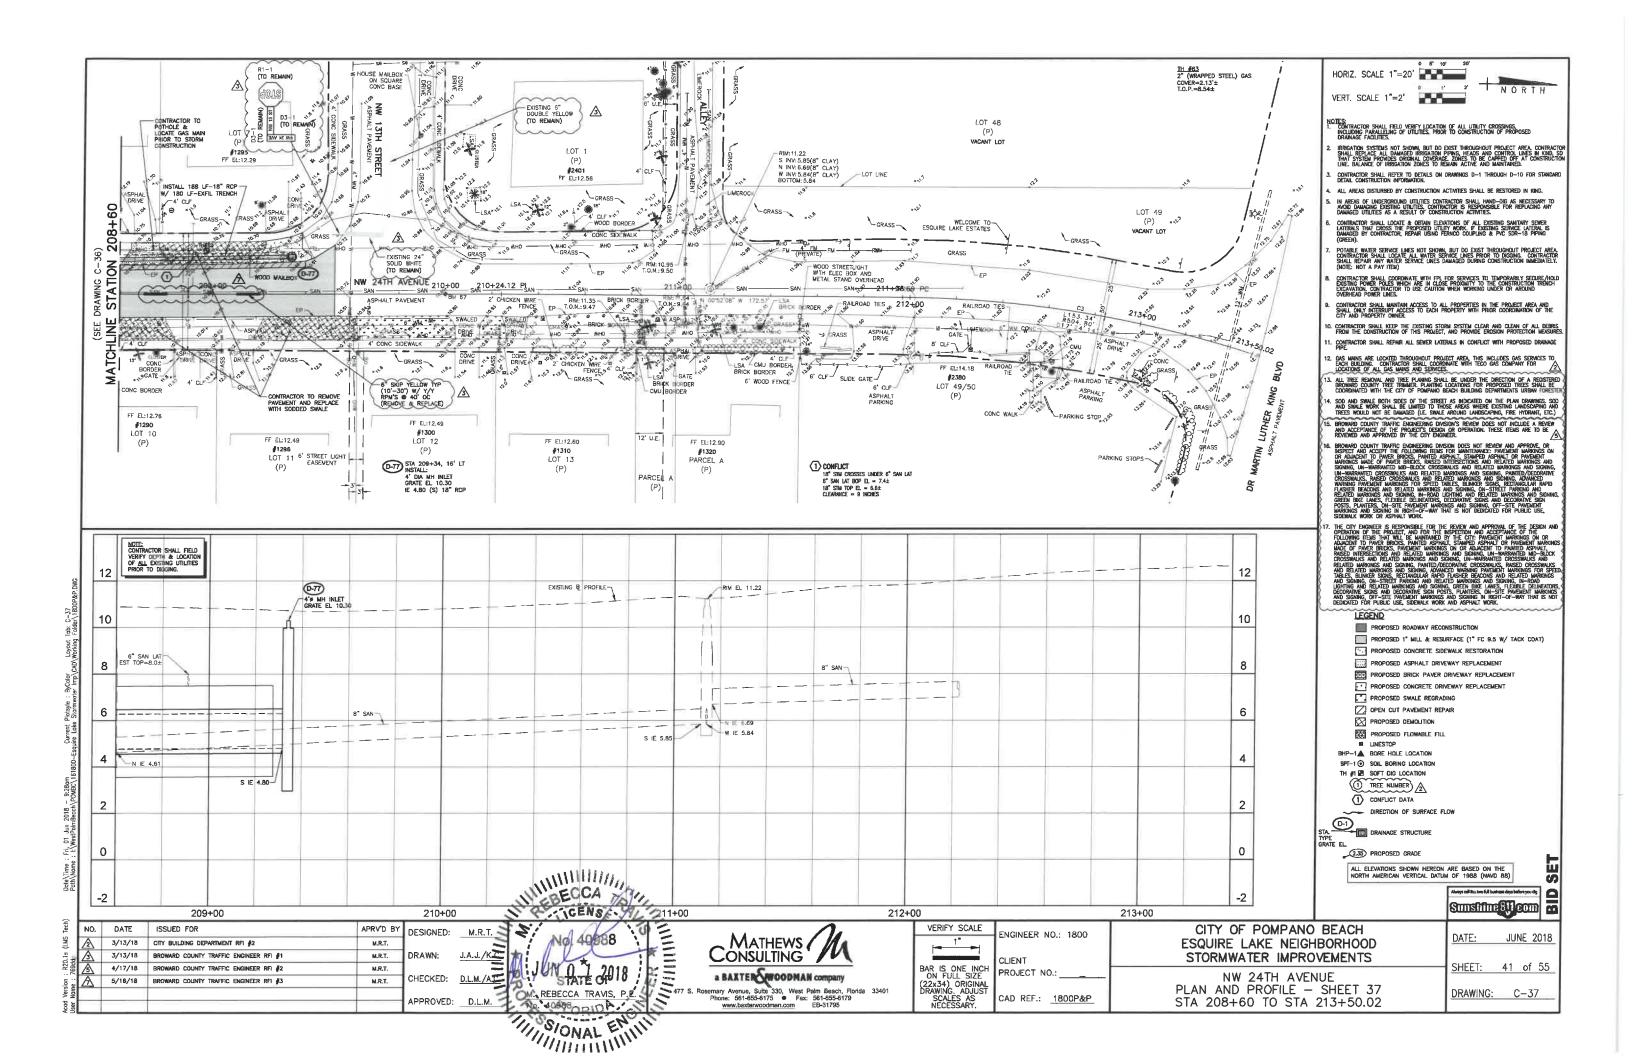


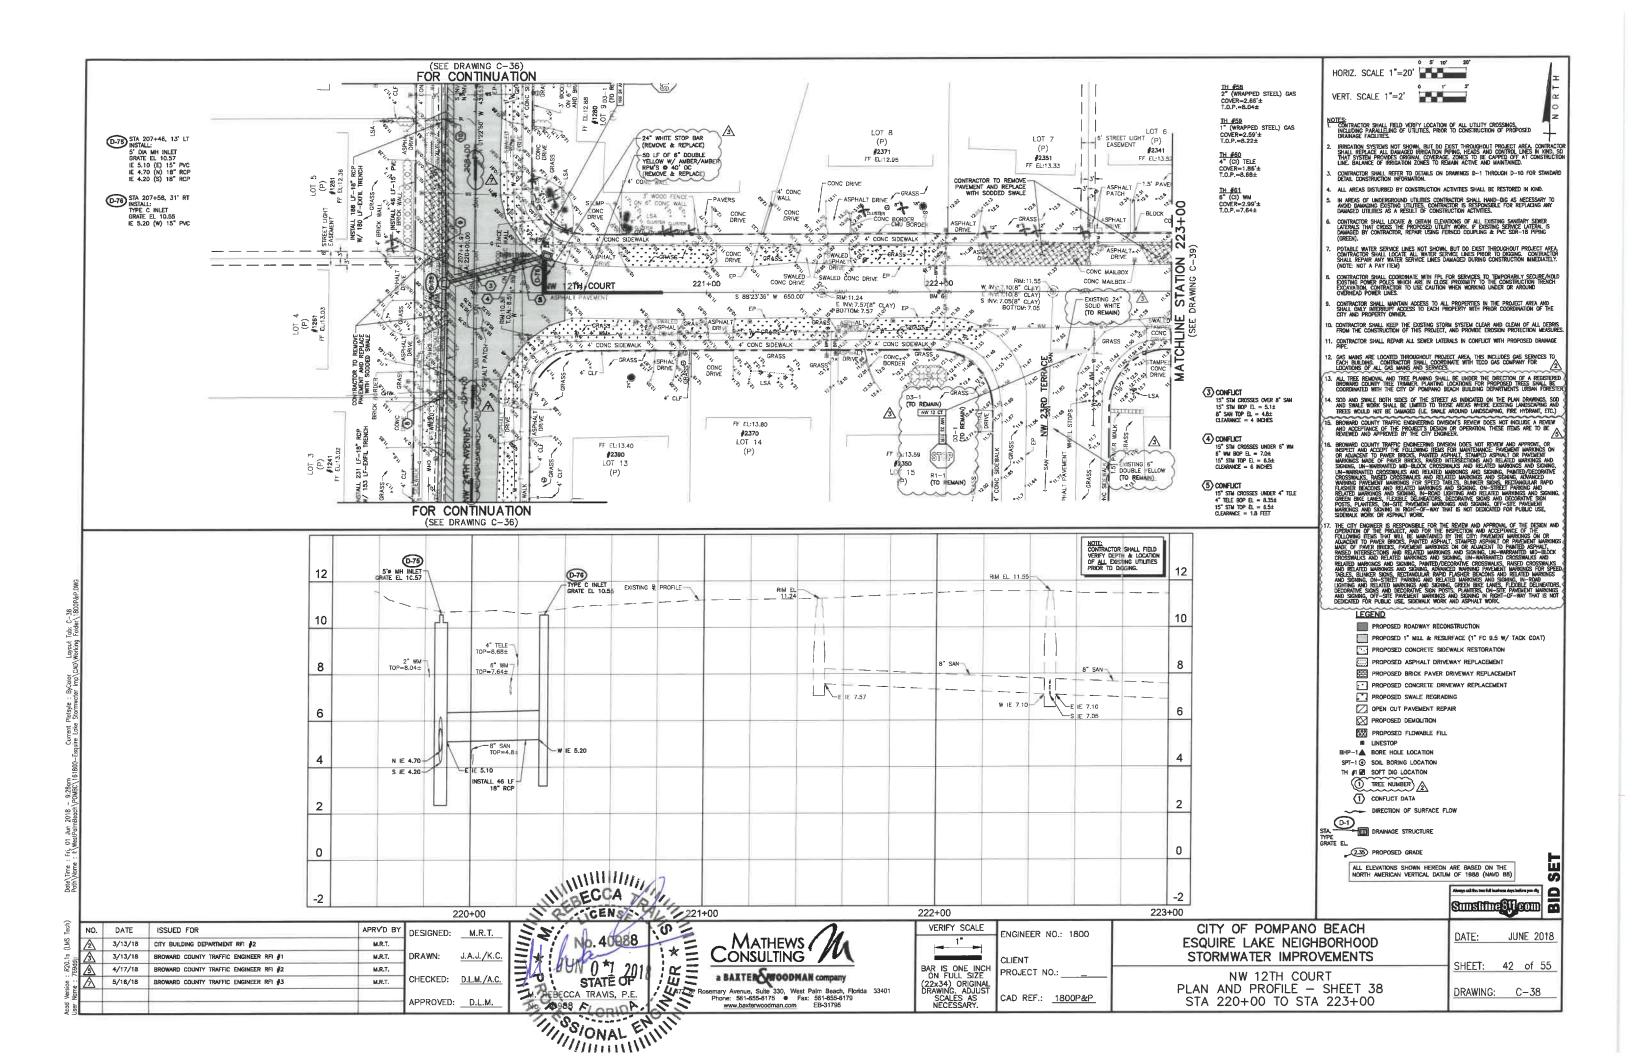


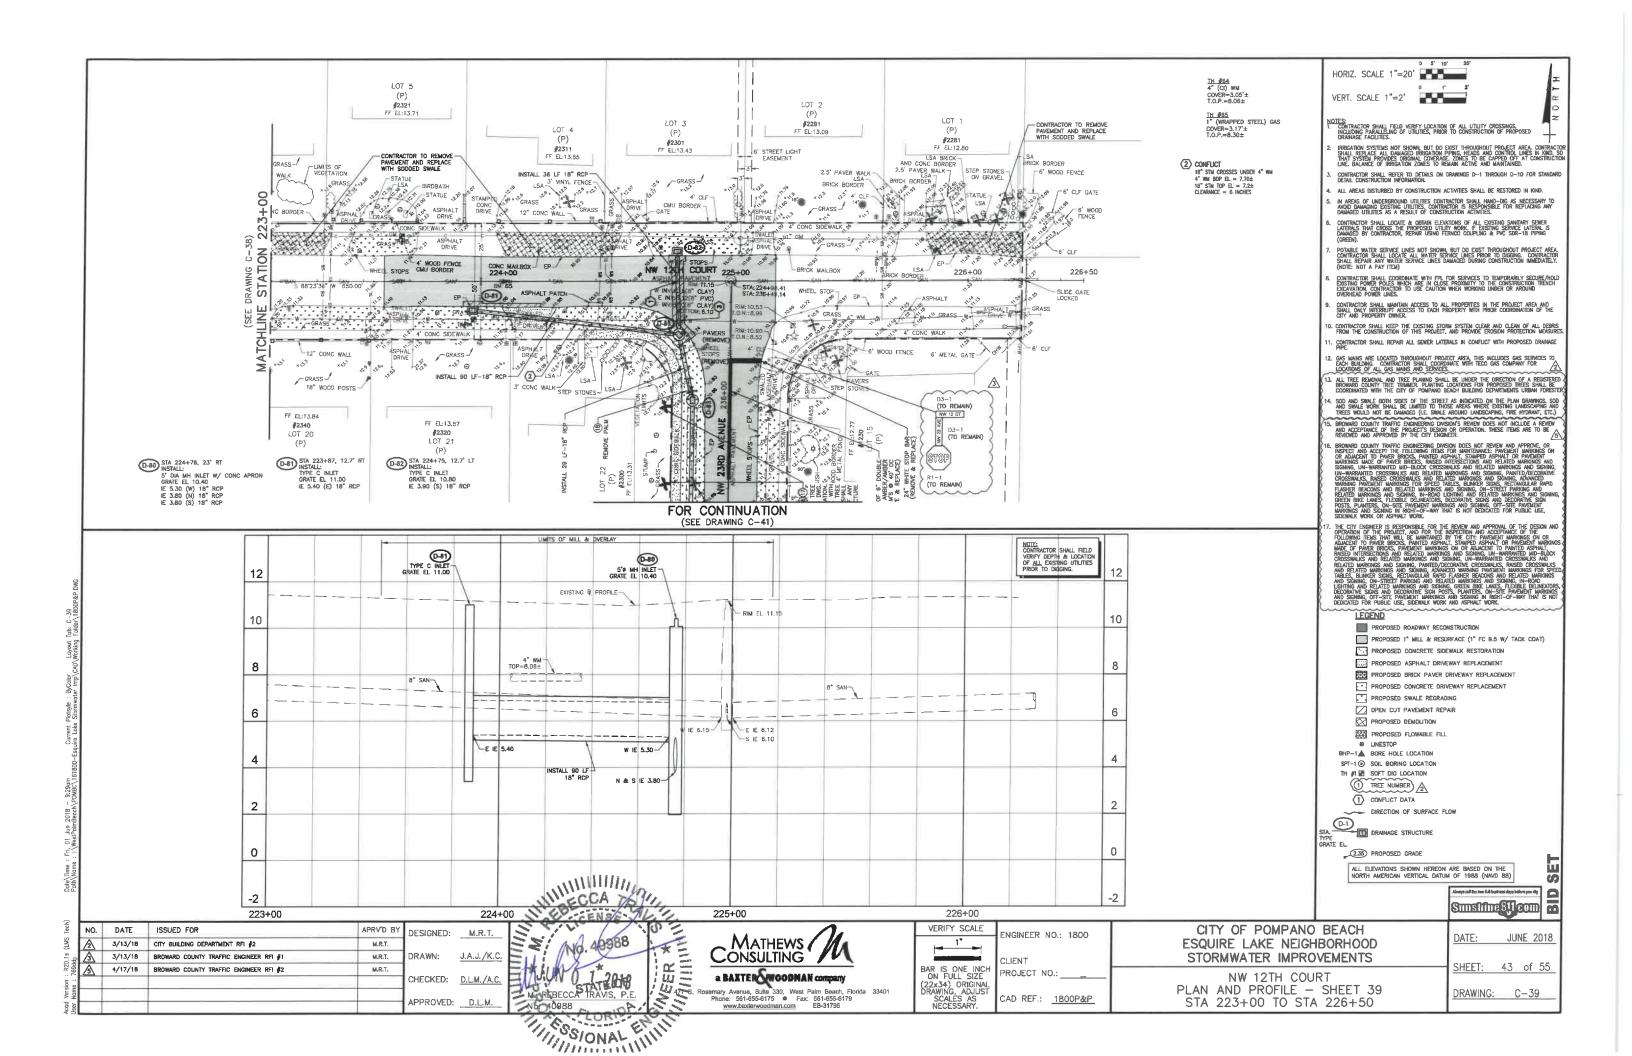


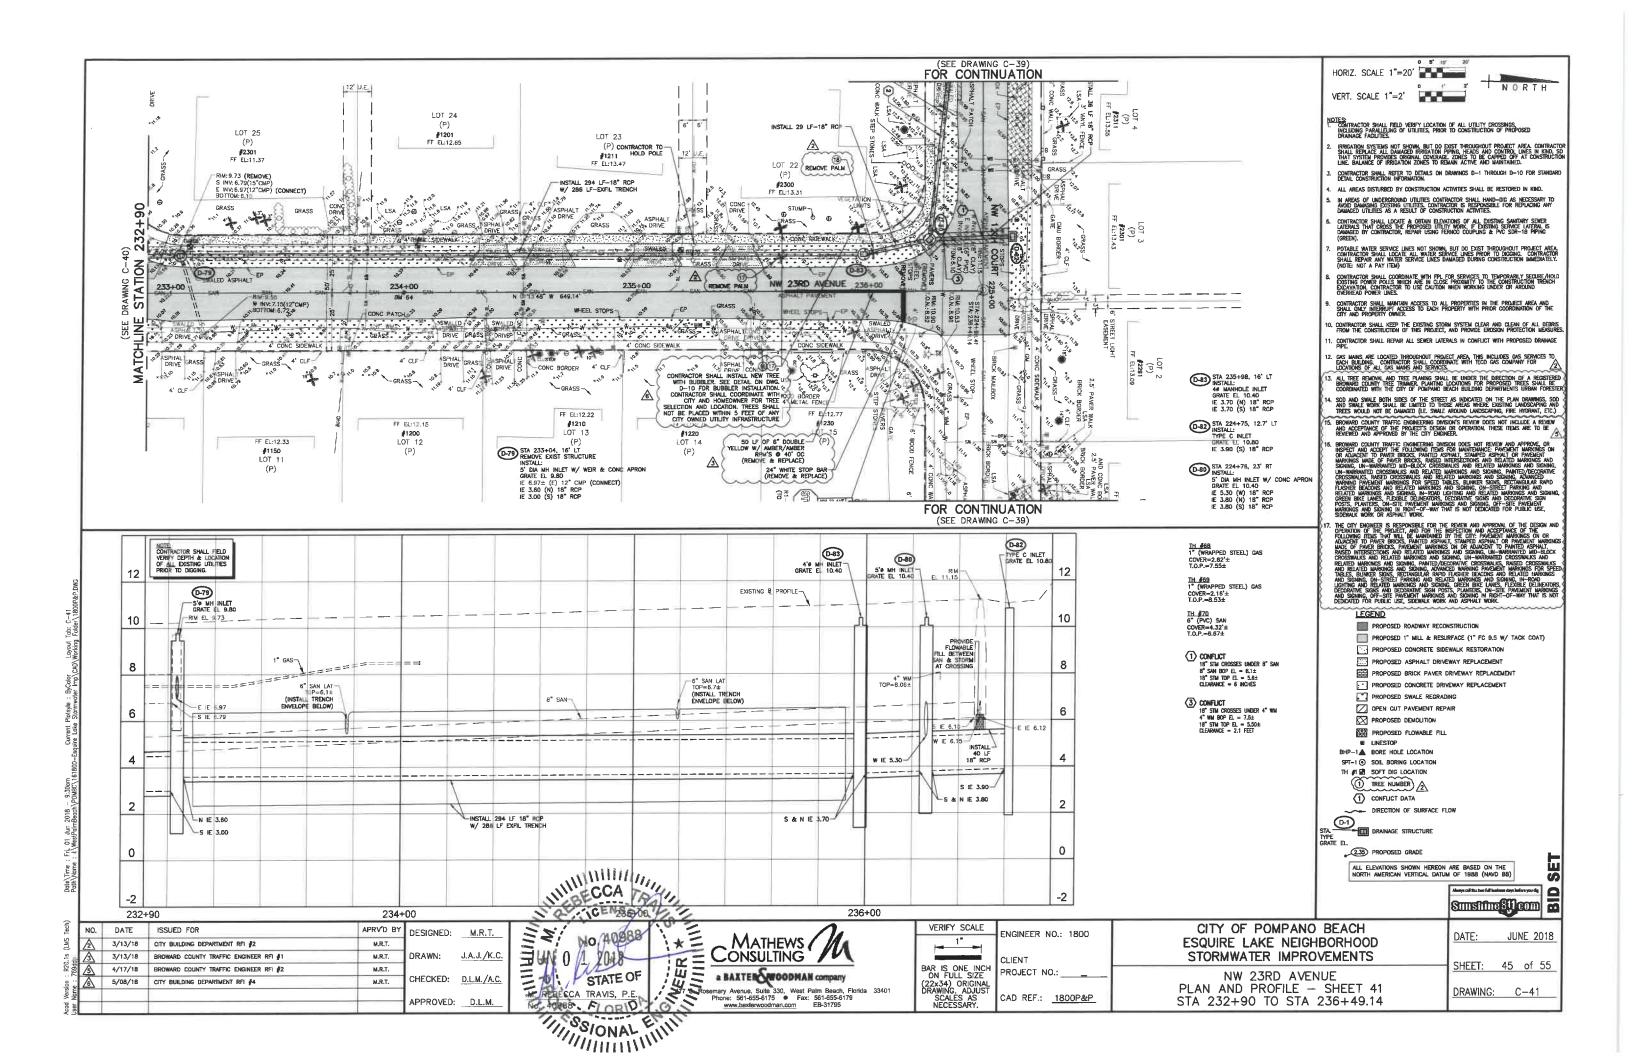


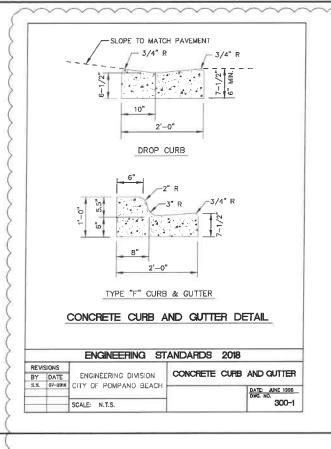


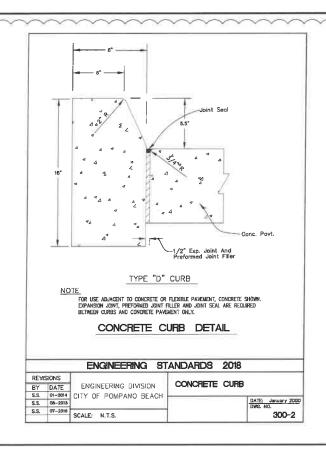


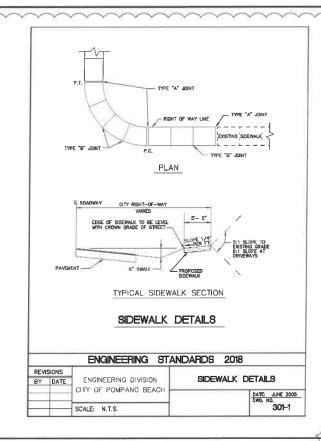


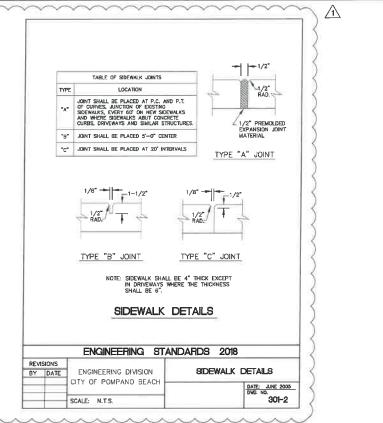


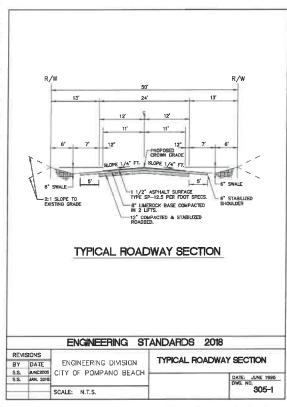


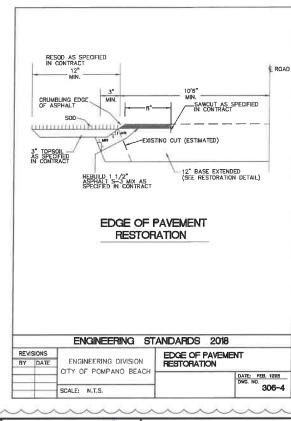

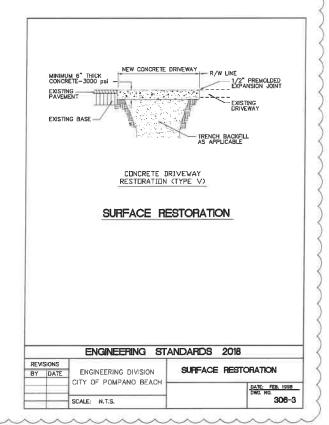


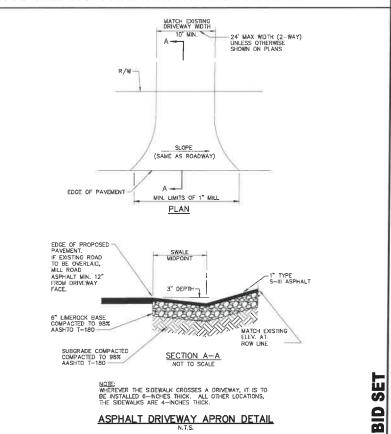

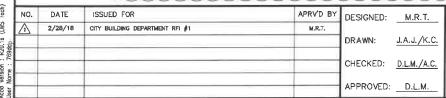

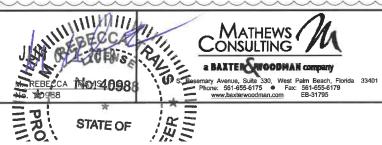

STATE OF

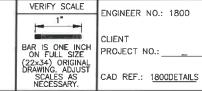

INEER NO.: 1800	CITY OF POMPANO BEACH ESQUIRE LAKE NEIGHBORHOOD STORMWATER IMPROVEMENTS
JECT NO.:	
DEE . 4000DETAILO	STANDARD DETAILS - SHEET 1 OF 10

DATE: JUNE 2018 SHEET: 46 of 55 DRAWING:

OTHER NOTES

All paved surfaces shall be properly marked prior to the hours of darkness.

RAISED PAVEMENT MARKERS

Pavement marking within private parking lots may be painted according to F.D.O.T. specifications, except for all stop bors adjacent to public rifgt—of—way.

R.P.M.s shall be installed on all lane lines and centerlines, spaced at 20° or 40'.

R.P.M.s shall be a 4 x 4 type class "B" marker meeting F.D.C.T. specifications and shall be approved by the City Engineer prior to use.

THE FOLLOWING ITEMS ARE NOT REVIEWED OR ACCEPTED BY BROWARD COUNTY:

. Broward County Traffic Engineering Division's review does not include a review and acceptance of the project's design or operation. These items are to be reviewed and approved by the City Engineer.


approved by the City Engineer.


Broward County Traffic Engineering Division does not review and approve, or inspect and accept the following items for maintenance: povement markings on an adjacent to pover maintenance: povement markings on a dipleant to pover markings made of pover bricks, raised intersections and related marking and signing, un-warranted mid-black crosswalks and related markings and signing, advanced crosswalks and related markings and signing, and adjacent pointed faccorative crosswalks, raised crosswalks and related markings and signing, advanced Warning povement markings for Speed folloses, Blinker Signs, Rectangular Repid Flasher Beacons and related markings and signing, on-street porking our related markings and signing on-street parking our related markings and signing are bike lones, flexible delineators, cecorative signs and decorative sign posts, planters, an-afte povement markings and signing, off-site povement markings and signing, off-site povement markings and signing in right-of-way that is not dedicated for public use, sidewalk work or asphalt work.


work or asphalt work.

The City Engineer is responsible for the review and approval of the design and operation of the project, and for the inspection and acceptance of the following items or adjacent to the things of the project asphalt is transported asphalt are powernent markings made of power bricks, powernent markings and signing, an woronate mid-block crosswelks and related markings and signing, un-worranted independent of the project of the project and signing, un-worranted crosswelks and related markings and signing, un-worranted crosswelks and related markings and signing, pointed/descrative crosswelks, raised crosswelks and related markings and signing, pointed/descrative raiseswelks, raised crosswelks and related markings and signing, in-markings for Speed Tobles, Blinker Signs, Rectangular Republic Flosher Beacons and related markings and signing, in-road lighting and related markings and signing, green bike lanes, flexible delineators, decorative signs and decorative sign posts, planters, an-site powernet markings and signing, off-site powernet markings and signing in right-of- way that is not dedicated for public use, sidewalk work and asphalt work.


PAVEMENT MARKING SPECIFICATIONS

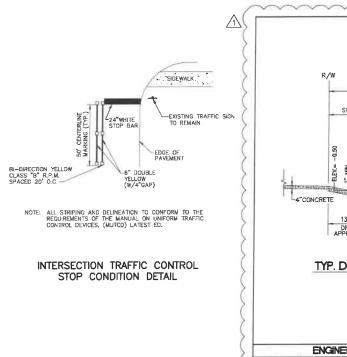


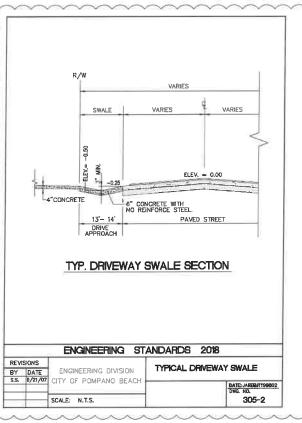

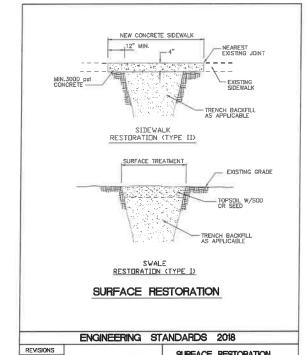

		ENGINEERING ST	ANDARDS	2018
REV	SIONS		OI IDEACE	RESTORATION
ΒY	DATE	ENGINEERING DIVISION	GOTH ACL	RESTORATION
5.5.	5/05/10	CITY OF POMPANO BEACH		DATE: FEB. 1998
				DWG. NO.
_	-	SCALE: N.T.S.		DWG. NO. 306-1

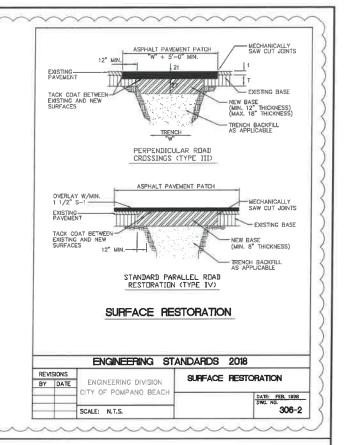


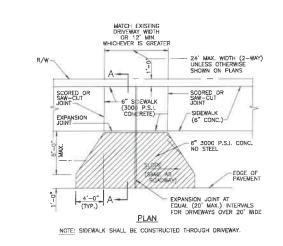

ELEVATION AT SIDEWALK OR EDGE OF EXIST. S/W WHERE APPLICABLE COMPACTED SUBGRADE T-99

CONCRETE THINK MAN LAPRON

No. 49988

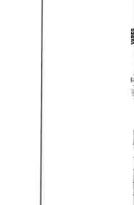


.8. .C. # 4@ 12" C.C.E.W. 6.4.0 # 5@ 12" C.C.E.W. 7'-4" Ø 5-0" 8" 8" # 5@12"C.C.E.W. 6-07 Ø 8° 8° # 5@ 12° C.C.E.W.
7-07 Ø 8° 8° # 5@ 12° C.C.E.W. # 5@ 8" C.C.E.W. 8-4° Ø # 5@ F C.C.E.W. 9'-4" Ø 8-0'8 10' 10' 2-W.W.M. w' 4 # # 5@ B'C.C.E.W.

O.D. AND SHALL BE CAST AT TIME OF FABRICATION

PRECAST CIRCULAR DRAINAGE MANHOLE DETAIL

SECTION A-A

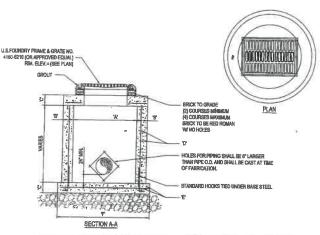

"B" "C" 4°-0° Ø #4@12*C.C.E.W. 6-4-6 6" 8" #5 @ 12" C.C.E.W. 7-40 6.0.0 8. 8. #5@ FC.C.E.W. 8-40 7-0"9 8" 8" # 6 @ 12" C.C.E.W. #5@6" C.C.E.W. 9'4" Ø 10" 10" 2-W.W.M. w/ 84 #5@6"C.C.E.W.

PRECAST CIRCULAR INLET DETAIL

VERIFY SCALE CITY OF POMPANO BEACH ENGINEER NO.: 1800 ESQUIRE LAKE NEIGHBORHOOD STORMWATER IMPROVEMENTS

STANDARD DETAILS - SHEET 2 OF 10

JUNE 2018 47 of 55 DRAWING:

NO. DATE ISSUED FOR APRV'D BY DESIGNED: 2/28/18 CITY BUILDING DEPARTMENT RFI #1 M.R.T. 3/13/18 BROWARD COUNTY TRAFFIC ENGINEERING RFI #1 M.R.T.

Mathews / CONSULTING /

BAR IS ONE INCH ON FULL SIZE

CLIENT PROJECT NO .: (22x34) ORIGINAL DRAWING. ADJUST SCALES AS NECESSARY. CAD REF.: 1800DETAILS

UUN 1 2018 L a BAXTER WOODMAN company


seemary Avenue, Suite 330, West Palm Beach, Florida 33401


Phone: 561-855-8175 • Fax: 561-855-6179


www.baxterwoodman.com EB-31795 SIONAL MINIMULA SIONAL MINIMULA


CHECKED: D.L.M. APPROVED: D.L.M. APPROVE DRAWN:


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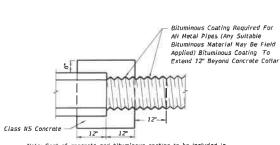


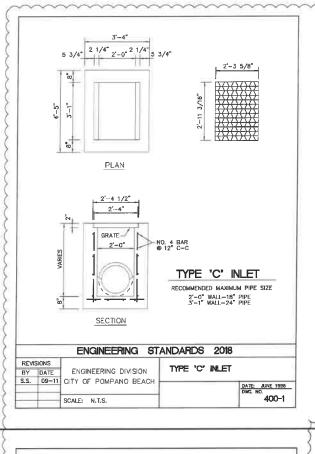OPTIONAL

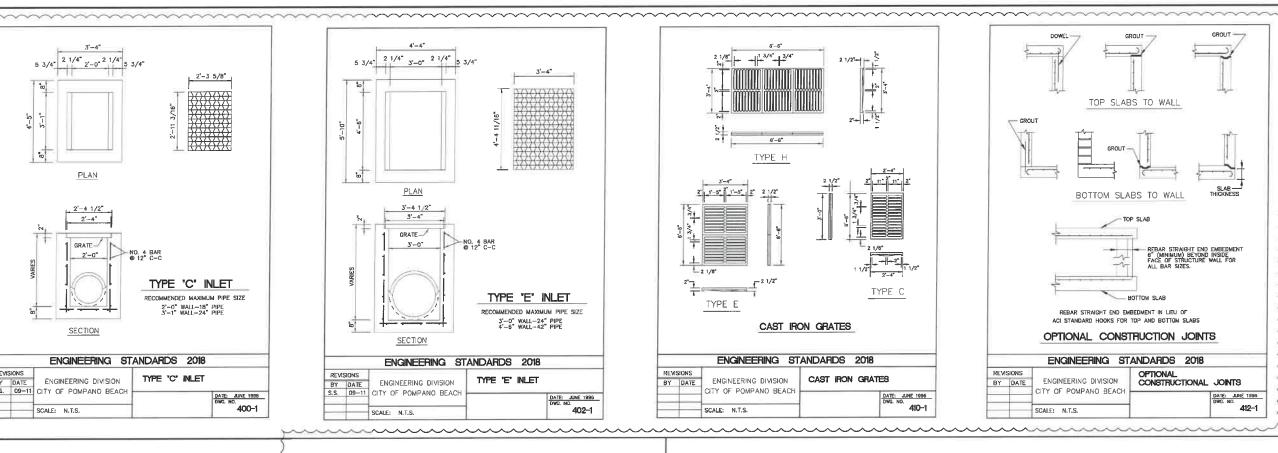CONSTRUCTION JOINT

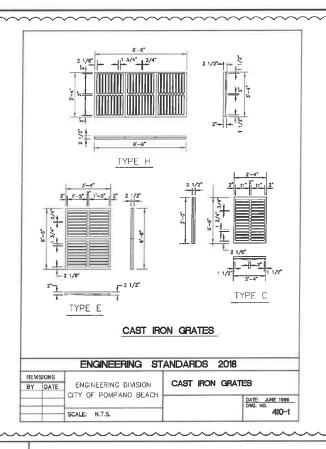DATE: JUNE 1996 DWG, NO.

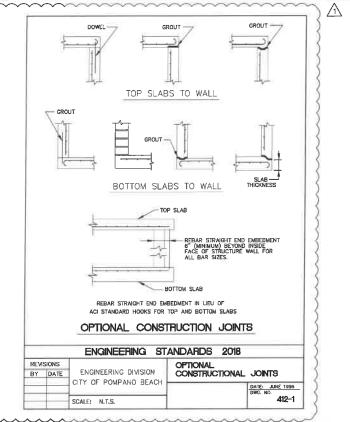412-2

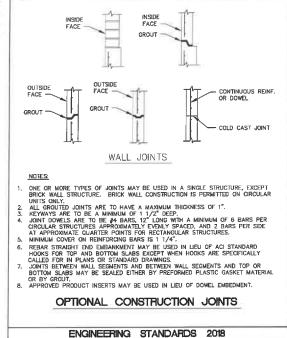

Note: Cost of concrete and bituminous coating to be included in contract unit price for either new pipe or Mitered End Section.


Alternate connection must be approved by the State Drainage Engineer

a) metal pipe of dissimilar materials b) flexible pipe when the minimum cover required in accordance with Index No. 205 cannot be obtained

DISSIMILAR TYPES

CONCRETE JACKET FOR CONNECTING DISSIMILAR TYPES OF PIPE AND CONCRETE PIPES WITH DISSIMILAR JOINTS

FDOT INDEX 280 COLLAR

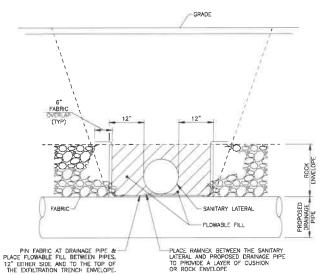

NOTES:

1. DETAIL APPLIES AT LOCATIONS WHERE PROPOSED DRAINAGE PIPE PASSES UNDER OR OVER SANITARY LATERALS. PLACE FLOWABLE FILL BETWEEN DRAINAGE AND SANITARY PIPES, 12" EITHER SIDE.

TRENCH DETAIL AT EXFILTRATION TRENCH AND SANITARY LATERAL CROSSING N.T.S.

APRV'D BY NO. DATE ISSUED FOR DESIGNED: M.R.T. 2/28/18 M.R.T. CITY BUILDING DEPARTMENT RFI #1 DRAWN: CHECKED: D.L.M./A.C. APPROVED: D.L.M.

ENGINEERING DIVISION

CITY OF POMPANO BEACH

SCALE: N.T.S.

REVISIONS

BY DATE



MATHEWS & CONSULTING ' a BAXTER COODMAN company
semary Avenue, Suite 330, West Palm Beach, Florida 33401
Phone: 561-655-6175 • Fax: 561-655-6179
www.baxterwoodman.com EB-31795

VERIFY SCALE
1"
BAR IS ONE INCH
ON FULL SIZE (22x34) ORIGINAL DRAWING. ADJUST
SCALES AS NECESSARY

ENGINEER NO.: 1800 CLIENT PROJECT NO .:


CAD REF .: 1800DETAILS

CITY OF POMPANO BEACH ESQUIRE LAKE NEIGHBORHOOD STORMWATER IMPROVEMENTS STANDARD DETAILS - SHEET 3 OF 10

JUNE 2018 SHEET: 48 of 55 DRAWING:

SE

BID

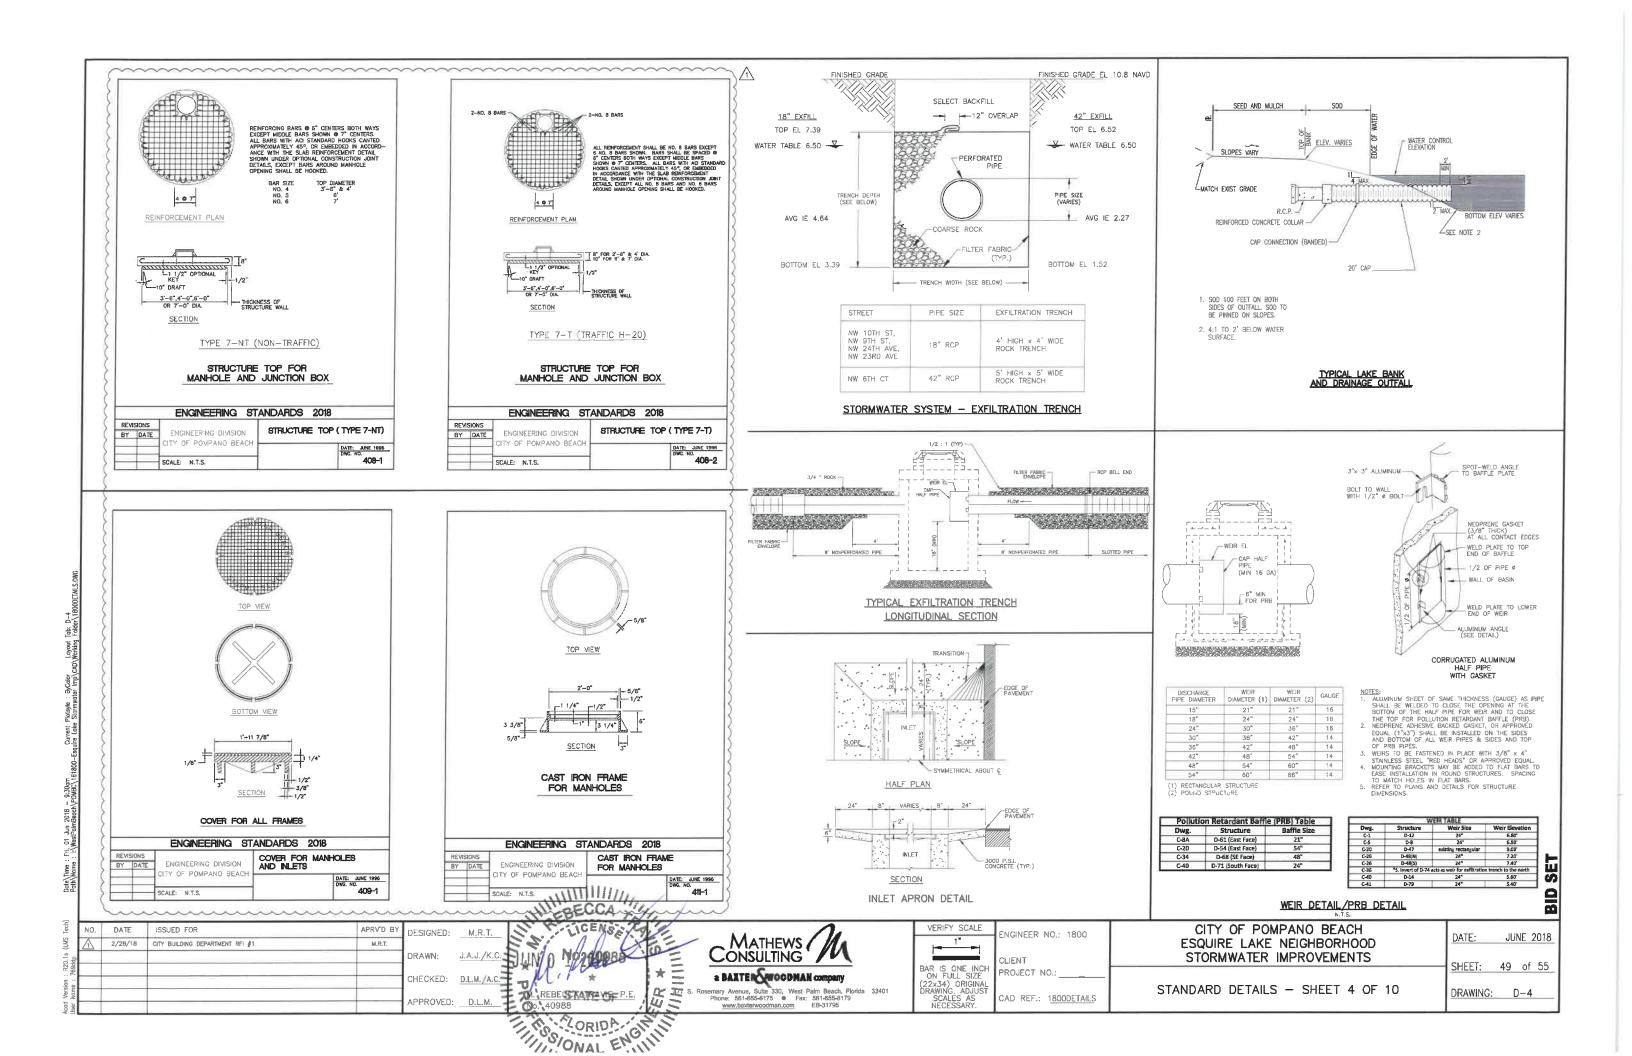

FRONT VIEW

TOP VIEW

SKEWED PIPE

ENDWALL DIMENSIONS (EXCLUSIVE OF MULTIPLE PIPE SPACING)

- Location Reference Line (See Location Control Above)

5 Center To Center Pipe Spacing

PIPE AND SPACING FOR MULTIPLE PIPE

ENDWALL POSITIONS FOR SINGLE AND MULTIPLE

X Centerline To Centerline Dimension At Face Of Headwall


LEGEND

FRONT VIEW

TOP VIEW

NORMAL PIPE

STANDARD

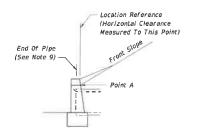

END VIEW

- 1. Position is set by the intersection of the front slope and Point A where this intersection falls outside the clear zone.
- 2. Where the front slope and Point A intersects inside the clear zone, the endwall is positioned so the location reference point is at the clear zone limit. The front slope is transitioned to the endwall as shown in Index No. 280.

LOCATION CONTROL

GENERAL NOTES

- Endwall dimensions, locations and positions are for round and elliptical concrete pipe and for round and pipe-arch
- Index No. 280.
- Reinforcing steel shall be Grades 40 or 60. Additional reinforcement necessary for handling precast units shall be determined by the Contractor or the supplier. Cost of
- 4. All exposed corners and edges of concrete are to be chamfered ¾".
- 5. Concrete shall be Class 1, except ASTM C478 (4000 psi) concrete may be substituted for precast items manufactured in plants meeting the requirements of Section 449 of the Specifications.
- 6. On outfall ditches with side slopes flatter than 1:1½ provide 20' transitions from the endwall to the flatter side slopes.
- pipe shall be made on the following basis Endwall Skew to Pipe Use Tabulated Value

0° to 5° 31° or over

- 9. Pipe length plan quantities shall be based on the pipe end locations shown in the standard location control end view, or lengths based on special endwall locations called for in the
- 10. Payment for pipe in pipe culverts shall be based on plan quantities, adjusted for endwall locations subsequently

- corrugated metal pipe. Round concrete pipe shown.
- 2. Front slope and ditch transitions shall be in accordance with
- 3. Endwalls may be cast in place or precast concrete. reinforcement shall be included in the contract unit price for Concrete, (Endwalls).

- 8. Payment for concrete quantities for endwalls skewed to the

- established by the Engineer.
- Endwalls to be paid for under the contract unit price for Class I Concrete (Endwalls), CY.

DATA AND ESTIMATED QUANTITIES FOR ONE ENDWALL

																											Clas	5 I C	oncret	e (CY)												
- [Openi	ng Are SF)	а					,	Dimensi							Number And Type Of Pipe And Skew Angle Of Pipe																									
>		(-	31/							nmensi	0/15					Si	ngle				Do	uble							Tri	pie							Quac	druple] 1
- 1	N	lumber	Of Pi	pes					-	_	-		х			Сопс	Metal		Con	crete			Ме	tal			Conc	rete			Metal			Concrete					Metal			1
- 1	1	2	3	4	A	В	· ·	E	r	G	3	O°	15°	30°	45°	0°	o°	O°	15°	30°	45°	O°	15°	30°	45°	0°	15°	30°	45°	0°	15°	30°	45°	O°	75°	30°	45°	O°	15°	30°	45°	1
5"	1.23	2.46	3.69	4.92	1'-11"	7'-2"	4'-0"	1'-10"	1'-2"	0'-6"	2'-7"	2'-7"	2'-8"	3'-0"	3'-8"	1.23	1.24	1.59	1.60	1.65	1.74	1.62	1.63	1.68	1.78	1.94	1.96	2.05	2.23	1.99	2.02	2.11	2.30	2.30	2.34	2.47	2.74	2.37	2.41	2.75	2.84	1.
8"	1.77	3.54	5.31	7.08	2'-2"	1'-3"	4'-6"	1'-11"	1'-3"	1'-0"	2'-10"	2-10"	2'-11"	3'-3"	4'-0"	1.56	1.59	1.99	2.01	2.06	2.17	2.04	2.06	2.11	2.23	2.43	2.46	2.56	2.79	2.51	2.54	2.65	2.89	2.86	2.91	3.06	3.40	2.96	3.01	3.17	3.53	1.
1"	2.41	4.82	7.23	9.64	2'-5"	1'-4"	5'-0"	2'-0"	1'-4"	1'-6"	3'-2"	3'-2"	3'-3"			1.97																	- 4									2
4"	3.14	6.28	9.42	12.56	2'-8"	1'-4"	5'-6"	2'-0"	1'-4"	2'-0"	3'-5"	3'-5"	3'-6"	3'-11"	4'-10"	2.24	2.29	2.82	2.84	2.91	3.06	2.91	2.93	3.01	3.17	3.39	3.43	3.57	3.87	3.52	3.56	3.71	4.03	3.97	4.03	4.24	4.69	4.14	4.20	4.43	4.91	2
7"	3.98	7.96	11.94	15.92	2-11"	1'-5"	6'-0"	2'-1"	1'-5"	2'-6"	3'-10"	3'-10"	4'-0"	4'-5"		2.73																										2
יים	4.91	9.82	14.73	19.64	3'-2"	1'-6"	6'-6"	2'-2"	1'-6"	3'-0"	4'-3"	4'-3"	4'-5"	4'-11"	6'-0"	3.26	3.34	4.13	4.16	4.26	4.49	4.28	4.31	4.43	4.67	4.98	5.04	5.25	5.69	5.20	5.27	5.49	5.97	5.84	5.93	5.24	5.91	6.13	6.23	6.56	7.29	13
6"	7.07	14.14	21.21	28.28	3'-8"	1'-8"	7'-6"	2'-4"	1'-8"	4'-0"	5'-1"	5'-1"	5'-3"	5'-10"	7'-2"	4.53	4.64	5.73	5.77	5.92	5.23	5.95	6.00	6.15	6.49	6.92	7.00	7.29	7.91	7.25	7.34	7.65	8.33	8.13	8.26	8.69	9.62	8.57	8.71	9.18	10.20	1 3
2"	9.62	19.24	28.86	38.48	4'-2"	1'-10"	8'-6"	Z'-6"	2"-0"	5'-0"	6'-0"	6'-0"	6'-3"	6'-11"	8'-6"	6.33	6.49	8.11	8.17	8.39	8.85	8.43	8.50	8.73	9.23	9.90	10.02	10.45	11.38	10.38	10.52	10.98	11.99	11.68	11.87	12.51	13.89	12.32	12.52	13.22	14.73	1 4
8"	12.57	25.14	37.71	50.28	4'-8"	2-1"	9'-6"	2"-9"	2'-0"	6'-0"	6'-9"	6'-9"	7'-0"	7'-10"	9'-7"	8.15	8.38	10.40	10.48	10.75	11.33	10.85	10.94	11.23	11.87	12.64	12.80	13.34	14.50	13.34	13.51	14.11	15.39	14.89	15.13	15.93	17.68	15.82	16.08	16.97	18.90	1 4
4"	15.90	31.80	47,70	63.60	5'-2"	2'-6"	10'-6"	3'-2"	2'-3"	7'-0"	7'-8"	7'-8"	7'-11"	8'-10"	10'-10"	11.71	11.77	15.23	15.35	15.78	16.69	15.35	15.48	15.90	16.83	18.77	19.02	19.86	21.69	18.93	19.18	20.04	21.89	22.29	22.66	23.93	26.67	22.51	22.89	24.17	26.96	1 5

FDOT INDEX 250

TRAVIS, P.E.

ON ORIDA

S

STRAIGHT CONCRETE ENDWALLS
SINGLE AND MULTIPLE PIPE ISSUED FOR APRV'D BY DESIGNED: DRAWN: CHECKED: APPROVED: D.L.M.

MATHEWS A CONSULTING ' a BAXTER WOODMAN company

VERIFY SCALE BAR IS ONE INCH ON FULL SIZE (22x34) ORIGINAL DRAWING, ADJUST

ENGINEER NO.: 1800 CLIENT PROJECT NO .:

CAD REF.: 1800DETAILS

CITY OF POMPANO BEACH ESQUIRE LAKE NEIGHBORHOOD STORMWATER IMPROVEMENTS

SCALE: N.T.S.

BY DATE

STANDARD DETAILS - SHEET 5 OF 10

BID

S

JUNE 2018 SHEET: 50 of 55

120-1

5/16" CHAIN AND COLD SHUTS.
WHEN CHAINING TWO GRATES
TOGETHER PROVIDE ADEQUATE
LOOP FOR EASY HANDLING.

1/2 Ø x 1" DIAMETER J-TYPE OR THREADED STRAIGHT EYE BOLT

COLD SHUT

EYE BOLT AND CHAIN

WALLEY -

DATE: JUNE 1996 DWG, NO. 413-1

GRATE -

COLD SHUT

NOTE: WHEN ALTERNATE "G" GRATE IS SPECIFIED, THE CHAIN, BOLT, MUTS, WASHER AND COLD SHUTS SHALL BE GALVANIZED IN ACCORDANCE WITH THE SPECIFICATIONS FOR THE GRATE.

COST OF EYE BOLT AND CHAIN TO BE INCLUDED IN THE CONTRACT UNIT PRICE FOR INLETS.

EYE BOLT AND CHAIN FOR LOCKING GRATES

ENGINEERING STANDARDS 2018

1. ALL NONMETALLIC PIPE SHALL BE INSTALLED WITH 12 THHN SOLID COPPER TRACING WIRE.

UTILITY PIPE AND MARKER BALLS LOCATION

ENGINEERING STANDARDS 2018

2. THE MARKER BALLS MUST BE INSTALLED DIRECTLY ABOVE THE PIPE.

3. MARKER BALLS SHALL BE INSTALLED AT 40' O.C. 4. BALL COLOR CODING: POTABLE WATER SYSTEM: BLUE PER 62-555.320(21)(b)(3) F.A.C.

ENGINEERING DIVISION

CITY OF POMPANO BEACH

ENGINEERING DIVISION

CITY OF POMPANO BEAC

SCALE: N.T.S.

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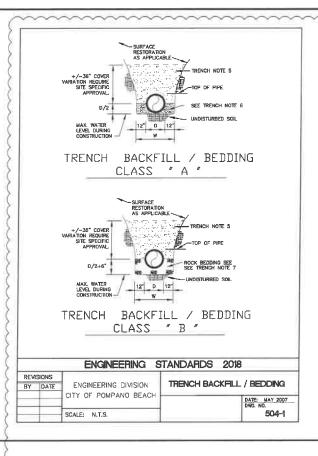
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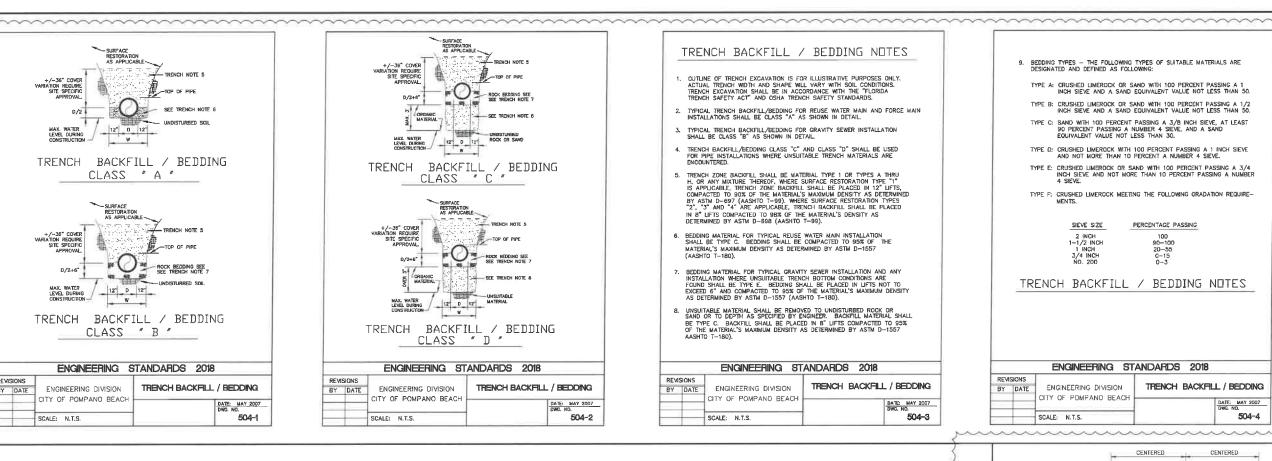
BY DATE

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GENERAL NOTES:

DRAWING: D-5






TRENCH BACKFILL / BEDDING NOTES

- CUILINE OF TRENCH EXCAVATION IS FOR ILLUSTRATIVE PURPOSES ONLY ACTUAL TRENCH WIDTH AND SHAPE WILL VARY WITH SOIL CONDITIONS. TRENCH EXCAVATION SHALL BE IN ACCORDANCE WITH THE "FLORIDA TRENCH SAFETY ACT" AND OSHA TRENCH SAFETY STANDARDS.
- TYPICAL TRENCH BACKFILL/BEDDING FOR REUSE WATER MAIN AND FORCE MAIN INSTALLATIONS SHALL BE CLASS "A" AS SHOWN IN DETAIL.
- TRENCH BACKFILL/BEDDING CLASS "C" AND CLASS "D" SHALL BE USED FOR PIPE INSTALLATIONS WHERE UNSUITABLE TRENCH MATERIALS ARE ENCOUNTERED.
- TRENCH ZONE BACKFILL SHALL BE MATERIAL TYPE 1 OR TYPES A THRU H, OR ANY MIKTURE THEREOF, WHERE SURFACE RESTORATION TYPE "1" IS APPLICABLE, TRENCH ZONE BACKFILL SHALL BE PLACED IN 12" LIFTS, COMPACTED TO 90% OF THE MATERIAL'S MAXIMUM DENSITY AS DETERMINED BY ASTM D-697 (AASHTO T-99). WHERE SURFACE RESTORATION TYPES "2", "3" AND "4" ARE APPLICABLE, TRENCH BACKFILL SHALL BE PLACED IN 8" LIFTS COMPACTED TO 98% OF THE MATERIAL'S DENSITY AS DETERMINED BY ASTM D-898 (AASHTO T-99).
- 6. BEDDING MATERIAL FOR TYPICAL REUSE WATER MAIN INSTALLATION SHALL BE TYPE C. BEDDING SHALL BE COMPACTED TO 95% OF THE MATERIAL'S MAXIMUM DENSITY AS DETERMINED BY ASTM D-1557
- BEDDING MATERIAL FOR TYPICAL GRAVITY SEWER INSTALLATION AND ANY INSTALLATION WHERE UNSUITABLE TRENCH BOTTOM CONDITIONS ARE FOUND SHALL BE TYPE E. BEDDING SHALL BE THACED IN LIFTS NOT TO EXCEED 6" AND COMPACTED TO 95% OF THE MATERIAL'S MAXIMUM DENSITY AS DETERMINED BY ASTM D-1557 (ANSHTO T-180).
- 8. UNSUITABLE MATERIAL SHALL BE REMOVED TO UNDISTURBED ROCK OR SAND OR TO DEPTH AS SPECIFIED BY ENGINEER. BACKFILL MATERIAL SHALL BE TYPE C. BACKFILL MALE BY EN LACED IN 8" LIFTS COMPACTED TO 95% OF THE MATERIAL'S MAXIMUM DENSITY AS DETERMINED BY ASTM D-1557

		ENGINEERING ST	ANDARDS 2018	
REVIS	SIONS		TOTAL DAOVELL	/ DEDDING
BY	DATE	ENGINEERING DIVISION	TRENCH BACKFILL	_ / BEDDING
===		CITY OF POMPANO BEACH		DATE: MAY 2007 DWG, NO.
		SCALE: N.T.S.		504-3

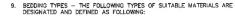

TYPE A: CRUSHED LIMEROCK OR SAND WITH 100 PERCENT PASSING A 1 INCH SIEVE AND A SAND EQUIVALENT VALUE NOT LESS THAN 50.

TYPE B: CRUSHED LIMEROCK OR SAND WITH 100 PERCENT PASSING A 1/2 INCH SIEVE AND A SAND EQUIVALENT VALUE NOT LESS THAN 50.

TYPE C: SAND WITH 100 PERCENT PASSING A 3/8 INCH SIEVE, AT LEAST 90 PERCENT PASSING A NUMBER 4 SIEVE, AND A SAND EQUIVALENT VALUE NOT LESS THAN 30.

TYPE D: CRUSHED LIMEROCK WITH 100 PERCENT PASSING A 1 INCH SIEVE AND NOT MORE THAN 10 PERCENT A NUMBER 4 SIEVE.


TYPE E: CRUSHED LIMEROCK OR SAND WITH 100 PERCENT PASSING A 3/4 INCH SIEVE AND NOT MORE THAN 10 PERCENT PASSING A NUMBER 4 SIEVE.

TYPE F: CRUSHED LIMEROCK MEETING THE FOLLOWING GRADATION REQUIREMENTS.


SIEVE SIZE PERCENTAGE PASSING


TRENCH BACKFILL / BEDDING NOTES


		ENGINEERING ST	ANDARDS 2018
REVI	SIONS		
BY	DATE	ENGINEERING DIVISION	TRENCH BACKFILL / BEDDING
_	-	CITY OF POMPANO BEACH	DATE: MAY 2007
_			DWG. NO.
		SCALE: N.T.S.	504-4

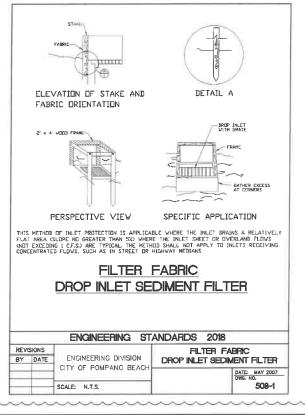

APRV'D BY

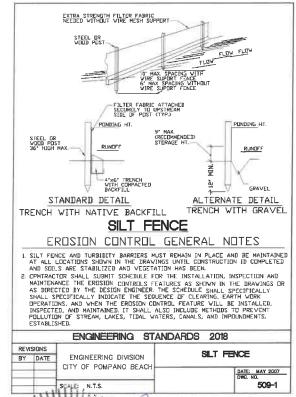


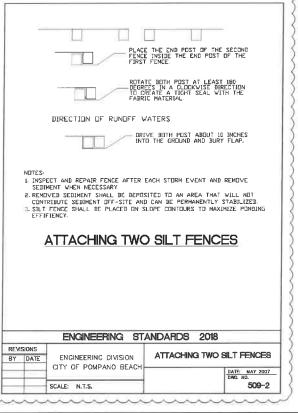

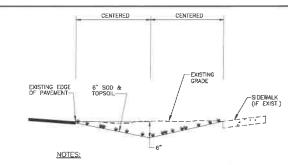

CONTRACTOR TO REPLACE ALL IRRIGATION, TREES & SHRUBBERY IN SWALES DAMAGED DURING CONSTRUCTION UNLESS INDICATED FOR REMOVAL ON THE PLANS.

SWALE REPLACEMENT DETAIL N.T.S.

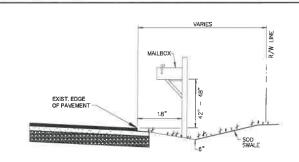

TYPICAL MAIL BOX RELOCATION AND 6" SODDED SWALE DETAIL
N.T.S.

DESIGNED: DRAWN: J.A.J./K. 😘 CHECKED: D.L.M./A. APPROVED: D.L.M.

MATHEWS / CONSULTING /

	VERIFY SCALE	ENGINEER NO.: 1800
Ì	1"	ENGINEER NO. 1800
	BAR IS ONE INCH	CLIENT PROJECT NO.:
	(22x34) ORIGINAL DRAWING. ADJUST SCALES AS NECESSARY.	CAD REF.: 1800DETAILS

ENGINEER NO.: 1800

STANDARD DETAILS - SHEET 6 OF 10

CITY OF POMPANO BEACH

ESQUIRE LAKE NEIGHBORHOOD

STORMWATER IMPROVEMENTS

JUNE 2018 51 of 55

SET

BID

DRAWING:

NO.

DATE


2/28/18


ISSUED FOR

M. REBECCA TRAVIS, P.E. TO ORI S. CORIDA


a BAXTE COODMAN company

5. Rosemary Avenue, Suite 330, West Pelm Beach, Florida 33401
Phone: 561-655-6175 Fax: 561-655-6179
www.baxterwoodman.com EB-31795

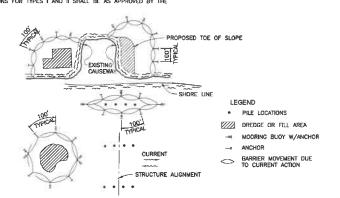

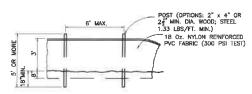

STAKED TURBIDITY BARRIER

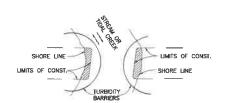

FLOATING TURBIDITY BARRIERS

NOTES:

1. TURBIDITY BARRIERS FOR FLOWING STREAMS AND TIDAL CREEKS MAY BE EITHER FLOATING, OR STAKED TYPES OR ANY COMBINATION OF TYPES THAT WILL SUIT SITE CONDITIONS AND MEET EROSION CONTROL AND WATER QUALITY REQUIREMENTS. THE

- 2. TURBIDITY BARRIERS ARE TO BE USED IN ALL PERMANENT BODIES OF WATER REGARDLESS OF WATER DEPTH.
- 3. NUMBER AND SPACING OF ANCHORS DEPENDENT ON CURRENT VELOCITIES.
- 4. DEPLOYMENT OF BARRIER AROUND PILE LOCATIONS MAY VARY TO ACCOMMODATE CONSTRUCTION OPERATIONS.
- 5. NAVIGATION MAY REQUIRE SEGMENTING BARRIER DURING CONSTRUCTION OPERATIONS.

APPROVED PRODUCT LIST

Valve Boxes Valve boxes shall either be a Tyler or Turnbull riser specified or an & Risers: Approved equal which shall meet the following standards:

- . The gap between the cover/lid and the ring that is visible when installed must be no greater than 0.11 inches.
- The wall thickness of the ring that encircles the cover/lid shall have a wall
- · The valve box top shall weigh no less than 22 pounds.

thickness of no less than 0.65 inches.

- . The valve box bottom shall weigh no less than 27 pounds.
- The valve box lid shall weigh no less than 11 pounds.
- The 1" riser shall weight 6 pounds, 2" 9.5 pound, 3" 14 pounds and 4" 20 pounds.
- . The valve box lid shall be a non locking design with two indentations to allow for
- The brand of valve box bid shall have an option extensibit. The weight of the extension kits shall be +/- 29 lbs for 14 inches, +/- 30 lbs for 18 inches and +/- 37 lbs for 24 inches.
- Recognizing that some manufacturers may make conforming and non-conforming boxes, or risers vendors bidding such a manufacturer are advised to avoid shipping the incorrect part. The City reserves the right to return ar any time any box delivered that is non-conforming. If the non-conforming box was the vendor will be responsible for the cost of removal and installation of the conforming box. Depending on the severity and frequency of this type of oversight bidders may be restricted from future bids.

ENGINEERING	STANDARDS	2018	

REVISIONS			
BY	DATE	ENGINEERING DIVISION CITY OF POMPANO BEACH	APPROVED PRODUCT LIST
		CIT OF POMPANO BEACH	DATE: SEP 2007 DWG. NO.
	-	SCALE: N.T.S.	520-1

DIP Fittings: Mega lugs and their accessory kits shall be as manufactured by EBAA Iron, Inc. or an approved equal which shall meet the following

- Each gland shall include one mechanical restraining gland as manufactured by EBAA Iron, Inc, Series 1100, or equal, sacrificial zinc anode hex head caps of one half of the number of T- head bolts in each gland pack, one rubber gasket and the proper number of T- head bolts and nuts for the mechanical joint sizes shown the proper number of T- head bolts.
- For sizes 4 to 12 inches, package all gland materials to make one joint and mark each package to specify its weight and contents.
- Each gland shall be clearly marked with a "batch serial number". The "batch scrial number" will allow the utility to identify the date of manufacture, plant and identify what ladie of metal was used to east the gland. The vendor must be able to provide metallurgical reports for any specific gland based on the "batch serial number" that must be east into the gland. The "batch scrial number" must not be encoded and easily converted using common methods, such as the Julian Day
- Each restraining gland shall have the following weights and have no less than the number wedges listed below. All wedges will be "auto-torquing" or designed such that the nut on the actuating bold will separate at the manufacturers intended torque for to properly set the wedge. After being set, the actuating bolts will have a smaller remaining head that will allow for the disassembly of the joint.

Size	Minimum Weight	Number of Wedges	34" Bolt Length
4	7	2	4
Ď.	12	3	4
8	16	3	4.5
10	24	6	4.5
12	-33	- 8	4.5

The restraining gland shall be properly prepared and coated with a TGIC
polyester - based coating. The gripping wedges and actuating bolts shall be
properly prepared and coated with a Xylan Flourpolymer coating.

		ENGINEERING ST	ANDARDS 2018				
REVI	SIONS		400001E0 0001				
BY	BY DATE	ENGINEERING DIVISION CITY OF POMPANO BEACH	APPROVED PRODUCT LIST				
		CIT OF FOMPANO BEACH		DATE: SEP 2007 DWG. NO.			
		SCALE: N.T.S.		520-2			

Offsets, Couplings etectors shall be as manufactured by Tyler Products On an approved equal which shall meet the following standards:

The equivalent to the ELLS, 45, offsets, couplings, etcetra that are called for in various bids shall be the Tyler Product line. Equivalents shall have the same dimensions, bolt counts and certifications as the Tyler product line.


Flange Adapters shall be as manufactured by Uniflang or EZ Flange or An approved equal whish shall meet the following standards:

- Each fitting shall be clearly marked with a "batch serial number. The "batch serial number" will allow the utility to identify the date of manufacture, plant and identify what ladde of metal was used to cast the gland. The vendor must be able to provide metallungical reports for any specific fitting based on the "batch serial number" that must be cast into the gland. The "batch serial number" must not be encoded and easily converted using common methods, such as the Julian Day
- · Each restraining fitting shall have the weights listed below
- Set bolts will be "auto-torquing" or designed such that the nut on the actuating
 bolt will separate at the manufacturers intended torque for to properly set the
 wedge. After being set, the actuating bolts will have a smaller remaining head
 that will allow for the disassembly of the joint.

Size	Minimum Weight
4	6.3
6	8.8
8	12.9
10	23.1
12	29.5

The fitting shall be properly prepared and coated with a TGIC polyester - based coating. The gripping wedges and actuating bolts shall be properly prepared and coated with a Xylan Flourpolymer coating.

		ENGINEERING STA	ANDARIDS 2018	
REVISIONS				
BY	DATE	ENGINEERING DIVISION CITY OF POMPANO BEACH	APPROVED PRODUCT LIST	
		CITY OF PUMPANO BEACH	DATE: SEP 2007 DWG. NO.	
_	-	SCALE: N.T.S.	520-3	

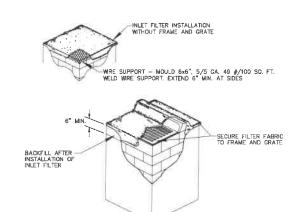

EBECCA ,

RESTOCALTRANS,


No. 40988


INSIONAL . PORIDA

- 1. CONTRACTOR IS TO CLEAN INLET FILTER AFTER EVERY STORM
- 2. CONTRACTOR TO REMOVE FABRIC JUST PRIOR TO PAVING.
- A SEDIMENT TRAP WILL BE EXCAVATED BEHIND THE CURB AT THE INLET. THE BASIN SHALL BE AT LEAST 12 TO 14 INCHES IN DEPTH, APPROXIMATELY ST INCHES IN WIDTH AND APPROXIMATELY ST TO 10 FEET IN LENGTH PARALLEL TO THE CURB.

NOT TO SCALE

INLET FILTER DETAIL

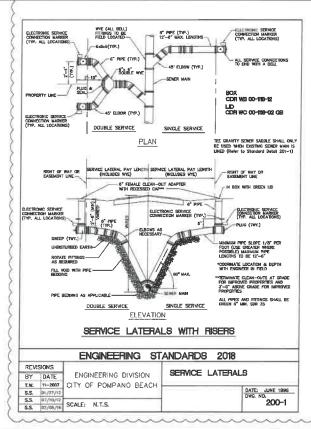

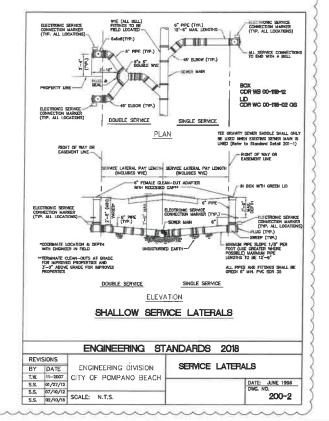

NO. DATE ISSUED FOR APRV'D BY DESIGNED: 2/28/18 DRAWN: CHECKED: D.L.M./ATAPPROVED: D.L.M.

MATHEWS (CONSULTING a BAXTER WOODMAN company

VERIFY SCALE BAR IS ONE INCH ON FULL SIZE (22×34) ORIGINAL DRAWING. ADJUST SCALES AS NECESSARY. CAD REF.: 1800DETAILS

ENGINEER NO.: 1800 CLIENT PROJECT NO.


CITY OF POMPANO BEACH ESQUIRE LAKE NEIGHBORHOOD STORMWATER IMPROVEMENTS


STANDARD DETAILS - SHEET 7 OF 10


DATE: JUNE 2018 52 of 55 DRAWING:


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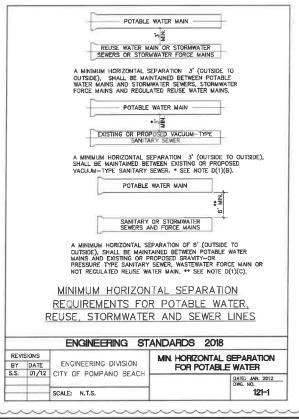
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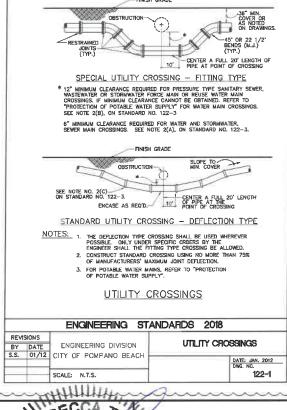




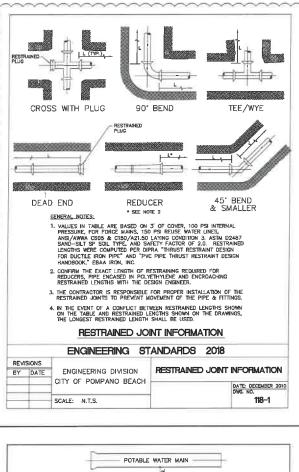


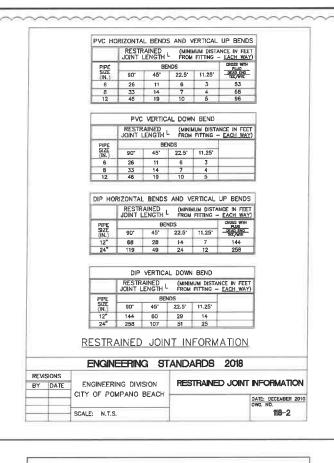

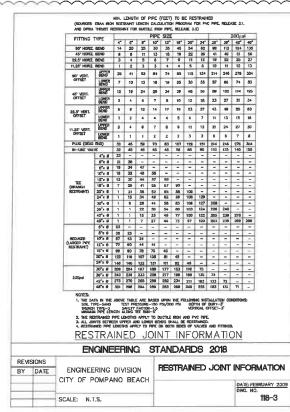


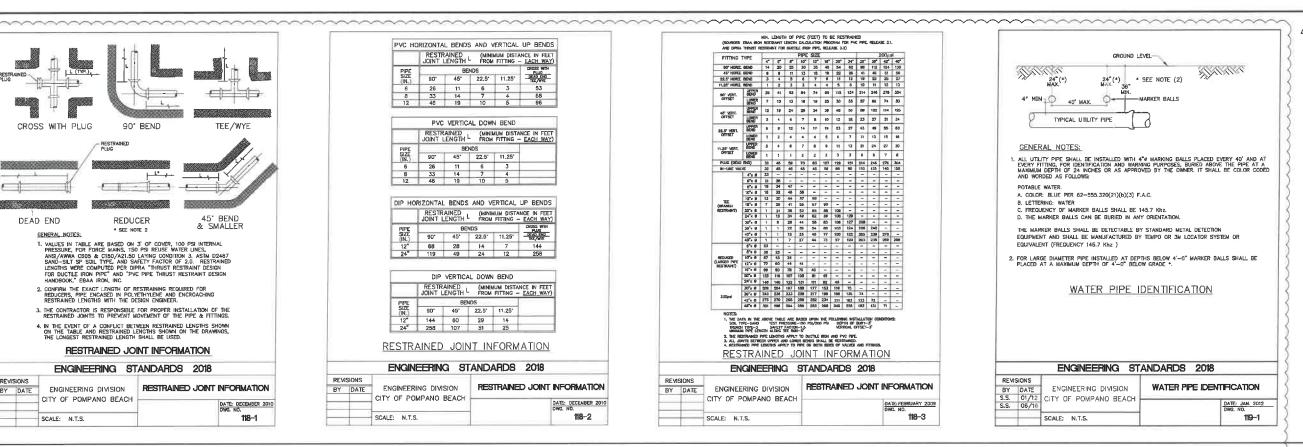

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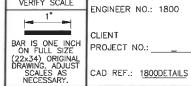

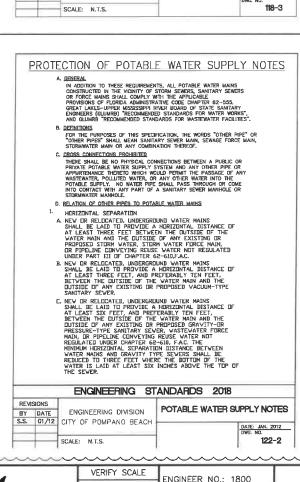
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emary Avenue, Suite 330, West Palm Beach, Florida 33401 Phone: 561-655-6175 Fax: 561-655-6179 www.baxtenwoodman.com EB-31795

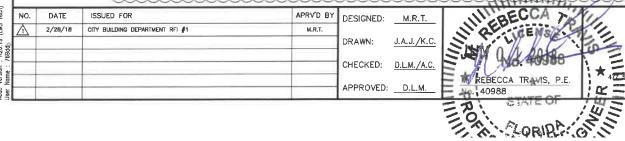

CLIENT PROJECT NO .:

CITY OF POMPANO BEACH ESQUIRE LAKE NEIGHBORHOOD STORMWATER IMPROVEMENTS

SHEET: 53 of 55

STANDARD DETAILS - SHEET 8 OF 10

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JUNE 2018

DRAWING: D-8

