

MASTER SITE PLAN REZONING

POMPANO BEACH, FL APRIL 18, 2017









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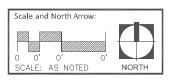
Architecture
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GONZALES ARCHITECTURE

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Description:

MASTER SITE PLAN REZONING **EXISTING ZONING** MAP




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AERIAL MAP

LEGEND



ZONING **LEGEND**

ZONING MAP

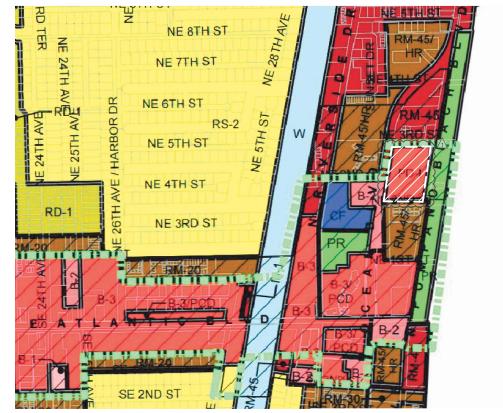




LAND USE **LEGEND**



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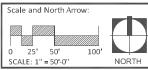
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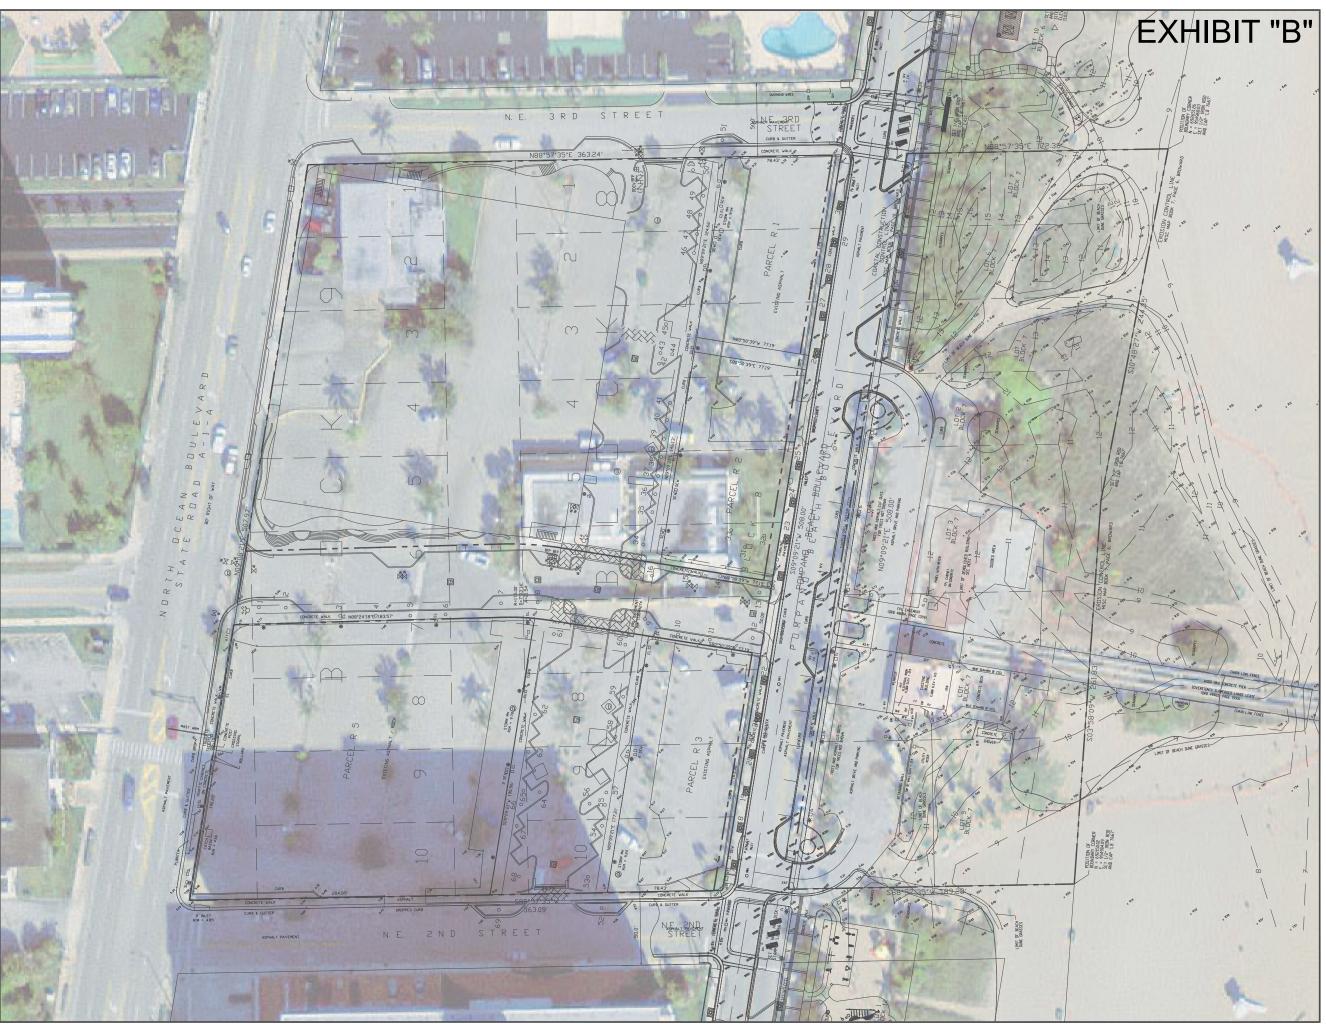
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MASTER SITE PLAN REZONING ICW TO PIER PLAN



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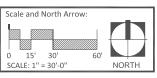
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MASTER SITE PLAN REZONING **EXISTING CONDITIONS**

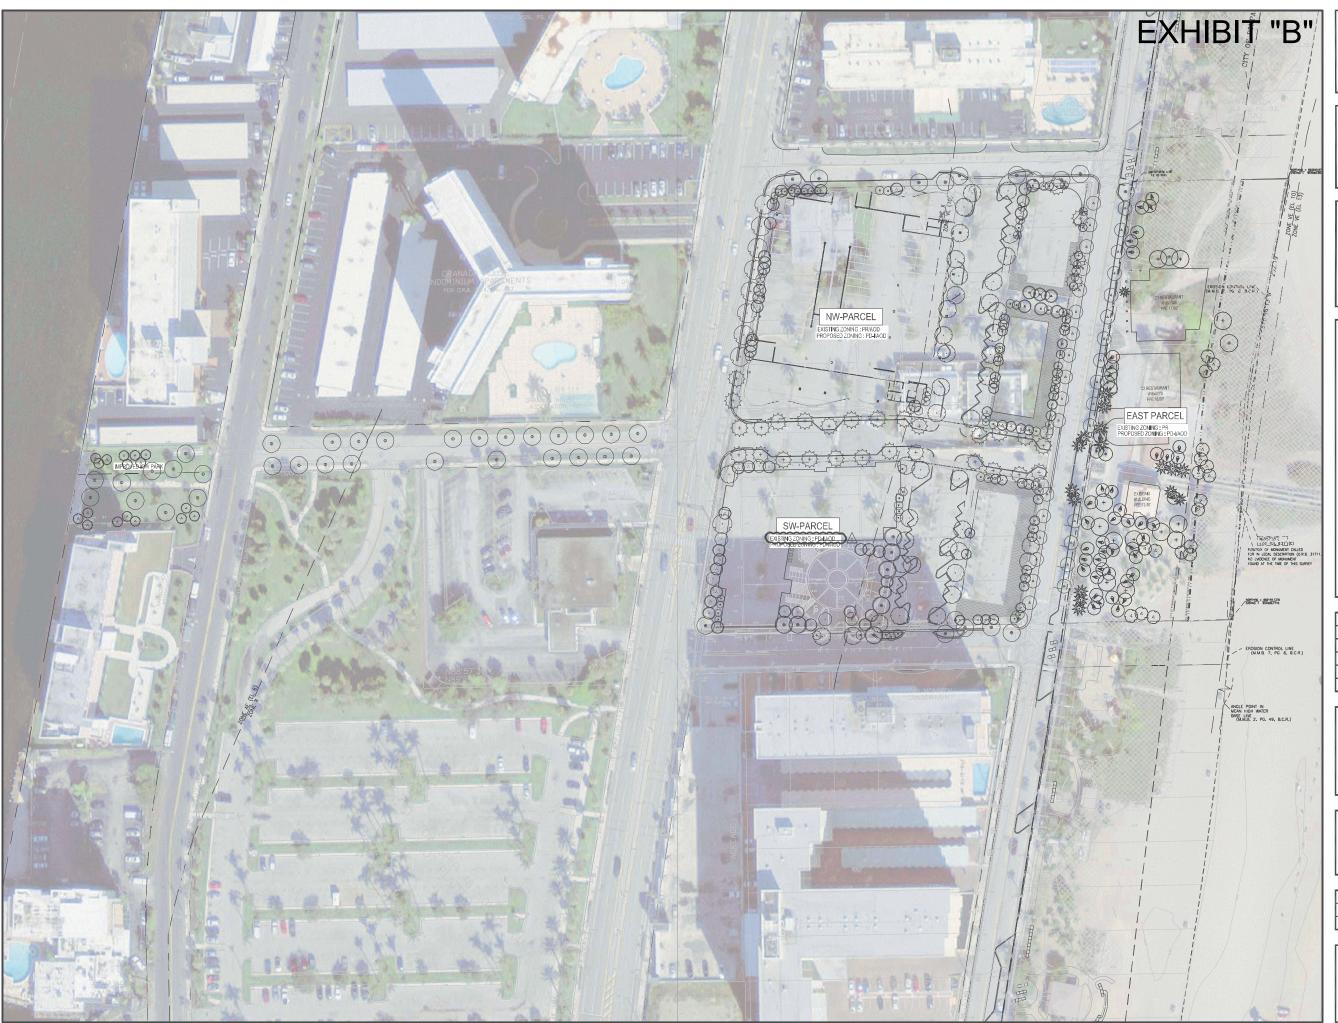

	Date: 18 APR 2017	Designed By:
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Sheet Number:

Tree #	Species/ Common	Scientific/ Botanical Name	DBH in.	Height ft.	Condition %	Appraised Value	Status	Notes
1	Silvester Palm	Phoenix sylvestris	2233	18	80	\$2,520.00	Remain in place	
2	Silvester Palm	Phoenix sylvestris		18	80	\$2,520.00	Remain in place	
3	Silvester Palm	Phoenix sylvestris		18	80	\$2,520.00	Remain in place	
4	Silvester Palm	Phoenix sylvestris		18	80	\$2,520.00	Remain in place	
5	Silvester Palm	Phoenix sylvestris		18	80	\$2,520.00	Remain in place	
6	Silvester Palm	Phoenix sylvestris		18	80	\$2,520.00	Remain in place	
7	Silvester Palm	Phoenix sylvestris		18	80	\$2,520.00	Remain in place	
8	Silvester Palm	Phoenix sylvestris		18	80	\$2,520.00	Remain in place	
9	Silvester Palm	Phoenix sylvestris		18	80	\$2,520.00	Remain in place	
10	Silvester Palm	Phoenix sylvestris		18	80	\$2,520.00	Remain in place	
11	Silvester Palm	Phoenix sylvestris		18	80	\$2,520.00 \$2,520.00	Remain in place	
12	Silvester Palm Silvester Palm	Phoenix sylvestris Phoenix sylvestris		18 18	80 80	\$2,520.00	Remain in place Remain in place	
14	Silvester Palm	Phoenix sylvestris		18	80	\$2,520.00	Remain in place	
15	Silvester Palm	Phoenix sylvestris		18	80	\$2,520.00	Remain in place	
16	Coconut Palm	Cocos nucifera		18	80	\$150.00	Remain in place	
17	Coconut Palm	Cocos nucifera		18	60	\$150.00	Remain in place	
18	Coconut Palm	Cocos nucifera		18	60	\$150.00	Remain in place	
19	Coconut Palm	Cocos nucifera		18	60	\$150.00	Remain in place	
20	Coconut Palm	Cocos nucifera		18	60	\$150.00	Remain in place	
21	Coconut Palm	Cocos nucifera		17	60	\$150.00	Remain in place	
22	Coconut Palm	Cocos nucifera		18	60	\$150.00	Remain in place	
23	Coconut Palm	Cocos nucifera		18	60	\$150.00	Remain in place	
24	Coconut Palm	Cocos nucifera		18	60	\$150.00	Remain in place	
25	Coconut Palm	Cocos nucifera		18	60	\$150.00	Remain in place	
26	Coconut Palm	Cocos nucifera		18	60	\$150.00	Remain in place	
27	Coconut Palm	Cocos nucifera		18	60	\$150.00	Remain in place	
28	Coconut Palm	Cocos nucifera		18	60	\$150.00	Remain in place	
29	Coconut Palm	Cocos nucifera		18	60	\$150.00 \$150.00	Remain in place Remain in place	
30	Coconut Palm	Cocos nucifera Cocos nucifera		18	60	\$150.00		
32	Coconut Palm Montgomery Palm	Veitchia montgomeryana		18 5GW	50 40	\$90.00	Remove	
33	Montgomery Palm	Veitchia montgomeryana		5GW	40	\$90.00	Remove Remove	
34	Live Oak	Quercus virginiana	4.5	3011	50	\$475.00	Remain in place	
35	Green Buttonwood	Concarpas erectus	3		90	\$370.00	Remain in place	
36	Gumbo Limbo	Bursera simarruba	4.25		90	\$600.00	Remain in place	
37	Green Buttonwood	Concarpas erectus	3		90	\$370.00	Remain in place	
38	Gumbo Limbo	Bursera simarruba	4		90	\$600.00	Remain in place	
39	Green Buttonwood	Concarpas erectus	2.5		90	\$370.00	Remain in place	
40	Gumbo Limbo	Bursera simarruba	3.75		70	\$600.00	Remain in place	
41	Green Buttonwood	Concarpas erectus	3		80	\$370.00	Remain in place	
42	Gumbo Limbo	Bursera simarruba	4		70	\$600.00	Remain in place	
43	Gumbo Limbo	Bursera simarruba	4.5		80	\$600.00	Remain in place	
44	Gumbo Limbo	Bursera simarruba	4.25		70	\$600.00	Remain in place	
45	Live Oak	Quercus virginiana	4.75		90	\$475.00	Remain in place	
46	Green Buttonwood	Concarpas erectus	2.75		90	\$370.00	Remain in place	
47 48	Green Buttonwood	Bursera simarruba Concarpas erectus	3.75 2.75		70 80	\$600.00 \$370.00	Remain in place Remain in place	
48	Green Buttonwood Gumbo Limbo	Bursera simarruba	4		70	\$600.00	Remain in place	
50	Live Oak	Quercus virginiana	5		50	\$475.00	Remain in place	
51	Green Buttonwood	Concarpas erectus	2.75		90	\$370.00	Remain in place	
52	Green Buttonwood	Concarpas erectus	3.5		80	\$370.00	Remain in place	
53	Live Oak	Quercus virginiana	4.75		10	\$95.00	Remain in place	
54	Green Buttonwood	Concarpas erectus	2.5		70	\$370.00	Remain in place	
55	Gumbo Limbo	Bursera simarruba	4		60	\$360.00	Remain in place	
56	Gumbo Limbo	Bursera simarruba	4		60	\$360.00	Remain in place	
57	Gumbo Limbo	Bursera simarruba	4.25		60	\$360.00	Remain in place	
58	Green Buttonwood	Concarpas erectus	2.5		90	\$370.00	Remain in place	
59	Green Buttonwood	Concarpas erectus	2.5		90	\$370.00	Remain in place	
60	Live Oak	Quercus virginiana	4.5		50	\$475.00	Remain in place	
61	Live Oak	Quercus virginiana	4.5		40	\$380.00	Remain in place	
62	Green Buttonwood	Concarpas erectus	2.25		90	\$370.00	Remain in place	
63	Green Buttonwood	Concarpas erectus	2.5		80	\$370.00	Remain in place	
64	Gumbo Limbo	Quercus virginiana Quercus virginiana	4		60	\$360.00 \$360.00	Remain in place	
65	Gumbo Limbo	Quercus virginiana Quercus virginiana	3 75		60	\$360.00	Remain in place Remain in place	
66 67	Green Buttonwood	Concarpas erectus	3.75 2.5		70	\$370.00	Remain in place	
07	Green Buttonwood	Quercus virginiana	4.75		10	\$95.00	Remain in place	
68	Live Oak							







Clients:
New Urban Communities
CASTER developers

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GONZALES ARCHITECTURE Architecture 4304 NE 2nd Avenue Miami, FL 33137

	Rev:	Date:	Description:	By:

MASTER SITE PLAN REZONING TREE DISPOSITION LIST

care	and	North	Arrow:	

Date: 18 APR 2017 Designed By: Project No: 113037 Drawn By:

Sheet Number:

L-0.10







Clients:





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MASTER SITE PLAN REZONING TREE DISPOSITION

Scale and North Arrow 15' 30'

PLAN

Date: 18 APR 2017	Designed By:
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Sheet Number:

L-0.11

TREE DISPOSITION NOTES:

- REFER TO THE TREE DISPOSITION TABLES ON L-0.10 FOR REFERENCE.
 THE CONTRACTOR SHALL CALL FOR AND ATTEND AN INSPECTION OF EXISTING CONDITIONS BY THE OWNER PRIOR TO COMMENCING WORK, INCLUDING BUT NOT LIMITED TO IDENTIFICATION OF TREES, AND POTENTIAL OBSTRUCTIONS TO THE RELOCATION WORK. THE CONTRACTOR WILL PREPARE A REPORT OF EXISTING CONDITIONS AS A MATTER OF RECORD, TO INCLUDE PHOTOGRAPHS. THE CONTRACTOR WILL ACCEPT THE EXISTING CONDITIONS AS A REFERENCE POINT FOR CONDITION OF TREES, AND CONDITION OF THE SITE. EXISTING CONDITIONS WILL THEN BECOME THE RESPONSIBILITY OF THE CONTRACTOR TO KEEP INTACT
- 3. CONTRACTOR SHALL NOTIFY LANDSCAPE ARCHITECT OF ANY CONFLICTS BETWEEN PROPOSED IMPROVEMENTS AND EXISTING TRESS/PALMS.
 4. ALL EXISTING TREES TO REMAIN SHALL BE PROTECTED BY INSTALLING
- PROTECTIVE BARRIERS AROUND THE DRIP LINE OF TREES PER DETAIL 3/ L9-1.05. TREE PROTECTION BARRIERS SHALL BE INSTALLED PRIOR TO COMMENCEMENT OF DEMOLITION AND MAINTAINED THROUGHOUT
- CONSTRUCTION,
 ALL TREES SUBJECT TO ENCROACHMENT INTO THE ROOTZONE, DUE TO PROPOSED CONSTRUCTION, SHALL BE ROOT PRUNED 18' FROM THE PAVEMENT EDGE OR TRENCH AS INDICATED ON THE DRAWINGS AND HEREIN THESE SPECIFICATIONS.
- TREE PITS RESULTING FROM RELOCATED MATERIAL SHALL BE BACKFILLED WITH CLEAN, STABLE FILL AND BROUGHT FLUSH WITH SURROUNDING GRADE.
- CONTRACTOR SHALL FOLLOW THE AMERICAN STANDARD FOR TREE CARE OPERATIONS - TREE, SHRUB AND OTHER WOODY PLANT MAINTENANCE - STANDARD PRACTICES (TRANSPLANTING ANSI A300(PART 6)-2005 MUST BE ADHERED TO IN ITS ENTIRETY FOR ALL RELOCATIING/TRANSPLANTING OF TREES AND SHRUBS. ANSI A300 (PART 6-2005 INCLUDES THE FOLLOWING: 60-TRANSPLANTING STANDARDS, 61-NORMATIVE REFERENCES, 62-
- DEFINITIONS, 63-TRANSPLANTING PRACTICES.

 EXISTING TREES TO BE RELOCATED SHALL BE CROWN PRUNED, ROOT PRUNED, AND TREATED WITH SOIL AMENDMENTS PRIOR TO RELOCATION. ALL TREES ARE TO BE TRIMMED BY THINNING THE CROWN ONLY, AND NOT BY REDUCING CROWN DIMENSIONS. TRIM TO CONFORM TO NAA AND ISA STANDARDS, INCLUDING REMOVAL OF DEAD WOOD.
- WATERING:
 8.A. ALL TREES TO BE RELOCATED ARE TO BE PROVIDED WITH AN AUTOMATIC IRRIGATION SYSTEM WHICH PROVIDES 3 BUBBLER HEADS FED BY PVC PIPE TO EACH TREE.
 - 8.B. THE CONTRACTOR SHALL VERIFY A SOURCE OF MUNICIPAL OR WELL WATER AND PROVIDE FOR A TEMPORARY METER TO OPERATE THE IRRIGATION. WATER TO BE TREATED FOR SALT CONTENT, IF WELL WATER. IF LEVELS ARE NOT CONDUCIVE TO PLANT MATERIAL GROWTH, AN ALTERNATE SOURCE OF WATER SHALL BE UTILIZED AT
 - NO ADDITIONAL EXPENSE. 8.C. PROVIDE IRRIGATION TIMER, OR BATTERY POWERED VALVE TO WATER TREES TO BE RELOCATED. HAND WATERING IN LIEU OF AUTOMATIC SYSTEM SHALL NOT BE ALLOWED, HOWEVER HAND WATERING SHALL BE PERFORMED TO AVOID LAPSES SHOULD THE AUTOMATIC SYSTEM BE INOPERABLE FOR MORE THAN 24 HOURS.
- 9.A. BARRICADES SHALL BE INSTALLED AT AN OFFSET DISTANCE OF 2'
 (TWO FEET) OUTSIDE THE TREE DRIP LINE/EDGE OF TREE CANOPY,
 PRIOR TO ANY CONSTRUCTION ACTIVITY.

 9.B. BARRICADE ALL EXISTING TREES AND PALMS WITH SIX FOOT (6')
- CHAIN LINK FENCE OR OTHER BARRICADE APPROVED BY OWNER. 10. ROOT PRUNING TECHNIQUE:
- 10.A. ALL TREES SHALL BE EXCAVATED BY DIGGING A TRENCH A MINIMUM OF 48" DEEP BY 6" WIDE, EITHER BY HAND OR WITH A TRENCHING
 MACHINE DESIGNED FOR THIS PURPOSE. HAND CUT BROADLEAF
 TREE ROOTS AFTER TRENCHING TO PRODUCE CLEAN CUTS WITH NO
- 10.B. TREES TO BE ROOT PRUNED SHALL HAVE A MINIMUM ROOT BALL SIZE OF 10" PER 1" OF CALIPER MEASURED AT DBH FOR BROAD LEAF TREES. ROOT BALLS ARE TO BE FORMED SQUARE, ALL TRENCHES BEING EQUAL DISTANCE FROM THE TRUNK.
- 11.A. ALL BROADLEAF TREES ARE TO BE RELOCATED SHALL BE
 MAINTAINED FOR A MINIMUM OF TWELVE (12) WEEKS AFTER ROOT PRUNING PRIOR TO RELOCATION.

LEGEND






EXISTING PALM/TREE - PROTECT IN PLACE





EXISTING PALM/TREE - RELOCATE

EXISTING PALM/TREE

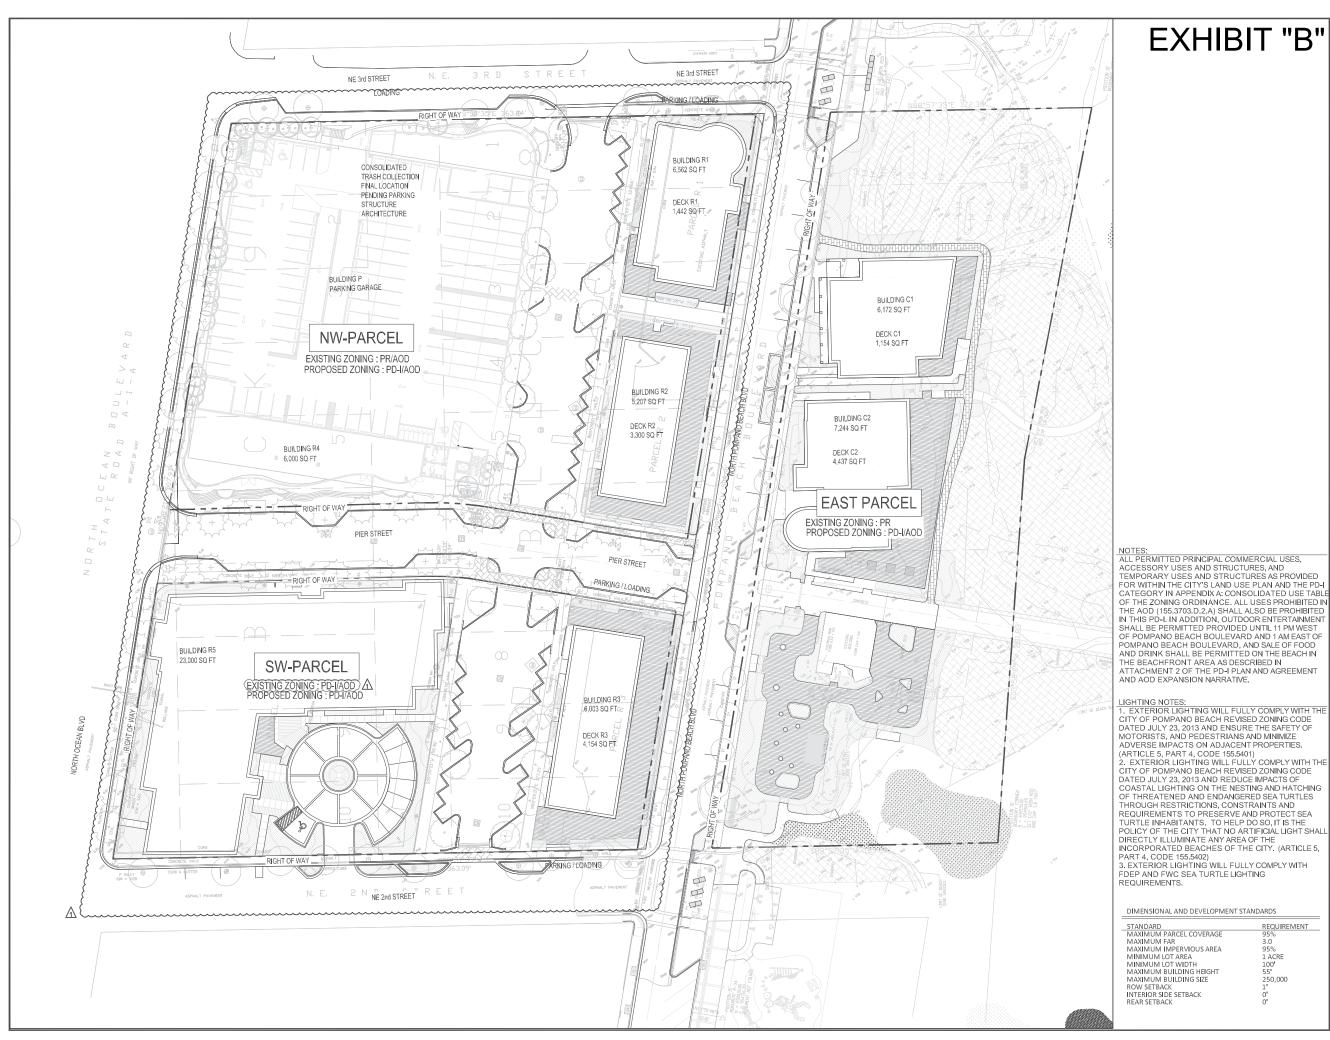







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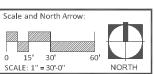
GONZALES ARCHITECTURE

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MASTER SITE PLAN REZONING

SITE PLAN




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REQUIREMENT

95% 1 ACRE 100' 55'

250,000

Sheet Number: L-1.01



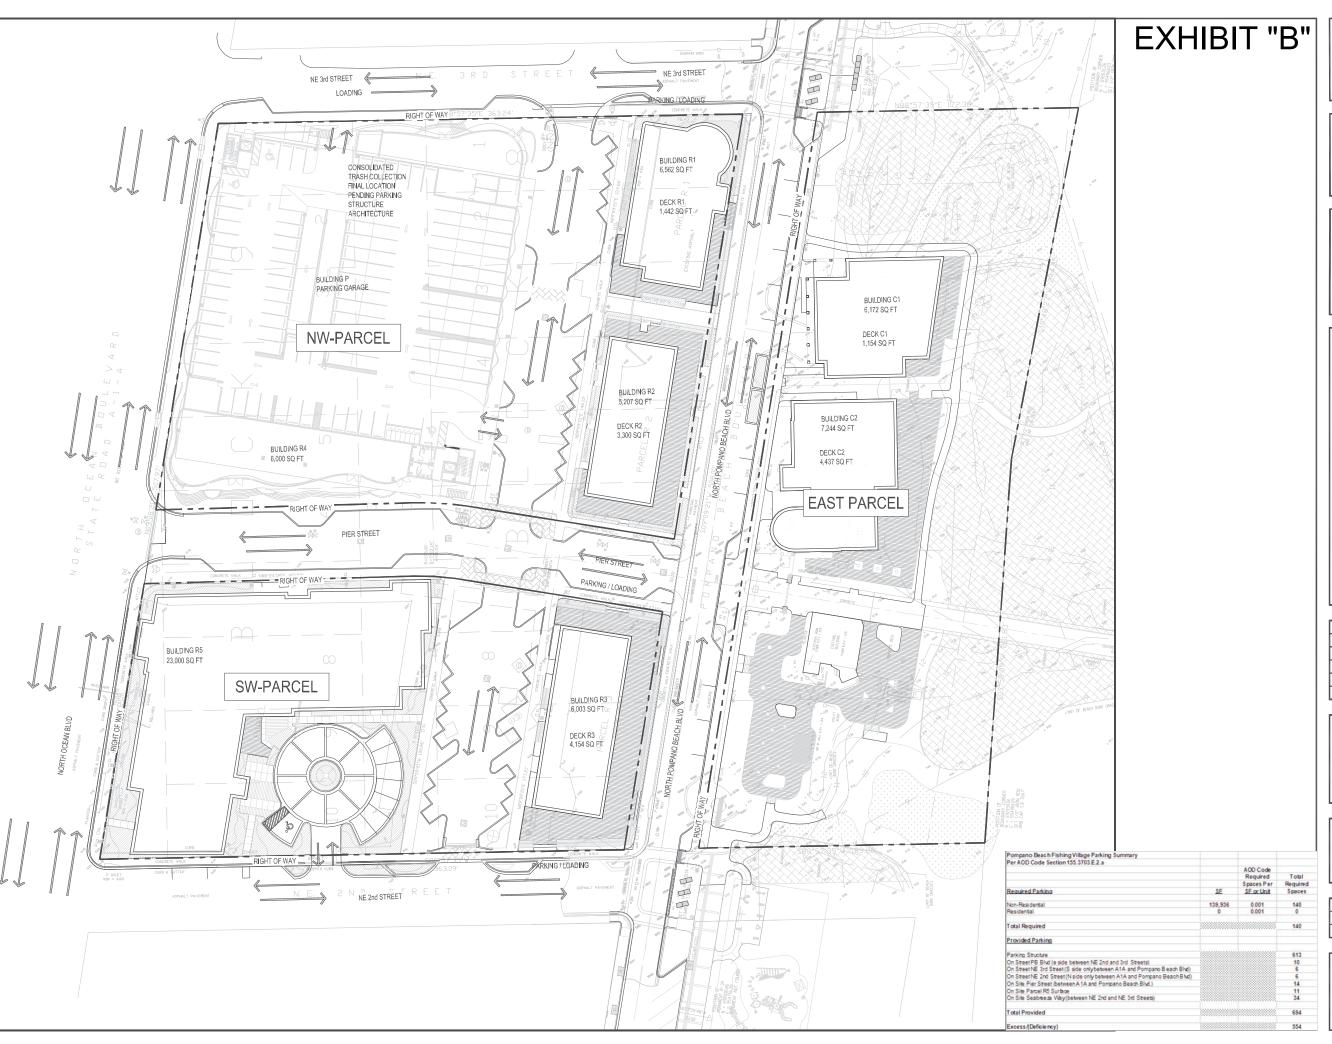





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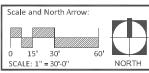
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MASTER SITE PLAN REZONING **CIRCULATION** PLAN



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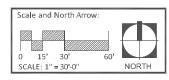
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MASTER SITE PLAN REZONING

LAYOUT PLAN



-	Date: 18 APR 2017	Designed By:
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1		

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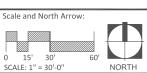
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MASTER SITE PLAN REZONING **EXISTING** COVERAGE



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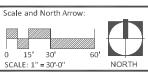
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MASTER SITE PLAN REZONING **PROPOSED** COVERAGE



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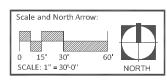
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MASTER SITE PLAN REZONING PHASING PLAN



П	Date: 18 AP	R 2017	Designed By:
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L-4.01

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PLANTING NOTES:

- 1. ALL PLANTS SHOULD BE HEALTHY, OF STRONG MATERIAL, FREE OF PLAGUE AND SICKNESS. ALL PLANTS MUST BE IN COMPLETE AND STRICT ACCORDANCE WITH ARTICLE NO. 1 OF FLORIDA'S "QUALITY STANDARDS FOR NURSERY PLANTS" PUBLISHED BY THE DEPARTMENT OF AGRICULTURE AND SERVICES FOR CONSUMERS. IN SOME INSTANCES THE PLANTS MUST BE OF SUPERIOR QUALITY THAN NO. 1 TO BE ABLE TO ACHIEVE THE MINIMAL REQUIREMENT FOR THIS PROJECT.
- THE CONTRACTOR IS RESPONSIBLE FOR THE PLANTS MEETING THE SPECIFICATIONS AS NOTED PRIOR TO THEIR
 INSTALLATION. THE CONTRACTOR MUST IMMEDIATELY REMOVE ANY PLANT THAT DOES NOT MEET THE SPECIFICATIONS.
- ALL ROOT BALLS MUST BE IN ACCORDANCE TO THE SIZE STANDARDS ESTABLISHED IN "AMERICAN STANDARDS FOR NURSERY PLANTS".
- 4. THE CONTRACTOR MUST PRESENT TO THE LANDSCAPE ARCHITECT THE INSPECTION CERTIFICATE FROM THE NURSERY AND/OR THE STATE OF ALL PLANTS TWO (2) WEEKS PRIOR TO COMMENCEMENT OF WORK.
- ALL PLANTS MUST BE PROTECTED DURING THEIR TRANSPORT AND TAKEN TO THE SITE COVERED WITH A CLOTH FOR SHADE OR OTHER PREVENTIVE FORM TO PROTECT THE PLANTS AGAINST WIND BURN.
- 6. THE CONTRACTOR MUST VERIFY ALL INFORMATION ON SITE BEFORE INSTALLATION BEGINS. ALL EXISTING PLANTS MUST REMAIN INTACT AND UNDISTURBED UNLESS IT IS SPECIFIED IN THE PLANS.
- 7. ANY SUBSTITUTION OF SIZE AND/OR PLANT TYPE MUST BE PRE-APPROVED BY THE LANDSCAPE ARCHITECT. ALL PLANTS ARE SUBJECT TO THE APPROVAL OF THE LANDSCAPE ARCHITECT BEFORE THEY ARE PLANTED.
- 8. THE LANDSCAPE CONTRACTOR MUST PLACE STAKES ON THE PLANT LOCATION BEFORE THE PLANTING BEGINS FOR REVIEW AND APPROVAL BY THE LANDSCAPE ARCHITECT.
- 9. ALL TREES MUST HAVE STRAIGHT, LEAFY TRUNKS, AND MUST MEET ALL THE SPECIFIED REQUIREMENTS.
- 10. BEFORE CONSTRUCTION BEGINS, THE CONTRACTOR IS RESPONSIBLE FOR LOCATING ALL UNDERGROUND UTILITIES AND MUST AVOID DAMAGING ANY SERVICES DURING CONSTRUCTION. IF ANY DAMAGE OCCURS BY FAULT OF THE CONTRACTOR, THE NECESSARY REPAIR MUST TAKE PLACE AT THE CONTRACTOR'S EXPENSE AND UNDER THE SUPERVISION OF THE LANDSCAPE ARCHITECT.
- 11. INSTALLATION -ALL PLANTS MUST BE INSTALLED PROFESSIONALLY AND WITH GREAT CARE AND OF THE QUALITY PREVIOUSLY DESCRIBED. ALL LANDSCAPE ELEMENTS MUST BE INSTALLED IN A WAY TO MEET ALL REQUIRED CODES AND ORDINANCES.
- 12. TYPICALLY, THE PLANTING OF SHRUBS AND GROUNDCOVER ARE SHOWN AS PLANTING BED LAYERS. THE PLANTS MUST BE PLACED IN A TRIANGULAR SPACING CONFIGURATION (IRREGULAR SPACING) AS SHOWN IN THE PLANTING DETAILS. THE DIMENSIONS FROM CENTER TO CENTER (O.C.) OF THE PLANTS CAN BE FOUND IN THE PLANT LIST.
- 13. THE CONTRACTOR MUST SECURE THE DRAINAGE AND PERCOLATION OF ALL PLANTING WELLS PRIOR TO THE PLANT INSTALLATION. THE CONTRACTOR MUST FILL ALL WELLS WITH WATER BEFORE PLANTING TO MAKE SURE THAT DRAINAGE AND PERCOLATION ARE FEASIBLE AND FIX WHATEVER IS NECESSARY TO ACCOMPLISH THIS. THE CONTRACTOR IS RESPONSIBLE TO REPLACE ANY PLANT LOST DUE TO INADEQUATE DRAINAGE CONDITIONS.
- 14. ANY TREE THAT HAS BEEN PLANTED IN A GROW BAG OR SIMILAR MATERIAL MUST HAVE THE BAG COMPLETELY REMOVED PRIOR TO ITS PLANTING.
- 15. THE TOP HALF PART OF THE BURLAP HAS TO BE CUT OR REMOVED SURROUNDING THE TRUNK FROM THOSE PLANTS THAT HAVE BURLAP OR ARE INSIDE BAGS, IT SHOULDN'T BE TOTALLY REMOVED. WIRE CAGES, STRAPS, ETC. SHOULD BE CUT AND REMOVED BEFORE INSTALLATION.
- 16. THE CONTRACTOR SHOULD REPLACE ANY PLANT THAT IS NOT APPROVED WITHIN A WEEK OF BEING NOTIFIED.
- 17. THE CONTRACTOR SHOULD REFER TO THE LANDSCAPE PLANTING DETAILS, PLANT LIST, NOTES AND PLANTING SPECIFICATIONS FOR COMPLETE INSTRUCTIONS ON THE LANDSCAPE PLANTING.
- 18. FERTILIZATIOI

PALMS 13-3-13 PLUS LOWER ELEMENTS -SLOW DISCHARGE 0.2 KG FERTILIZER BY 1CM REGULATOR
SHRUBS AND GROUNDCOVER 8-10-10 PLUS LOWER ELEMENTS-SLOW DISCHARGE 0.5KG FERTILIZER BY 10 M2
TREES 8-6-6 PLUS LOWER ELEMENTS - SLOW DISCHARGE 0.2 KG FERTILIZER BY 1 CM REGULATOR
GRASS 16-4-9 PLUS LOWER ELEMENTS - SLOW DISCHARGE 0.5 KG FERTILIZER BY 10 M2

*THE COST OF THE LANDSCAPE FERTILIZER PREVIOUSLY DESCRIBED SHOULD BE INCLUDED IN THE PRICE OF THE PLANT.

19. PREPARATION AND MIXTURE OF THE PLANT SOIL.

A. APPLY 'RDUNDUP' (MANUFACTURED BY MONSANTO CORP) OR SIMILAR PESTICIDE APPROVED ACCORDING TO THE PORCENTAGE AND SPECIFICATIONS BY THE MANUFACTURER WITHIN THE LIMITS OF ALL THE AREAS THAT WILL BE PLANTED. PROTECT ALL PLANTS FROM OVER-WATERING OR WATER WITHIN THE ROOT ZONE, THE CONTRACTOR MUST MAKE SURE TO ERRADICATE ALL WEEDS.

- B. BEFORE REPLACING THE SUPERIOR PLANT SOIL, THE SURFACE MUST BE RAKED TO REMOVE ALL ROCKS (25 MM IN DIAMETER OR GREATER), DEBRIS, GARBAGE AND REMAINS FROM PLANTS THAT WERE REMOVED.
- C. RAKE THE SUBSOIL TO A DEPTH OF 75 MM.
- D. THE CONTRACTOR MUST APPLY PRE-EMERGENT PESTICIDE APPROVED ACCORDING TO THE PORCENTAGES AND SPECIFICATIONS OF THE MANUFACTURER.
- E. THE PLANT SOIL MIX FOR TREES, SHRUBS AND GROUNDCOVER SHOULD BE THOROUGHLY PREPARED CONSISTING OF:

 1. ROYAL PALMS

60% CLEAN SAND DOT

40% SUPERFICIAL LAYER OF SOIL/COMPOSED OF APPROVED SOLID WASTE

2. ALL OTHER PALMS

90% CLEAN SAND D.O.T.

10% SUPERFICIAL LAYER OF SOIL/COMPOSED OF APPROVED SOLID WASTE

3. SHRUBS AND GROUNDCOVER

70% CLEAN SAND D.O.T.

30% SUPERFICIAL LAYER OF SOIL /COMPOSED OF APPROVED SOLID WASTE
THE CONTRACTOR MUST PRESENT SAMPLES OF THE PLANT 501 L MIX PREPARED IN THE LABORATORY TO THE LANDSCAPE ARCHITECT FOR APPROVAL.

- F. THE MIX COMPOSED OF WASTE SHOULD BE FREE OF NEMATODES THAT COULD BE PERJUDICIAL TO PLANT GROWTH, MUST BE OF UNIFORM QUALITY AND SHOULD HAVE A PH VALUE BETWEEN S.3 AND 6.5 (AS DETERMINED ACCORDING TO ASTM E70) FLORIDA MOSS MUST BE STERRILIZED TO BE FREE OF ALL VABLE NUT GRASS AND OTHER UNDESIRABLE WEEDS.
- G. SUPERFICIAL LAYER OF PLANT SOIL SHOULD BE NATURAL, FERTILE, AND CAPABLE TO SUSTAIN THE VIGOROUS GROWTH OF PLANTS. IT MUST HAVE A UNIFORM COMPOSITION MIXED WITH SUBSOIL IT MUST BE FREE OF ROCKS, LUMPS, LIVE PLANTS AND ROOTS, BRANCHES AND OTHER FOREIGN MATERIAL. EXTEND THE SUPERFICIAL LAYER OF SOIL MIX TO A MINIMUM DEPTH OF 75 MM ACROSS ALL AREAS AND 150 MM IN AII THE PLANTING BEDS FOR SHRUBS AND GROUNDCOVER. REMOVE ALL ROCKS AND OTHER OBJECTS WITH MORE THAN 25MM IN DIAMETER.
- H. SMOOTH THE SUPERFICIAL LAYER OF PLANT SOIL TO IOOMM BELOW THE EDGES OF THE ADJACENT PAVEMENT.
- I. THE FINAL GRADING OF THE PREPARED SUPERFICIAL LAYER OF PLANT SOIL SHOULD BE A SMOOTH AND EVEN SURFACE TO MAKE SURE THAN THERE IS POSITIVE DRAINAGE AWAY FROM ANY STRUCTURES AND ELIMINATE ANY LOW AREAS THAT CAN COIL FCT WATER
- J. SMOOTH THE SUPERFICIAL LAYER OF PLANT SOIL MIX TO 150 MM BELOW THE FINAL LEVEL IN THE GRASS AREAS.
- K. THE SUPERFICIAL LAYER OF PLANT SOIL SHOULD NOT HAVE HIGH LEVELS OF ACID OR ALCALINE NOR CONTAIN ANY TOXIC SUBSTANCES THAT COULD BE HAZARDOUS TO PLANT GROWTH. THE PH LEVEL SHOULD BE BETWEEN THE RANGE OF 5.5 TO 6.5. IF NECESSARY, THE CONTRACTOR SHOULD MAKE THE APPROPRIATE CORRECTIONS TO THE PH LEVEL OF THE TOP LAYER ADJUSTING THE PH TO BE BETWEEN 5.5 A 6.5.
- 20. THE PRACTICE OF STAKING SHOULD NOT ALLOW NAILS, SCREWS, WIRES, ETC. TO PENETRATE THE OUTER SURFACE OF THE TREES OR PALMS. THE TREES OR PALMS THAT ARE REJECTED DUE TO THIS PRACTICE SHOULD BE REPLACED IN THE PRESENCE OF AN INSPECTOR.
- THE CONTRACTOR MUST LAY FERTILIZER MIXED WITH MALALEUCA MULCH FREE OF ANY WEEDS THROUGHOUT ALL PLANTING AREAS AT A MINIMUM DEPTH OF 75 MM.
- 22. THE CONTRACTOR IS RESPONSIBLE OF COMPLETELY MAINTAINING THE PLANTING AREAS (INCLUDING WATERING, SPRAYING, FERTILIZING, MOWING, ETC.) UNTIL THE WORK HAS BEEN ACCEPTED COMPLETELY UNTIL THE END OF THE PERIOD.
- 23 ESTABLISHED BY THE ENGINEER AND LANDSCAPE ARCHITECT FOR THE PROJECT
- 24. THE CONTRACTOR MUST GUARANTEE ALL THE PLANTS FOR A 90 DAY SETTLING PERIOD AFTER THE COMPLETION DATE.
- 25. THE CONTRACTOR MUST REQUEST INSPECTION OF THE PROJECT IN WRITING. IF ALL WORK IS SATISFACTORY AND COMPLETE ACCORDING TO THE CONDITIONS OF THE CONTRACT DOCUMENTS, THEN THE OWNER AND THE LANDSCAPE ARCHITECT MUST DECLARE THE PROJECT COMPLETE, THIS DECLARATION WILL CONSTITUTE AS THE BEGINNING OF THE GUARANTEE PERIOD.
- 26. DURING THE REMOVAL OF THE STAKES OR STRAPS FOR THE TREES AND PALMS AFTER THE INSTALLATION PERIOD WILL BE THE RESPONSIBILITY OF THE OWNER.
- 27. ALL PLANTS MUST BE OF FLORIDA QUALITY NO.1 OR BITTER IN THE MOMENT OF INSTALLATION AND SHOULD BE MAINTAINED IN THE SAME CONDITION UNTIL THE PROJECT HAS BEEN ACCEPTED. IF THE PLANTS FALL BELOW QUALITY DURING THE MAINTENANCE PERIOD THEY WILL BE REJECTED AND MUST BE REPLACED.



Prepared for:



Clients:

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	Rev:	Date:	Description:	By:

Shoot Title

MASTER SITE PLAN REZONING LANDSCAPE DETAILS

Scale and North Arrow.							

Date: 18 APR 2017 Designed By:
Project No: 113037 Drawn By:

Sheet Number

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IRRIGATION NOTES: 1. LANDSCAPING SHALL BE KEPT IN HEALTHY GROWING CONDITIONS THROUGH APPROPRIATE IRRIGATION BY AN AUTOMATIC UNDERGROUND IRRIGATION SYSTEM INSTALLED IN ACCORDANCE WITH REQUIREMENTS OF THE BUILDING CODE. 2. THE IRRIGATION SYSTEM SHALL INCLUDE A RAIN-SENSING CUTOFF DEVICE THAT SHALL BE LOCATED AND INSTALLED SO THAT BUILDING EAVES, BALCONIES, AND SIMILAR OVERHANGS DO NOT INTERFERE WITH EFFECTIVE OPERATION OF THE DEVICE. 3. THE IRRIGATION SYSTEM SHALL BE PROPERLY MAINTAINED IN GOOD WORKING ORDER AND PROVIDE A MINIMUM COVERAGE OF 100 PERCENT WITH 50 PERCENT OVERLAP. 4. WATER USED FOR IRRIGATION SHALL BE RUST-FREE EXCEPT WHERE DEEMED UNNECESSARY BY THE DEVELOPMENT SERVICES DIRECTOR. 5. WATER USED FOR IRRIGATION SHALL BE REUSE WATER WHEREVER PRACTICABLE. TREE_SCHEDULE HH

EXHIBIT "B"







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Rev:	Date:	Description:	By:
1	05/31/17	REZONING AND BUILDING APPLICATION RESUBMITTAL	EDSA

Sheet Title:
MASTER SITE PLAN REZONING

TREE PLAN

Scale and North Arrow:

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SCALE: 1" = 30'-0"	NORTH
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Date: 18 APR 2017	Designed By:
Project No. 112027	Deauer But

Project No:	113037	Drawn By:

Sheet Number: L-5.01

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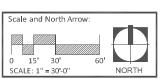
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Rev:	Date:	Description:	ву:
1	05/31/17	REZONING AND BUILDING APPLICATION RESUBNITTAL	EDSA

Sheet Title:
MASTER SITE PLAN REZONING

SHRUB PLAN



Date: 18 APR 2017	Designed By:
Project No: 113037	Drawn By:

Sheet Number: Paul Digitally signed by Paul Kissi Kissinger Date: 2017.06.07 NGEr 16:45:12 -04'00' L-6.01

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SHRUB SCHEDULE

SHRUB AREAS	QTY	BOTANICAL NAME	COMMON NAME	MIN CONT.	SIZE	SPAC
ALZ	19	Alpinia zerumbet 'Varlegata'	Varlegated Shell Ginger	7 gal	3° O.A.	36" o.c.
CA	7	Crinum augustum	Crinum Lily	7 gal	30" OA	
CES	314	Conocarpus erectus 'serlceus'	Silver Button Wood	7 gal	30" O.A.	24" o.c.
CHI	192	Chrysobalanus icaco 'Red Tip'	Red Tip Cocoplum	3 gal	24" ht. x 24" spr.	28" o.c.
EHH COCC	87	Chrysobalanus Icaco Horizontalis	Harlzantal Cocopium	3 gal	18" OA	24" o.c.
COE	251	Conocarpus erectus	Green Buttonwood	7 gal		30" o.c.
DIT	292	Dianella tasmanica 'Blueberry'	Blueberry Flax Uly	3 gal	20" O.A.	24" o.c.
FIM	265	Ficus microcarpa 'Green Island'	Green Island Flous	3 gal	12" ht. x 12" spr.	24" o.c.
MUC	30	Muhlenbergla capillaris 'Gulf Coast'	Gulf Coast Muhly	3 gal	12" O.A.	30" o.c.
NEO-P	26	Nerlum oleander Pinki	Plnk Oleander	7 gal	4' O.A.	48" o.c.
NEQ-W	45	Nerium cleander White	White Oleander	7 gal	4 0.A	48" o.c.
POM	106	Podocarpus macrophylus	Yew Pine	7 gal	36" HT	36" o.c.
SPP	181	Spartina patens	Salt Meadow Cord Grass	1 gal	12" HT	24" o.c.
VEM	632	Verbana maritima	Beach Verbena	1 gal	8" HT x 12" SPR	12" o.c.