


PARKING RAMP
SCHEMATIC SECTION

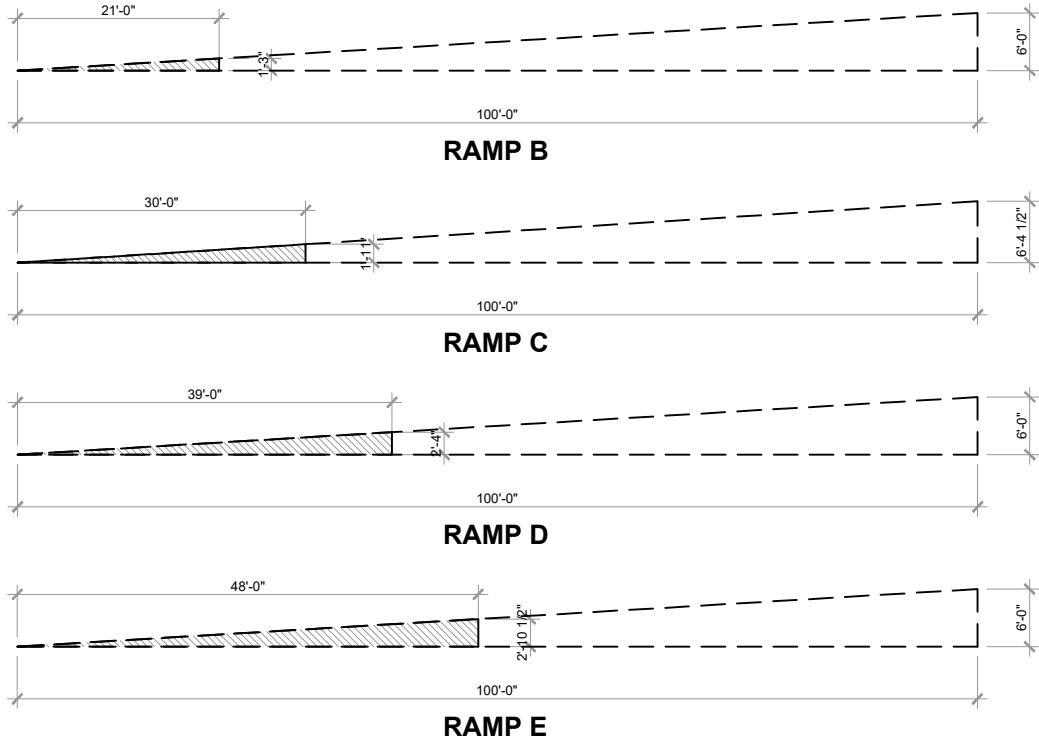

COMPACT PARKING SPACE
38 PS / 282 PS (MIN. REQUIRED PARKING) = 13.48%


CONVEX
MIRROR

PARKING COUNT PER LEVEL		
LEVEL	COUNT	
LEVEL 3	18 PS	
LEVEL 2	77 PS	
LEVEL 1.5	60 PS	
LEVEL 1	20 PS	
SURFACE	70 PS	
TOTAL		245 PS


LOCKER COUNT PER LEVEL		
LEVEL	COUNT	
LEVEL 10	4	
LEVEL 9	8	
LEVEL 8	8	
LEVEL 7	8	
LEVEL 6	8	
LEVEL 5	8	
LEVEL 4	14	
LEVEL 3	5	
LEVEL 2	20	
LEVEL 1.5	49	
GROUND	-	
TOTAL		132
RATIO = 1 LOCKER / UNIT		



absolute-idea.com
CANAL PARK
3323 NE 163rd Street, Suite 200 North Miami Beach, FL 33160
T 305.792.0015 T 305.931.0279 @info@absolute-idea.com

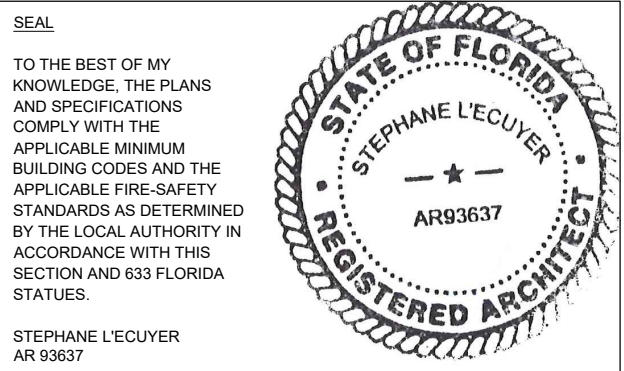


ISSUE FOR:
DRC SUBMITTAL

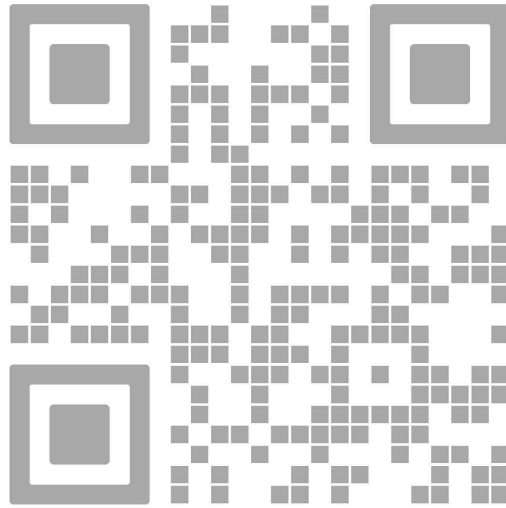

REV.	DATE	DESCRIPTION
01	01-29-2025	D.R.C. SUBMITTAL

ALL MEASUREMENTS MUST BE VERIFIED BEFORE BEGINNING THE WORK. NO MEASUREMENTS ARE TO BE SCALED DIRECTLY FROM THIS DRAWING.

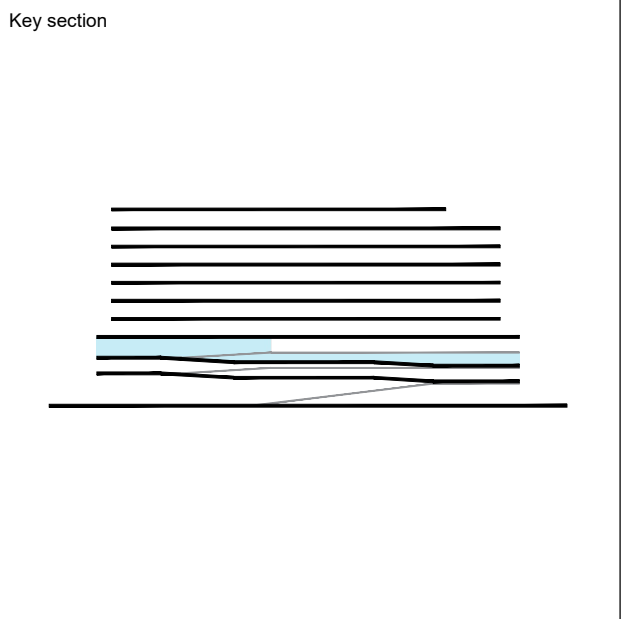

Client
VERA FUND
NICK POLYUSHKIN
& YURI KHARITONENKOV
TEL: 305.833.3303

Project
**1600 S FEDERAL HIGHWAY
(MIXED-USE PROJECT)**
1600 SOUTH FEDERAL HIGHWAY,
POMPAHO BEACH, FL 33062

LEVEL 02 FLOOR PLAN LAYOUT	
Drawn J. WU	Field ARCHITECTURE
Verified N. TREMBLAY	Scale as shown
Approved S. L'ECUYER	Date 03-12-2025
Project Manager J. WU	Dwg. no. A-202
Project 24-838	