## **Ocean Park**

1508 North Ocean Boulevard

# Rezoning Application to Planned Development - Infill (PD-I)

December 2017 Revised June 2019

Prepared by

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#### I. INTRODUCTION

Mount Vernon Property Holdings, LLC (the "property owner") owns a parcel of land located at 1508 North Ocean Boulevard, at the southeast corner State Road A1A and NE 16<sup>th</sup> Street, west of the City of Pompano Beach's North Ocean Park (See **Exhibit A** - Location Map). A survey of the property and its legal description are provided in **Exhibit B**.

The subject property is currently 0.62 net acres prior to anticipated right-of-way dedications and 0.86 gross acres. The property's Future Land Use designation is Residential High, which allows up to 46 dwelling units per acre (du/ac). The property's current zoning district is Residential Multi-Family (RM-45). The property owner proposes to rezone the property to Planned Development – Infill (PD-I) to allow a unique and innovative, mixed-use development on a smaller, infill property in a corridor that is appropriate for and can accommodate the requested development regulations. The building's conceptual design is architecturally significant and unique. The proposed development will include a mixed-use building with ground level commercial uses and multi-family residential units.

#### Mixed Use Design Concept

The design concept is a unique, innovative, and modern take on beach-side community living in Pompano Beach, and once constructed, is anticipated to serve as an iconic landmark in the City. The building will include a mix of ground floor commercial and multi-family residential uses. The first three (3) floors are anticipated to include parking and spaces for back of house activities as well as ground level commerce uses. On top of the pedestal, the design concept contemplates an amenity deck and two residential structures. The Applicant provided a conceptual site plan, elevations, and renderings with this PD-I package (Exhibit E). These documents demonstrate the Applicant's significant effort towards designing a building that can be constructed using the requested PD-I regulations; however, the drawings may be modified during the actual site plan approval process.

#### The Commercial Component

The City's PD-I regulations are intended to provide high-quality mixed-use development. To meet this intent, the PD-I proposes a range of neighborhood oriented commercial options that complement the community. The commercial spaces are intended primarily for the benefit of local residents and beach goers alike. The project abuts the City's North Ocean Park and the conceptual design seeks to develop a synergy between the park and the building. The building design will place the non-residential component on the ground floor so it can be accessed by the community and support the pedestrian environment and ground-level community interactions and activities. The conceptual building design places a commercial component along the east side of the property to maximize the interaction with the park. The project's commercial component is anticipated to include between 1,500 and 3,500 square feet of space. In the PD-I table, the Applicant requests the ability to create 5,000 square feet of commercial to add flexibility when finalizing the interior layout.

Justification: The existing RM-45 zoning district does allow limited commercial development on the site. The commercial component of the property is consistent important to the Applicant and is a primary driver of the rezoning request for the PD-I designation.

#### The Residential Component

In addition to the commercial component, the building will provide high quality, multi-family residential dwelling units. This PD-I application requests a density that will support 28 units on the

property. These units are anticipated to be designed in two (2) separate residential structures that sit atop the building pedestal. Each structure is anticipated to be 15 floors. Each floor is anticipated to contain a single dwelling unit except for the top floors that contain a two-story penthouse. The building's two off-set residential structures are designed to reduce the overall mass and provide adjacent properties with views and sunlight between the towers, a design which is advantageous compared with the alternative: a large, monolithic structure that would block views.

To allow 28 dwelling units on the property, the Applicant is requesting a density of 39 units per gross acre (46 units per acre per existing net acreage). The proposed gross density is less than the 45 units per acre permitted by the Comprehensive plan, which is the applicable limit for the PD-I district pursuant to Land Development Code Section 155.3607(C).

Justification: The existing RM-45 zoning district has a range of restrictions that would limit the ability to create innovative, unique, mixed-use development. The Applicant is proposing a density that allows this innovative development to occur.

#### **Dimensional Standards**

To achieve the desired building design and form, the PD-I document requests modifications to the dimensional standards, which is afforded by the Planned Development-Infill (PD-I) District. The proposed intensity and dimensional standards that will govern the site are outlined in **EXHIBIT C - PD TABLES**. The table also compares the proposed dimensional standards with the dimensional standards of the RM-45 district.

Justification: The PD-I district is intended to accommodate small-site, infill development within the city's already developed areas. The PD-I district is intended to provide the flexibility to enable high-quality, mixed-use development on relatively small sites. The Code requires that the Applicant establish PD-I standards through a PD plan (i.e. this document) pursuant to Section 155.3607(C). Therefore, the PD-I dimensional standards are provided to meet this requirement. The proposed PD-I dimensional standards will allow a development that is consistent with the conceptual building design and the mix of uses described within this application package. The existing RM-45 district does not allow high-quality, mixed-use development, and is not intended to accommodate development on smaller sites. This is evidenced by dimensional standards that a larger site could easily accommodate, but when applied to a small site, provide constraints that severely limit the development potential. The proposed dimensional standards will allow development to meet the intent of the code to provide the high-quality mixed-use development and to provide this development on a relatively small infill site. In addition to an improved pedestrian experience and enhanced interface between the building and the park, the Applicant proposes to implement improvements and materials that will reduce the property's environmental impacts including: Rain water collection for irrigation and other non-potable water uses, drought tolerant landscaping, on-site water treatment and storage, and pervious hardscape.

#### Public Experience – Parking Improvements

The proposed building will enhance and greatly improve the overall public experience and the pedestrian experience surrounding the property. To enhance the overall public experience, the Applicant proposes more public parking spaces, which is greatly needed in this area. These spaces are anticipated to be located both inside the site (i.e. in the parking garage) and on the street in locations where no public parking currently exists. The on-street parking is anticipated to be located partially on the subject property and partially in the 16<sup>th</sup> Street right-of-way and the Applicant will partner with the City to dedicate required easements for this on-street parking. The extra parking will help alleviate the parking problems identified by adjacent property owners during the community meetings. The public parking mentioned above is provided in addition to the

parking required for building residents.

#### Public Experience – Pedestrian Improvements

When the Applicant prepares the site plan application, the landscape plan will include significant landscape improvements beyond those that currently exist on the property. The details of this landscape plan is a required component of and will be submitted with the site plan application. Landscape improvements will include a landscaping component, a hardscaping component, and the Applicant is considering a water feature. These improvements will improve pedestrian walkability from A1A to North Ocean Park and the beach. The Applicant is also proposing to improve the interface between the building and the park by providing ground level commercial space abutting the park on the east side of the building. In addition to on-site improvements, the Applicant has volunteered to provide a developer's agreement to help the City make improvements to North Ocean Park.

#### Public Experience - Landscaping

The landscape components for the project will consist of a mix of hardscape and planting areas. The layout will include large planters within the paving to provide canopy trees and palms for softening and shading of the architectural elements. A suspended paving system will be incorporated to allow for planting of canopy trees within the plaza areas. Foundation and streetscape planting will be designed per landscape guidelines. The character will be in keeping with the conceptual rendered illustrative plan attached to this submittal (Exhibit D).

#### <u>Public Experience – Park Improvements</u>

The Applicant's vision is to maximize the connection between the building and the park by providing commercial space on the east side of the building adjacent to the park. The Applicant has drafted and submitted a developer agreement to the City to commit resources to the City to fund park improvements.

#### **CPTED**

The building's east tower overlooks North Ocean Park. This helps achieve a crime prevention through environmental design (CPTED) principle of 'eyes on the street', which can improve safety in the park. Pedestrian improvements will also advance CPTED principles.

#### Purpose of this Document

This PD-I document is intended to satisfy the submittal requirements of Pompano Beach's Land Development Codes, particularly Sections:

- 155.2405 Planned Development
- 155.3602 General Standards for all Planned Development Districts
- 155.3607 Planned Development Infill (PD-I)

This document outlines the code requirements and the project team's proposal for meeting these requirements. This application package, which includes plans and graphics, demonstrates that the proposed project is consistent with the purpose of the Planned Development Districts in general, and the Planned Development – Infill (PD-I) District specifically.

## II. GENERAL STANDARDS FOR PLANNED DEVELOPMENT DISTRICT

This section responds to each of the requirements outlined in Section 155.3602 – *General Standards for All Planned Development Districts* of the Pompano Land Development Code.

#### A. PD Plan

1. A Statement of Planning Objectives for the District

The Planned Development – Infill (PD-I) District is intended to accommodate and enable high-quality, mixed-use development on small, infill sites in developed areas of the City. To do this, the district allows applicants to provide their own standards; standards that must be consistent with the City's existing plans and compatible with surrounding properties. PD-I Districts are generally appropriate in most of the Land Use Plan's land use classifications, as long as proposed development is consistent with the City's Goals, Objectives and Policies.

#### Parcel Size Limitations

The project team seeks to rezone the Ocean Park property to the Planned Development – Infill (PD-I) zoning district for several reasons, but one principal motive is to compensate for the small parcel size, which constrains development options. The Ocean Park site is only 100 feet wide, which severely limits the development on the site, particularly development that uses the site's existing zoning district – Residential Medium (RM-45). The small lot size is further exacerbated by the City's requirement for additional right-of-way dedication along SR A1A in lieu of a right-of-way easement. The dimensional and development standards proposed in this rezoning to the PD-I district are needed to implement a development program consistent with the proposed documents in this application package.

The initial site design clearly demonstrated that the RM-45 zoning district's conventional setback requirements, which are appropriate for larger properties, would create a building that few would desire and, therefore, would not likely be feasible to build. This initial design included a parking garage that would cover most of the site and left no additional space for amenities. Since the initial design was not feasible, the project team determined that the PD-I zoning district's flexible, design-oriented standards could provide a solution. This application package proposes design parameters that allow an appealing and feasible innovative design within the constrained site boundaries.

The City's Development Review Committee, which reviewed the proposal, commented on areas where the site is constrained, which is why the site is appropriate for infill development using the PD-I zoning category. The RM-45 zoning designation is not the most appropriate zoning designation for the site. Previous projects have been proposed on this site in 2002, 2006 and 2010. All requests required adjustments to the City zoning standards and one required variances. None of those projects moved forward to construction. These DRC comments along with the properties proposed development history help explain why the city's proposed rezoning to the PD-I zoning district is consistent with infill redevelopment on sites such as Ocean Park is the applicable standards.

While not explicitly stated, the PD-I District represents a form of public-private partnership. The

district allows smaller, infill properties greater flexibility and relief from a zoning designation that limits redevelopment opportunities.

#### 2. Detailed Description of PD Plan

All Dimensional Standards including land area, types and mix of land uses, maximum number of units, lot area, lot width, maximum impervious area, maximum height, and setbacks as well as a comparison to the requirements found in the RM-45 district are found in **EXHIBIT C**. The proposed standards are necessary to develop an innovative, high quality, mixed-use development on a small, infill site.

a) Modifications of Development Standards;

The project anticipates the need for modifications of development standards that relate to a reduction of the minimum vehicle stacking requirements before the first conflict point, although the Applicant believes the stacking requirement should not be applied to parking garages. The PD-I also requests modification to landscape requirements that will allow the flexibility to create innovative, mixed-use development on a small, infill property. Justifications for these modifications are provided in **Exhibit C - PD Tables**.

- b) Provisions addressing how transportation, potable water, wastewater, stormwater management, and other public facilities will be provided to accommodate the proposed development;
  - Transportation Residents and guests will access a parking garage along NE 16<sup>th</sup> Street. Pedestrians can access the building via sidewalks along SR A1A and NE 16<sup>th</sup> Street. Bicycle riding residents and guests can access the building via a bike lane or sidewalk on A1A and a sidewalk along NE 16<sup>th</sup> Street or the NE 16<sup>th</sup> Street right-ofway itself.
  - **Potable Water** The property is served by the City of Pompano Beach's municipal potable water system. Adequate potable water service is available and service availability letters will be obtained at the time of platting.
  - **Wastewater** The property is served by the Broward County's municipal wastewater system. Adequate wasterwater service is available and service availability letters will be obtained at the time of platting.
  - Stormwater The project will be designed to store all on-site stormwater treatment.
  - Other public facilities: Parking All parking required for the project will be provided within the parking garage. The proposed project includes additional public parking on NE 16<sup>th</sup> Street which can alleviate some of the parking problems that visitors and nearby residents have experienced. The proposed parking redesign on NE 16<sup>th</sup> Street will include parallel and perpendicular parking on the south side of the street. To accommodate this parking the property owner anticipates providing a 5-foot right-of-way easement along the north property line for the portion of the parking areas on the subject property.

- Other factors: Environmental Components The building is incorporating the following sustainable design elements to further support the environment:
- Solar electric
- Lighting power density below 0.8 watts per square foot
- Energy Star appliances in common areas as well as individual units
- High efficiency washers
- Compact hot water distribution in units w/ insulated pipes
- Low flow toilets, shower heads, and kitchen facets
- High density promotes sustainability
- Bicycle storage
- Preferred parking for low-emission vehicles
- Electric charging stations for electric cars

- 100% drought tolerant landscaping
- Rain water collection for irrigation and non-potable uses
- Energy Star roof with high reflectivity
- Shaded, covered hardscape
- Pervious hardscape/pavers
- 100% covered parking
- Treat and store 100% water runoff onsite
- Low VOC ceiling and paints
- Recycled content finishes
- Used certified wood
- Construction waste recycling
- Maximize regional materials
- Impact resistant facade
- Low maintenance, resilient finishes

#### c) Provisions related to environmental protection and monitoring;

The proposed project is not located in an environmentally sensitive area. The project site was previously developed, and the previous development has been demolished. The site is currently cleared and vegetated primarily with grass. The site is located near the beach, which is nesting turtle habitat. The development will incorporate exterior lights that are shielded from the ocean, suitable for use near turtle habitat. The property will be managed to minimize light from the building during turtle nesting season.

d) Identification of community benefits and amenities that will be provided to compensate for the added development flexibility afforded by the PD district;

The project proposes benefits, amenities, and improvements that help compensate for additional development flexibility. These improvements include park improvements and additional public parking which will be metered by the City.

- 1. North Ocean Park Improvements Although North Ocean Park is not part of the project, the project team is available to work with the City to make improvements to the park. The Applicant voluntarily provided a developer's agreement to the City to demonstrate their commitment to fund park improvements. The project team plans to work with the City and the surrounding community to determine which improvements to implement.
- 2. **Additional Public Parking** As mentioned above, the proposed project includes additional public parking, which can alleviate some of the parking problems that visitors and nearby residents experience.

#### e) Development Phasing Plan;

The project team anticipates completing the entire project in one phase.

#### f) Conversion Schedule

The proposed project does not require conversions between uses.

g) Any other provisions the City Commission determines are relevant and necessary to the development of the planned development in accordance with applicable standards and regulations.

The proposed rezoning amendment helps facilitate improvements that benefit the City. The Applicant plans to attend the hearing before the City Commission.

- 3. General Location of Project Components
- a. Individual development areas, identified by land use(s) and/or development density or intensity;

Since the site is constrained, the project designers maximized the development on the site. The entire property has a proposed density of 39 dwelling units per gross acre. A conceptual site plan that could be developed utilizing the requested PD-I density and intensity standards is provided in **Exhibit E, Sheet A1-101.** 

b. Open space (whether designated for active or passive recreation), including amount, and type of;

The site's open space area that includes landscape and hardscape is anticipated to be 30 percent or more. This includes the area surrounding the building and passive recreation areas in connection with the adjacent Ocean Park to the east. A conceptual site plan that could be developed utilizing the requested PD-I density and intensity standards is provided in **Exhibit E, Sheet A1-101.** 

c. All public and private streets, existing or projected transit corridors, and pedestrian and bicycle pathways, and how they will connect with existing and planned city systems;

**Exhibit C, Sheet PD-1** is a master plan bubble map showing the general locations of buildings, bicycle and pedestrian circulation patterns. Bicyclists and pedestrians can access the building from a bike path and sidewalk along A1A. Broward County Transit operates one bus route in the area: route 11. This route operates on A1A, south of 14<sup>th</sup> Street. The project team has met with the Florida Department of Transportation to establish access to the property in a pre-application meeting. The proposed driveway is located approximately 100 feet from A1A, which exceeds FDOT's required setback of 50 feet.

d. Environmentally sensitive lands, wildlife habitat, wetlands, and floodplains;

The subject property does not contain any environmentally sensitive land, wildlife habitat, or wetlands. The property is within AE and VE flood zones. These flood zones are shown on the survey, **Exhibit B**.

e. On-site potable water and wastewater facilities, and how they will connect to city systems;

The bubble map on **Exhibit C, Sheet PD-1**, shows the general location of existing utilities along A1A. The building will connect with municipal water and wastewater systems along A1A.

f. On-site stormwater management facilities, and how they will connect to city systems; and

The site plan submitted for approval will include a variety of stormwater management techniques including the following appropriately designed and sited systems and features:

- Rain water collection for irrigation and other non-potable water uses
- 100% drought tolerant landscaping
- 100% on-site water treatment and storage
- Pervious hardscape
- g. All other on-site public facilities serving the development, including but not limited to parks, schools, and facilities for fire protection, police protection, EMS, stormwater management, and solid waste management.
  - The proposed project includes necessary facilities to serve the development including solid waste management, fire protection, and stormwater management.
  - Parks Although the proposed development plan does not include any on-site parks, North Ocean Park is the closest City park to the property. The Applicant has prepared a developer's agreement that would commit resources to fund park improvements.
  - 4. Graphics demonstrating the following:
- a. Projects with structures greater than 35 feet in height, the shadowing on adjacent properties at the following times: two hours after sunrise, noon, and two hours before sunset during the winter solstice, spring equinox, summer solstice, and fall equinox.

The shadow analysis is provided in **Exhibit F**.

b. The impacts to view corridors of any adjacent properties of natural resources, including but not limited to, beaches, shores, waterways, recreation spaces and conservation spaces.

Ocean Park Residence's is designed to preserve the view sheds of adjacent properties. While a conventional building could allow over 100 feet of monolithic building, the proposed building is designed with only four floors of unbroken building pedestal, and then two towers with a break in the building design, which provides a view shed through the building. **Exhibit G** shows the view shed from adjacent properties looking north, west and south.

#### B. Consistency with City Plans

PD-I Districts are generally appropriate in most of the Land Use Plan's land use classifications, consistent with the adopted objectives and policies for the classification. This PD-I application is appropriate in the proposed location and is consistent with the City's adopted objectives and policies. Attached to this document in **Exhibit H** is a list of comprehensive plan policies that apply

to this project and narrative describing how the project meets, achieves, or exceeds each of the policies.

#### C. Compatibility with Surrounding Areas

Development along the perimeter of a PD district shall be compatible with adjacent existing or proposed development. The Florida Statutes define compatibility as: "a condition in which land uses or conditions can coexist in relative proximity to each other in a stable fashion over time such that no use or condition is unduly negatively impacted directly or indirectly by another use or condition." The City of Pompano Beach indicates that compatibility is evaluated by reviewing complementary character, where character is based on the seven (7) items listed below. The project team provides a narrative below each characteristic that describes how the project achieves a character that is compatible with adjacent properties:

#### 1. Densities/intensities

The project is not proposing an increase in the future land use map and underlying density.

#### 2. Lot size and dimensions

The project site is smaller than other sites in the area. The small site is not inconsistent with the sites in the surrounding neighborhood.

#### 3. Building height

The PD-I zoning district does not limit an applicant to a building height. The proposed building has a zoning height of 205'-6", which is higher than others in the area. However, the adjacent property to the north is the within the RM-45 HR zoning overlay designation that allows unlimited building heights. The Ocean Park development allows an ordered transition in building heights between existing development and future development on that site as shown on **EXHIBIT I - Height Map**. In addition, the building massing reduces the visual impact of the building height because it is less massive or bulky than a building that could be approved with the existing zoning district. The proposed building design includes two offset towers, which allows views through the buildings. The existing RM-45 zoning district could allow a relatively high building that does not provide views through it. Additionally, the innovative building design prevents complete shading of pools on adjacent properties. See **Exhibit F** for Shadow Study analysis.

#### Staff Analysis

City staff has indicated that the A1A corridor allows for high rise development and a building of the proposed height could be considered compatible. (Planning and Zoning Staff Report presented at the February 20, 2017 Planning and Zoning Board Meeting)

#### 4. Building mass and scale

Stated previously, the building massing includes a parking pedestal and two off-set residential components. The building massing is not inconsistent with the corridor or the of surrounding properties and their development potential. The massing is a unique and modern approach to building design that provides viewshed benefits for surround property owners versus a typical, monolithic structure. It also benefits the community at large,

because it will be distinctive and recognized.

#### 5. Hours of operation

While the building is mixed use, the primary use is residential. The commercial component is anticipated to be open under normal operating hours.

#### 6. Exterior lighting

Exterior building lighting will include partially or fully shielded fixtures in areas visible by the beach to protect nesting sea turtles. Other exterior lighting will be provided to illuminate walkways, entryways and other areas where lighting is necessary for safety or convenience.

#### 7. Siting of service areas

Service areas are proposed within the parking garage on floors one (1) through three (3) and are fully contained within the building. The project team does not anticipate adverse impacts resulting from these service areas.

#### 8. Other Factors – Parcel Location

On the adjacent parcel to the north are three buildings. Two of these buildings are separated from this property by a parking lot. The other building is located adjacent to the park. This mitigates some of the building's visual impact for these neighbors versus a scenario where the building was sited directly adjacent to neighboring buildings.

#### 9. Other Factors - Relationship to North Ocean Park and A1A

The following bullets and bolded text list staff comments about the site, the building, and the commercial component and their relationship to the park and A1A. The text that follows each bullet addresses the comment.

• Staff opined "that the project is not compatible due to lack of mitigation of the site, specifically the relationship to the neighboring properties at the ground level."

The Applicant revised the proposal to include a commercial component that runs the length of the east side of the building and will maximize the interface between the building and the park. This space will be open to the public and will likely activate the park. Additionally, the Applicant is providing sidewalks to increase pedestrian accessibility to the park from adjacent properties.

• Staff commented that the proposed development does not "relate to" the adjacent park, which could result in a missed opportunity.

The Applicant revised the proposal to include a commercial component that runs the length of the east side of the building. This space will be open to the public and will likely activate the park. Additionally, the Applicant is providing sidewalks to increase pedestrian accessibility to the park from adjacent properties.

 Staff commented that the site has no active open spaces, "community benefits or public neighboring properties." The property does have active, open spaces, which are located on the fourth floor. This area, which is available to residents and guests, contains a variety of amenities, including a pool. This open space is likely to alleviate public pressure on the park.

The project will include community benefits through increased public parking, which neighbors identified as a major issue. Additionally, the project team has volunteered to make improvements to the park.

• Staff commented that the proposed layout of the ground floor, with back of house activities sited next to the park, could create a potentially unsafe environment.

The Applicant revised the site design to place the commercial component along the east side of the building, next to the park. With increased activity, more eyes on the street could be expected to increase the area's safety.

 Staff indicated that the proposal has proposed enhancements to the park, but a specific plan has not been included or proffered.

The list of improvements will be partially based on community input and partially derived from our project team's City Studio. Additionally, the Applicant will work with the City to determine its vision for park improvements. The project team met with community members to discuss their desires for improving the park. The Applicant has provided a developer agreement to the City for park improvements.

#### D. Development Phasing Plan

The development will be completed in one phase.

#### E. Conversion Schedule

The development does not propose converting uses.

#### F. On-Site Public Facilities

The development proposes to add public parking spaces on the property and provide an easement to the City for the portion of these spaces located on the property. The property owner will dedicate all required public rights-of-way, access, and/or utility easements via the platting process and/or separate instrument. Utility easements will be provided for the utility companies. The property will be served by City of Pompano Beach Police and Fire/EMS. The site will comply with all required storm water regulations. The site plan documents will include storm water management details. The project team is coordinating solid waste service with the provider. The provider will access the dumpster on the first floor of the garage. The dumpster will not be visible from the street. Both the City and County will complete a concurrency review as part of the platting process. This process will require coordination with the school board regarding student generation.

#### G. Uses

The proposed development includes residential, commercial, and office uses. The complete list of proposed uses is shown on **Exhibit C – PD Tables**, **Permitted and Accessory Use Table**. Each of these uses is a permitted use in the PD-I zoning district as listed in the City's Appendix A: Consolidated Use Table.

#### H. Densities/Intensities

The proposed density and intensity is permitted within the existing future Residential-High (25-46 du/ac) future land use designation. The proposed density is provided in the Exhibit C – PD Tables.

#### I. Dimensional Standards

The dimensional standards are described in this document and outlined in **Exhibit C – PD Tables**, **Table C. Intensity and Dimensional Standards**. The FAA has determined that the proposed project does not interfere with airport operations. The property will be requesting the granting of an obstruction permit from the Airport Overlay District during the site plan approval process (see **Exhibit K**).

#### J. Development Standards

The proposed development will follow the development standards outlined in Section 155.3607(D) and Article 5 of the Pompano Beach Zoning Code, except for the specific deviations presented in the PD-I Plan **EXHIBIT C - PD Tables, Deviations**.


#### K. Amendments to Approved PD Plan

Amendments to the approved PD-I will be in accordance with the standards in Section 155.2405.J, Minor Deviations from the approved PD Plan and Section 155.2405.K, Amendment of the Development Order.

## **III.PLANNED DEVELOPMENT-INFILL (PD-I)**


This PD document as well as all of the attached exhibits are hereby incorporated as the Planned Development-Infill (PD-I) regulations for the Ocean Park – 1508 North Ocean Boulevard project.

## **EXHIBIT A**

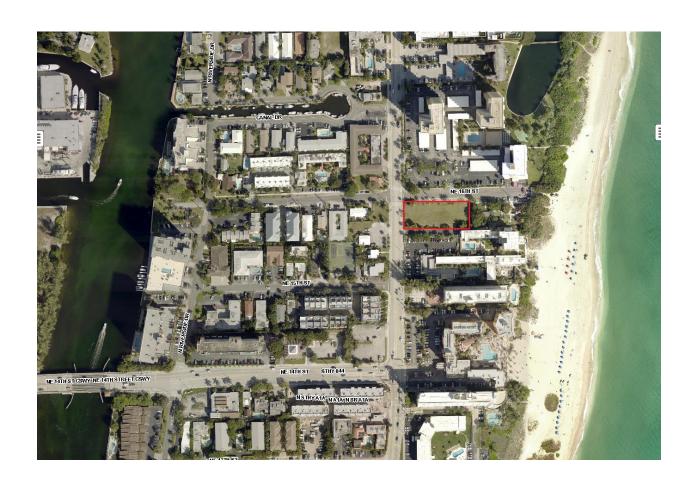

**Location Map** 

## **EXHIBIT B**

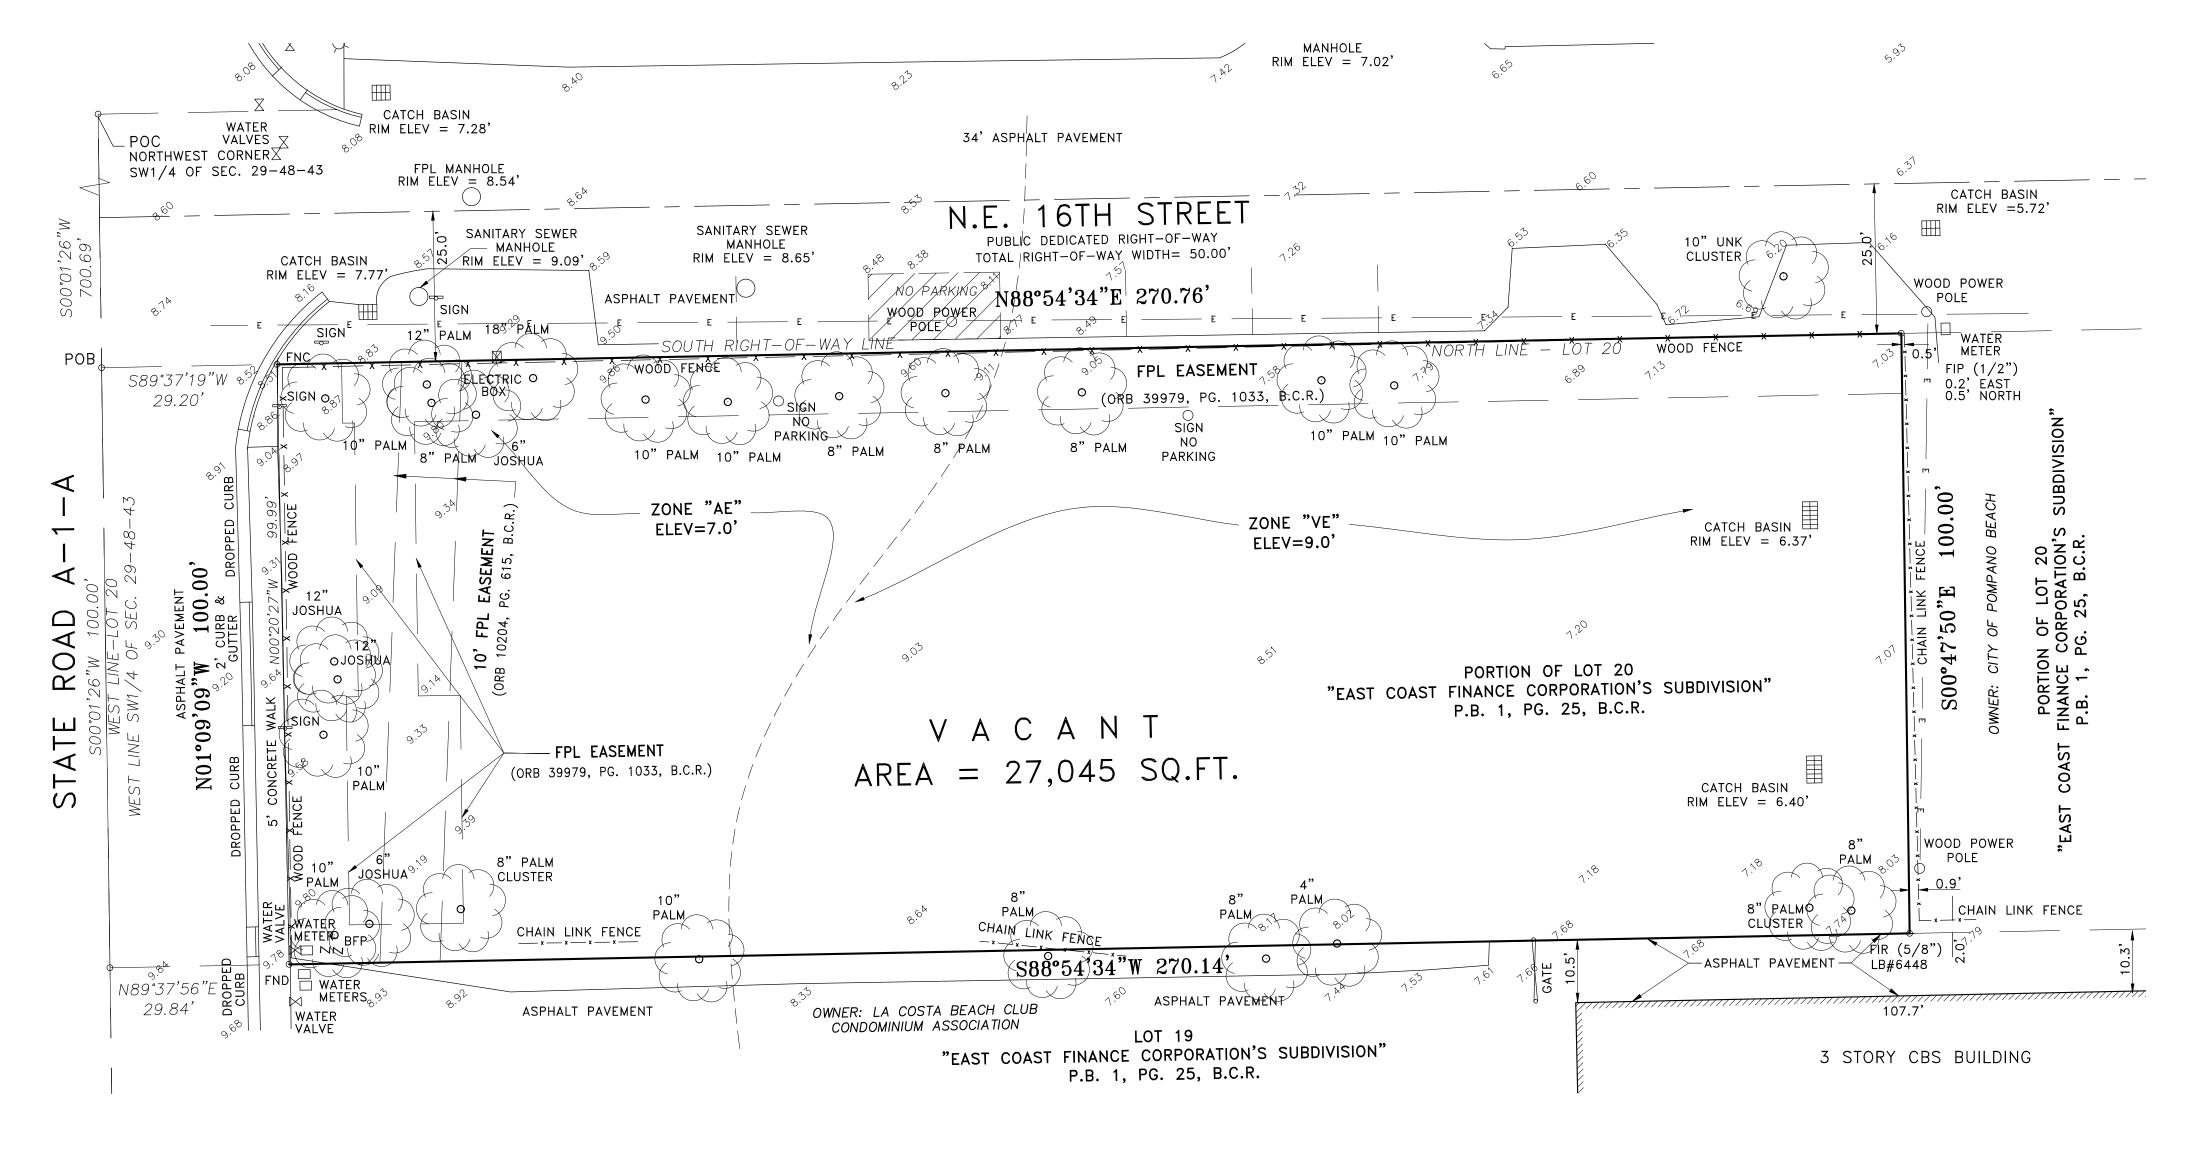

LEGEND:

CHECKED BY CONC CONCRETE DRAWN BY

FIELD BOOK AND PAGE SET 5/8" IRON ROD

& CAP #6448 SET NAIL AND CAP #6448 FOUND IRON ROD

FOUND IRON PIPE FOUND NAIL AND CAP FOUND NAIL & DISC WPP WOOD POWER POLE

P.B. PLAT BOOK CHAIN LINK (CLF)/WOOD FENCE -X-CBS CONCRETE BLOCK STRUCTURE

AIR CONDITIONER A/C BROWARD COUNTY RECORDS BACK FLOW PREVENTER RADIUS

DELTA ANGLE ARC DISTANCE CONCRETE LIGHT POLE CLP FIRE HYDRANT WATER METER

WV

FOV FIBER OPTIC VAULT FIBER OPTIC MARKER FOM ELEVATIONS OVERHEAD UTILITY LINES

WATER VALVE

CO CLEAN OUT GAS METER

NON-VEHICULAR ACCESS LINE  $\mathsf{PRM}$ PERMANENT REFERENCE MONUMENT AMERICAN LAND TITLE ASSOCIATION ALTA

AMERICAN CONGRESS ON SURVEYING & MAPPING ACSM OFFICIAL RECORDS BOOK

ORB EΒ ELECTRIC BOX TYP TYPICAL

GATE CONTROL DOUBLE DETECTOR CHECK VALVE TITLE COMMITMENT REVIEW: (SHEDULE B-II)

ITEM # 9 - RESTRICTIONS, DEDICATIONS, CONDITIONS, RESERVATIONS, EASEMENTS AND OTHER MATTERS PER P.B. 1, PG. 25. (AFFECTS/PLOTTED)

ITEM #10 - EASEMENT PER ORB 10204, PG. 615. (AFFECTS/PLOTTED)

ITEM #11 - REVOCABLE LICENSE AGREEMENT PER ORB 23468, PG. 953. (AFFECTS/NOT PLOTTABLE)

ITEM #12 - AGREEMENT PER ORB 24869, PG. 45. (AFFECTS/NOT PLOTTABLE) ITEM #13 - EASEMENT PER ORB 39979, PG. 1033. (AFFECTS/PLOTTED)


ALL OF THE PUBLIC RECORDS OF BROWARD COUNTY, FLORIDA.


LAND DESCRIPTION:


THE WEST 300 FEET OF LOT 20 OF THE "EAST COAST FINANCE CORPORATION'S SUBDIVISION OF GOVERNMENT LOT 3", ACCORDING TO THE PLAT THEREOF, AS RECORDED IN PLAT BOOK 1, PAGE 25, OF THE PUBLIC RECORDS OF BROWARD COUNTY, FLORIDA, IN THE SOUTHWEST QUARTER (SW1/4) OF SECTION 29, TOWNSHIP 48 SOUTH, RANGE 43 EAST.

LESS THE FOLLOWING:

COMMENCE AT NORTHWEST CORNER OF THE SOUTHWEST QUARTER (SW1/4) OF SAID SECTION 29; THENCE ON AN ASSUMED BEARING, SOUTH 00°01'26" WEST ALONG THE WEST LINE OF THE SOUTHWEST QUARTER (SW1/4) OF SAID SECTION 29, A DISTANCE OF 700.69 FEET TO THE POINT OF BEGINNING; THENCE CONTINUE SOUTH 00°01'26"WEST ALONG THE WEST LINE OF THE SOUTHWEST QUARTER (SW1/4) A DISTANCE OF 100.00 FEET; THENCE NORTH 89°37'56" EAST A DISTANCE OF 29.84 FEET; THENCE NORTH 00°20'27" WEST A DISTANCE OF 99.99 FEET TO A POINT ON THE NORTH LINE OF SAID LOT 20, SAID LINE ALSO BEING THE EXISTING SOUTH R/W LINE OF N.E. 16TH STREET; THENCE SOUTH 89°37'19" WEST A DISTANCE OF 29.20 FEET TO THE POINT OF BEGINNING.

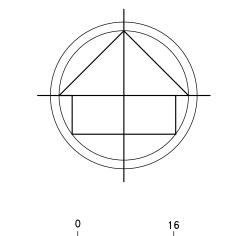

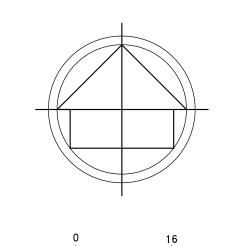


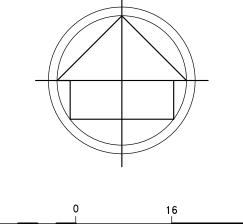

120055

0189 H

08/18/14

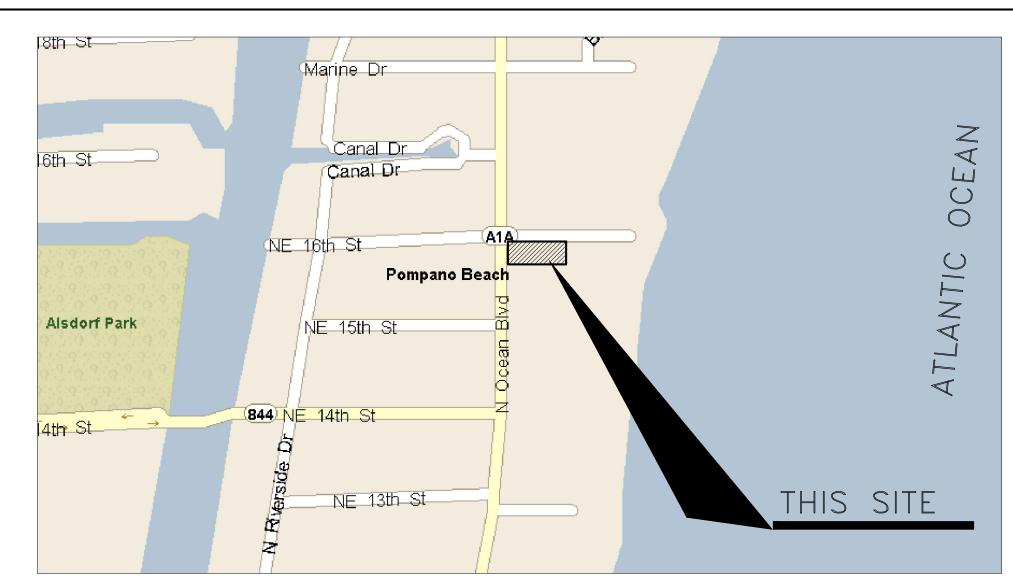

LOCATION MAP (NTS)

#### NOTES:

- 1. NOT VALID WITHOUT THE SIGNATURE AND THE ORIGINAL RAISED SEAL OF A FLORIDA LICENSED SURVEYOR AND MAPPER.
- 2. THE CERTIFICATION SHOWN HEREON TO THE EXTENT RELATING TO THE EXISTENCE OF EASEMENTS AND/OR RIGHTS-OF-WAY OF RECORD IS BASED UPON COMMITMENT FOR TITLE INSURANCE ISSUED BY FIRST AMERICAN TITLE INSURANCE COMPANY, EFFECTIVE DATE: NOVEMBER 07, 2014. (FILE NUMBER: 1062-3262735)
- 3. THIS SURVEY WAS DONE SOLELY FOR BOUNDARY PURPOSES AND DOES NOT DEPICT THE JURISDICTION OF ANY MUNICIPAL, STATE, FEDERAL OR OTHER ENTITIES.
- 4. THE LAND DESCRIPTION SHOWN HEREON WAS PROVIDED BY THE CLIENT.
- 5. UNDERGROUND IMPROVEMENTS NOT SHOWN.
- 6. ELEVATIONS SHOWN HEREON ARE BASED ON THE NORTH AMERICAN VERTICAL DATUM OF 1988.
- 7. BENCHMARK REFERENCE : BROWARD COUNTY BENCHMARK # 1923 ELEVATION=1.81' (NAVD88)
- 8. BEARINGS SHOWN HEREON ARE BASED ON THE DEED.
- 9. ZONING: RM-45 MULTIPLE-FAMILY RESIDENCE
- 10. SET BACKS REQUIREMENTS:

MAXIMUM BUILDING HEIGHT: 105 FEET FRONT YARD MINIMUM: 25 FEET STREET SIDE YARD MINIMUM: 10 FEET WATERWAY OR CANAL MINIMUM: 25 FEET DUNE VEGETATION LINE MINIMUM: 25 FEET INTERIOR SIDE YARD MINIMUM: 10 FEET REAR YARD MINIMUM: 10 FEET SPACING BETWEEN PRINCIPAL STRUCTURES MINIMUM: 25 FEET

SURVEYOR'S CERTIFICATION

110.4188

STATE OF

KONIO P.

THAT (A) THIS SURVEY WAS PREPARED UNDER MY SUPERVISION; (B) THE LEGAL DESCRIPTION OF THE PROPERTY AS SET FORTH HEREIN, AND THE LOCATION OF ALL IMPROVEMENTS, FENCES, EASEMENTS, ROADWAYS, RIGHTS OF WAY AND SETBACK LINES WHICH ARE EITHER VISIBLE OR OF RECORD IN BROWARD COUNTY, FLORIDA (ACCORDING TO TITLE COMMITMENT; (FILE NUMBER: 1062-3262735), EFFECTIVE DATE: NOVEMBER 07, 2014.), ARE ACCURATELY REFLECTED HEREON; AND (C) THIS SURVEY ACCURATELY DEPICTS THE STATE OF FACTS AS THEY APPEAR ON THE GROUND. THIS MAP AND THE SURVEY ON WHICH IT IS BASED WERE MADE IN ACCORDANCE WITH "MINIMUM STANDARD DETAIL REQUIREMENTS FOR ALTA/ACSM LAND TITLE SURVEYS," JOINTLY ESTABLISHED AND ADOPTED BY THE AMERICAN LAND TITLE ASSOCIATION ("ALTA"), THE AMERICAN CONGRESS ON SURVEYING AND MAPPING ("ACSM") AND THE NATIONAL SOCIETY OF PROFESSIONAL SURVEYORS ("NSPS") IN 2011, AND INCLUDES ITEMS 1, 2, 3, 4, 6(A), 7(A), 7(B)(1), 7(C), 8, 9, 11 (A), 13, 14, 16, 17 AND 18 OF TABLE A THEREOF. PURSUANT TO THE ACCURACY STANDARDS AS ADOPTED BY ALTA, NSPS, AND ACSM AND IN EFFECT ON THE DATE OF THIS CERTIFICATION, THE UNDERSIGNED FURTHER CERTIFIES THAT:

\_\_ THE SURVEY MEASUREMENTS WERE MADE IN ACCORDANCE WITH THE "MINIMUM ANGLE, DISTANCE, AND CLOSURE REQUIREMENTS FOR SURVEY MEASUREMENTS WHICH CONTROL LAND BOUNDARIES FOR ALTA/ACSM LAND TITLE SURVEYS"

DATED: 10/31/16 FOR THE FIRM BY:

RICHARD E. COUSINS PROFESSIONAL SURVEYOR AND MAPPER FLORIDA REGISTRATION No. 4188.

## COUSINS SURVEYORS & ASSOCIATES, INC. 3921 SW 47TH AVENUE, SUITE 1011

DAVIE, FLORIDA 33314 CERTIFICATE OF AUTHORIZATION: LB # 6448 PHONE (954) 689-7766 FAX (954) 689-7799 ITECDESIGN

CLIENT :

1508 NORTH OCEAN BOULEVARD POMPANO BEACH, FLORIDA 33062

ALTA/ACSM LAND TITLE SURVEY

flood zone information

COMMUNITY NUMBER

BASE FLOOD ELEVATION

BASE FLOOD ELEVATION

EFFECTIVE DATE

PANEL NUMBER


ZONE

ZONE

REVISIONS	DATE	FB/PG	DWN	CKD
BOUNDARY & TOPOGRAPHIC SURVEY	07/06/12	DATA/COLL	AV	REC
UPDATE SURVEY	09/13/12	SKETCH	AV	REC
ADDED CERTIFIED TO	09/14/12		AV	REC
ALTA/ACSM LAND TITLE SURVEY	12/10/14	SKETCH	JD	REC
UPDATE SURVEY	10/31/16	SKETCH	REC	REC

PROJECT NO: 6833-12

SCALE: 1" = 16

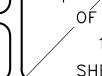

SHEET



## **EXHIBIT C**

LEGEND:

WATER SERVICE

SANITARY SEWER SERVICE

LANDSCAPE, HARDSCAPE, AND PEDESTRIAN ACTIVITY ZONE

GROUND FLOOR RETAIL

PARKING GARAGE / PODIUM

LOBBY

BACK OF HOUSE

VEHICLE CIRCULATION / ACCESS

**ACTIVITY NODE** 



BICYCLE / PEDESTRIAN CIRCULATION

PROPERTY LINE



**VICINITY MAP** (NOT TO SCALE)

SHEET IDENTIFICATION PD-1


PRELIMINARY PLAN
NOT FOR CONSTRUCTION
THESE PLANS ARE NOT FULLY PERMITTED

FROM ALL AGENCIES HAVING JURISDICTION OVER THE PROJECT WILL FALL SOLELY
UPON THE USER

PROJECT NO. 09520.00

ADJACENT LAND ZONING: RM-45-HR LAND USE: RESIDENTIAL HIGH (H) **NE 16TH STREET** ON-STREET PARKING LOBBY LOBBY ADJACENT LAND #1 ZONING: RM-45 LAND USE: OCEAN BLVD **GROUND LEVEL** RECREATION OPEN SPACE (OR) RETAIL #2 **PARKING** RETAIL #1 GARAGE BACK OF HOUSE **ADJACENT LAND** ZONING: RM-45 LAND USE: RESIDENTIAL HIGH (H) **GROUND LEVEL:** 

ADJACENT LAND ZONING: RM-20 LAND USE: RESIDENTIAL MEDIUM HIGH (MH)

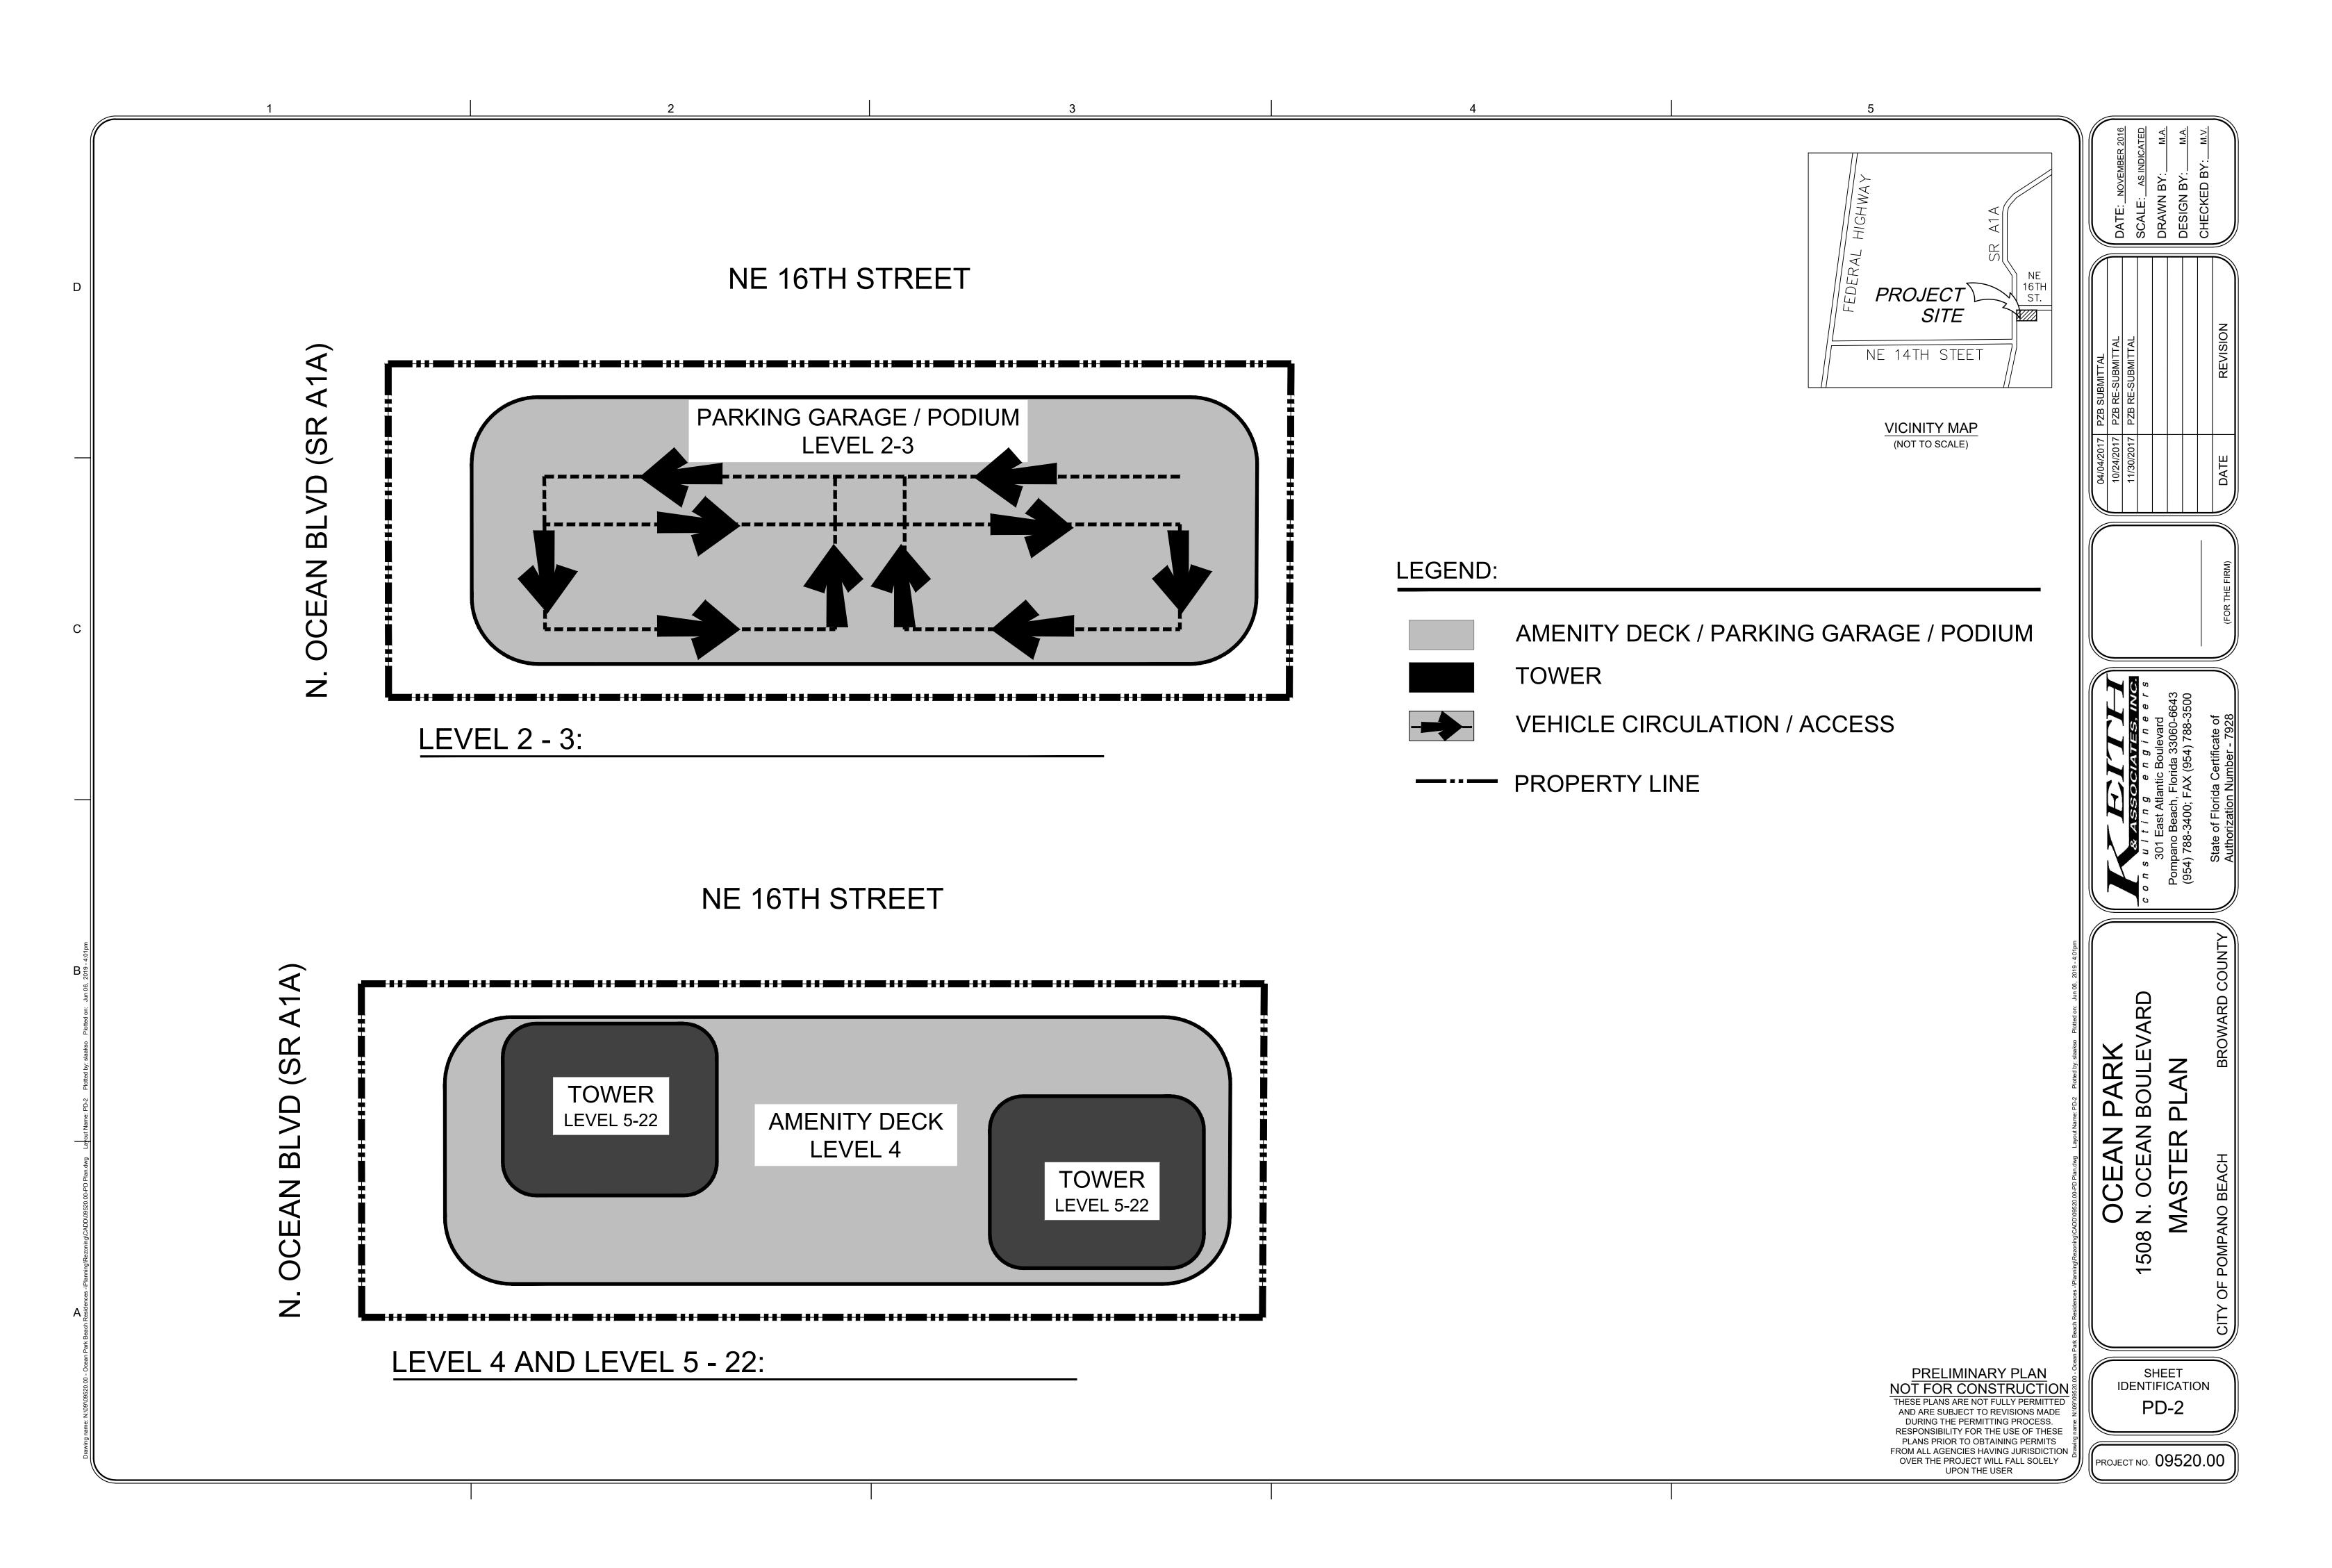

DIFFERENCE BETWEEN RM-45 DISTRICTS<sup>4,5</sup> District Area Minimum GROSS 0.86 N/A N/A NET  $0.597^{6}$ N/A N/A Lot area, minimum (sq ft) 26,045<sup>6</sup> Lot width, minimum (ft) 75 75 0 28 du<sup>7</sup> 26 du<sup>8</sup> N/A Density, maximum 1,500/5000 Commercial Uses minimum/maximum (sq ft) N/A N/A Lot coverage, maximum (% of lot area) +5% Pervious area, minimum (% of lot area) Ground Level 5% 25% -20%  $105^{2}$ +100.5<sup>2</sup> Height, maximum - Zoning (ft) 205'-6" <sup>2</sup> 226 <sup>2</sup>  $N/A^2$ None<sup>2</sup> Height, maximum - FAA/APO (ft) Individual Building size maximum (sq ft) 156,000 N/A N/A Podium\* (0' to 20') Podium\* (20' to 35') Front yard setback, minimum (ft) A1A -10 Tower (35' and above) -10 Podium\* (0' to 20') Podium\* (20' to 35') 10' to 14' <sup>3</sup> Street side yard setback, minimum (ft) NE 16th Street 0' to -4 Tower (35' and above) 14' to 56' <sup>3</sup> -4' to -46' Podium\* (0' to 20') -3' Podium\* (20' to 35') Rear yard setback, minimum (ft) 10' to 14' <sup>3</sup> -3' to -7' Tower (35' and above) 14' to 56' <sup>3</sup> -7' to -49' Podium\* (0' to 20') Podium\* (20' to 35') Interior side yard setback, minimum (ft) 10' to 14' <sup>3</sup> 0' to -4 14' to 56' <sup>3</sup> -4' to -46' Setback from a waterway or canal, minimum (ft) N/A N/A N/A 25 N/A Setback from a dune vegetation line, minimum (ft) sq ft = square feet; ft = feet; du = dwelling unit; du/ac = dwelling units/acre 1. See measurement rules and allowed exceptions/variations in Article 9: Part 4.; Table C 2. Structures within the Air Park Overlay (APO) zoning district must also comply with the height limits in Section 155.3707. 3. Those portions of a structure extending above a height of 20 feet shall be set back an additional 1 ft for each 4 ft (or major fraction thereof) the height of the portion of the structure exceeds 20 ft. Setback shown is based on proposed building height of 205'-6". First number is setback based on lowest portion of range and second number is setback at highest point of range. 4. Column calculated by subtracting RM-45 column minus PD-I column 5. Justification of Intensity and Dimensional Standards - The PD-I district is intended to accommodate small-site, infill development within the city's already developed areas. The PD-I district is intended to provide the flexibility to enable high-quality, mixed-use development on relatively small sites. The Code requires that the Applicant establish PD-I standards through a PD plan pursuant to Section 155.3607(C). The proposed PD-I dimensional standards will allow a development that is consistent with the conceptual building design that provides commerical space that activates pedestrian areas along North Ocean Park and A1A and that provides the mix of uses described within this application package. The existing RM-45 district does not allow high-quality, innoviative, mixed-use development, and is not intended to accommodate development on smaller sites. This is evidenced by dimensional standards that a larger site could easily accommodate, but when applied to a small site, provide constraints that severely limit the development potential. The proposed dimensional standards will allow development to meet the intent of the code to provide innovative, high-quality, mixed-use development and to provide this development on a relatively small infill site. 6. Net lot area calculations are based on an anticipated 10' ROW dedication along A1A, or 1,000 SF. The minimum lot area is subject to change by incorporating final ROW dedication requirements by FDOT, Broward County, and/or the City of Pompano Beach during future approval processes, including plat and site plan approval. The minimum net lot area in this table may be adjusted based on ROW dedications required by FDOT, Broward County, and/or the City of Pompano Beach. 7. Density based on permitted density in Residential High Future Land Use designation in the Land Use Plan; Proposed density may not exceed maximum gross density established by the Land Use Plan for the applicable land use classification per 155.3607(C) NOTES.; Gross area of property is approximately 37,500, maximum density is 46 du/acre, and maximum units based on gross area is 39 du.

8. The density calculation in the RM-45 district is based on the estimated net site area, which is based on an anticipated 10' ROW dedication along A1A. The net lot area used in the calculation is subject to amendment based on final ROW dedication requirements by FDOT, Broward County, and/or the City of Pompano Beach

during future approval processes, including plat and site plan approval.

\* Podium includes Parking Garage and Amenity Deck

INTENSITY AND DIMENSIONAL STANDARDS 1,5

PERMITTED AND ACCESS	ORY USE TABLE	
P = PERMITTED PRINCIPAL USE A = PERMITTED ACCESSORY USE		
LIST OF PERMITTED PRINCIPAL AND ACCESSORY USES	PLANNED DEVELOPMENT - INFILL (PD-I)	USE-SPECIFIC STANDARDS
Principal Uses - Resid		
Dwelling, multifamily	P P	155.4202.C 155.4202.G
Dwelling, mixed-use Principal Uses - Comn	<u> </u>	155.4202.G
Police Station	Р	155.4208.G
Business Service Center	Р	155.4216.A
Parcel Services	Р	155.4216.E
Travel Agency	Р	155.4216.G
Bar or Lounge	Р	155.4218.A
Restaurant	P	155.4218.E
Specialty eating or drinking establishment	P P	155.4218.E
Professional Office	P	155.4218.F 155.4220.B
	<del>                                     </del>	
Art, music, dance studio	P	155.4221.A
Bank or Financial Institution	P	155.4221.C
Dry Cleaning or Laundry Drop-Off Establishment	P	155.4221.E
Personal Services Establishment	P	155.4221.K
Art gallery Grocery or Convenience Store	P P	155.4222.B 155.4222.F
·	P P	
Drug Store or Pharmacy	<del>                                     </del>	155.4222.G
Local liquor or Package store	P	155.4222.L
Beer or Wine Store	Р	155.4222.M
Other retail sales establishment	Р	155.4222.R
Accessory Uses Automated teller machine (ATM)	A	155.4303.C
Bike rack	A	155.4303.D
Electric vehicle (EV) level 1 or 2 charging station	A	155.4303.K
Electric vehicle (EV) level 3 charging station	A	155.4303.k
	+	
Fence or wall	A	155.4303.0
Garage or Carport	A	155.4303.P
Green Roof	A	155.4303.R
Home based business	A	155.4303.S
Outdoor seating, including sidewalk cafes (as accessory to eating and drinking establishments)	А	155.4303.V
Rainwater cistern or barrel	А	155.4303.Z
Retail sales (as accessory uses)	А	155.4303. BB
Satellite dish	А	155.4303. CC
Small wind energy system	А	155.4303. DD
Solar energy collection system	А	155.4303. EE
Swimming pool or spa or hot tub	А	155.4303.GG
Television or radio antenna	А	155.4303.HH
Mechanical Equipment and similar features	А	155.4303.JJ
Uncovered porches, decks, patios, terraces, or walkways	А	155.4303.KK
Flagpoles	А	155.4303.LL
Lighting fixtures, projecting or freestanding	A	155.4303.MM
Gazebo	A	155.4303.NN

			DEVIAT	IONS TABLE
CODE SECTION	TYPE	DECRIPTION	DEVIATION	JUSTIFICATION
155.5101.G.8.B	Parking Lot Entrance Driveways	Minimum Stacking	Reduce from 50 feet to 35 feet	Although minimum stacking distances for parking lots should not be applied to parking garages, the city has made this interpretation. The effective distance from any vehicle conflict exceeds the requirement. Due to the narrowness of the site, it not possible to provide the required 50 feet.
155.5203(D)	Vehicle Use Area	Eliminate VUA planting requirements	Eliminate VUA planting requirements	All proposed VUA areas will be within the building pedestal except for the driveward allowing entrance into the parking area and on-street parking. Therefore, car will buffered by portions of the building. The site plan will include planters and/or landscape islands to add vegetation along the north portion of the property, which is the only locaiton where VUA's may be visible.
155.5203(E)(3)(b)	Building Base Plantings	Cluster shrubs	shrubs in landscape	The applicant is proposing a wide-side walk / plaza surrounding the building; Therefore, to maximize the visual impact of vegetation and allow design flexabilit the site will cluster shrubs in landscape islands rather than space them evenly along the building façade.
155.5203(F)(2)(b)	Landscape Buffer	Reduce buffer requirements	Buffer required only along south property line, rather than all property lines.	The subject property is small and buffers on all sides would take up a relatively large percentage of the site. Because North Ocean Park is busy, the Applicant proposes to utilize the area north and west of the building to construct large sidewalks and plaza area that would be more benifical to the public who walk to park and beach. The Applicant will also include wider paved and shaded area or the east side of the building to provide a pedestrian friendly interface between th non-residential component of the building and the park. In lieu of the buffer, the will include planters and/or landscape that add a natural component, but that would not meet the buffer yard requirement.
155.5203(F)(3) including TABLE 155.5203.F.3	Landscape Buffer	Reduction of buffer	Reduce from 10 feet to five (5) feet.	The conceptual building design includes a 10-foot buffer along a majority of the south side of the building; however, the site is constrained in the north-south direction because the conceptual building footprint includes parking, driveways and other site features that necessiate the width of the building design. On the so side of the property, some of the buffer area is needed for sidewalk and possibly other building components that would protude into the 10-foot buffer area. The fit (5) feet of relief from this requirement will allow a buffer and other site features the buffer area, while maintaining the building width, which is needed to accomodate the constrained building footprint.

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SHEET IDENTIFICATION **TABLES** 

PROJECT NO. 09520.00

PRELIMINARY PLAN NOT FOR CONSTRUCTION § THESE PLANS ARE NOT FULLY PERMITTED AND ARE SUBJECT TO REVISIONS MADE DURING THE PERMITTING PROCESS. RESPONSIBILITY FOR THE USE OF THESE PLANS PRIOR TO OBTAINING PERMITS FROM ALL AGENCIES HAVING JURISDICTION

OVER THE PROJECT WILL FALL SOLELY UPON THE USER

## **EXHIBIT D**



- 2. VEHICULAR ENTRY
- 3. PROPOSED PARALLEL PARKING
- 4. SPECIAL PAVING
- 5. RETAIL FRONT

## **EXHIBIT E**



1508 N OCEAN BLVD POMPANO BEACH, FL | 33062 CONCEPTUAL DRAWINGS

PROJECT, ADDRESS AND OWNER:

### OCEAN PARK BEACH **RESIDENCES**

1508 N OCEAN BLVD POMPANO Mount Vernon Property 219 NW 12th Ave. #812 Miami, FL 33128



CONSULTING ENGINEERS:

Reviewed for CODE COMPLIANCE

	Signature	Date
P. Works		/_/_
Fire Prev		//
Planning		//
Zoning		//
Building		//
Structural_		//
Electrical		//
Plumbing		//
Mech		//
C Wasts		/ /

## **SCHEMATIC DESIGN**

**COVER SHEET & LIST OF DRAWINGS** 

KNOWLEDGE, THE PLANS AND SPECIFICATIONS COMPLY WITH THE APPLICABLE MINIMUM BUILDING CODES AND THE APPLICABLE FIRE-SAFETY


ARTURO G. GRIEGO, AI

SHEET No.:


**G-1** 



## **NE 16TH STREET**

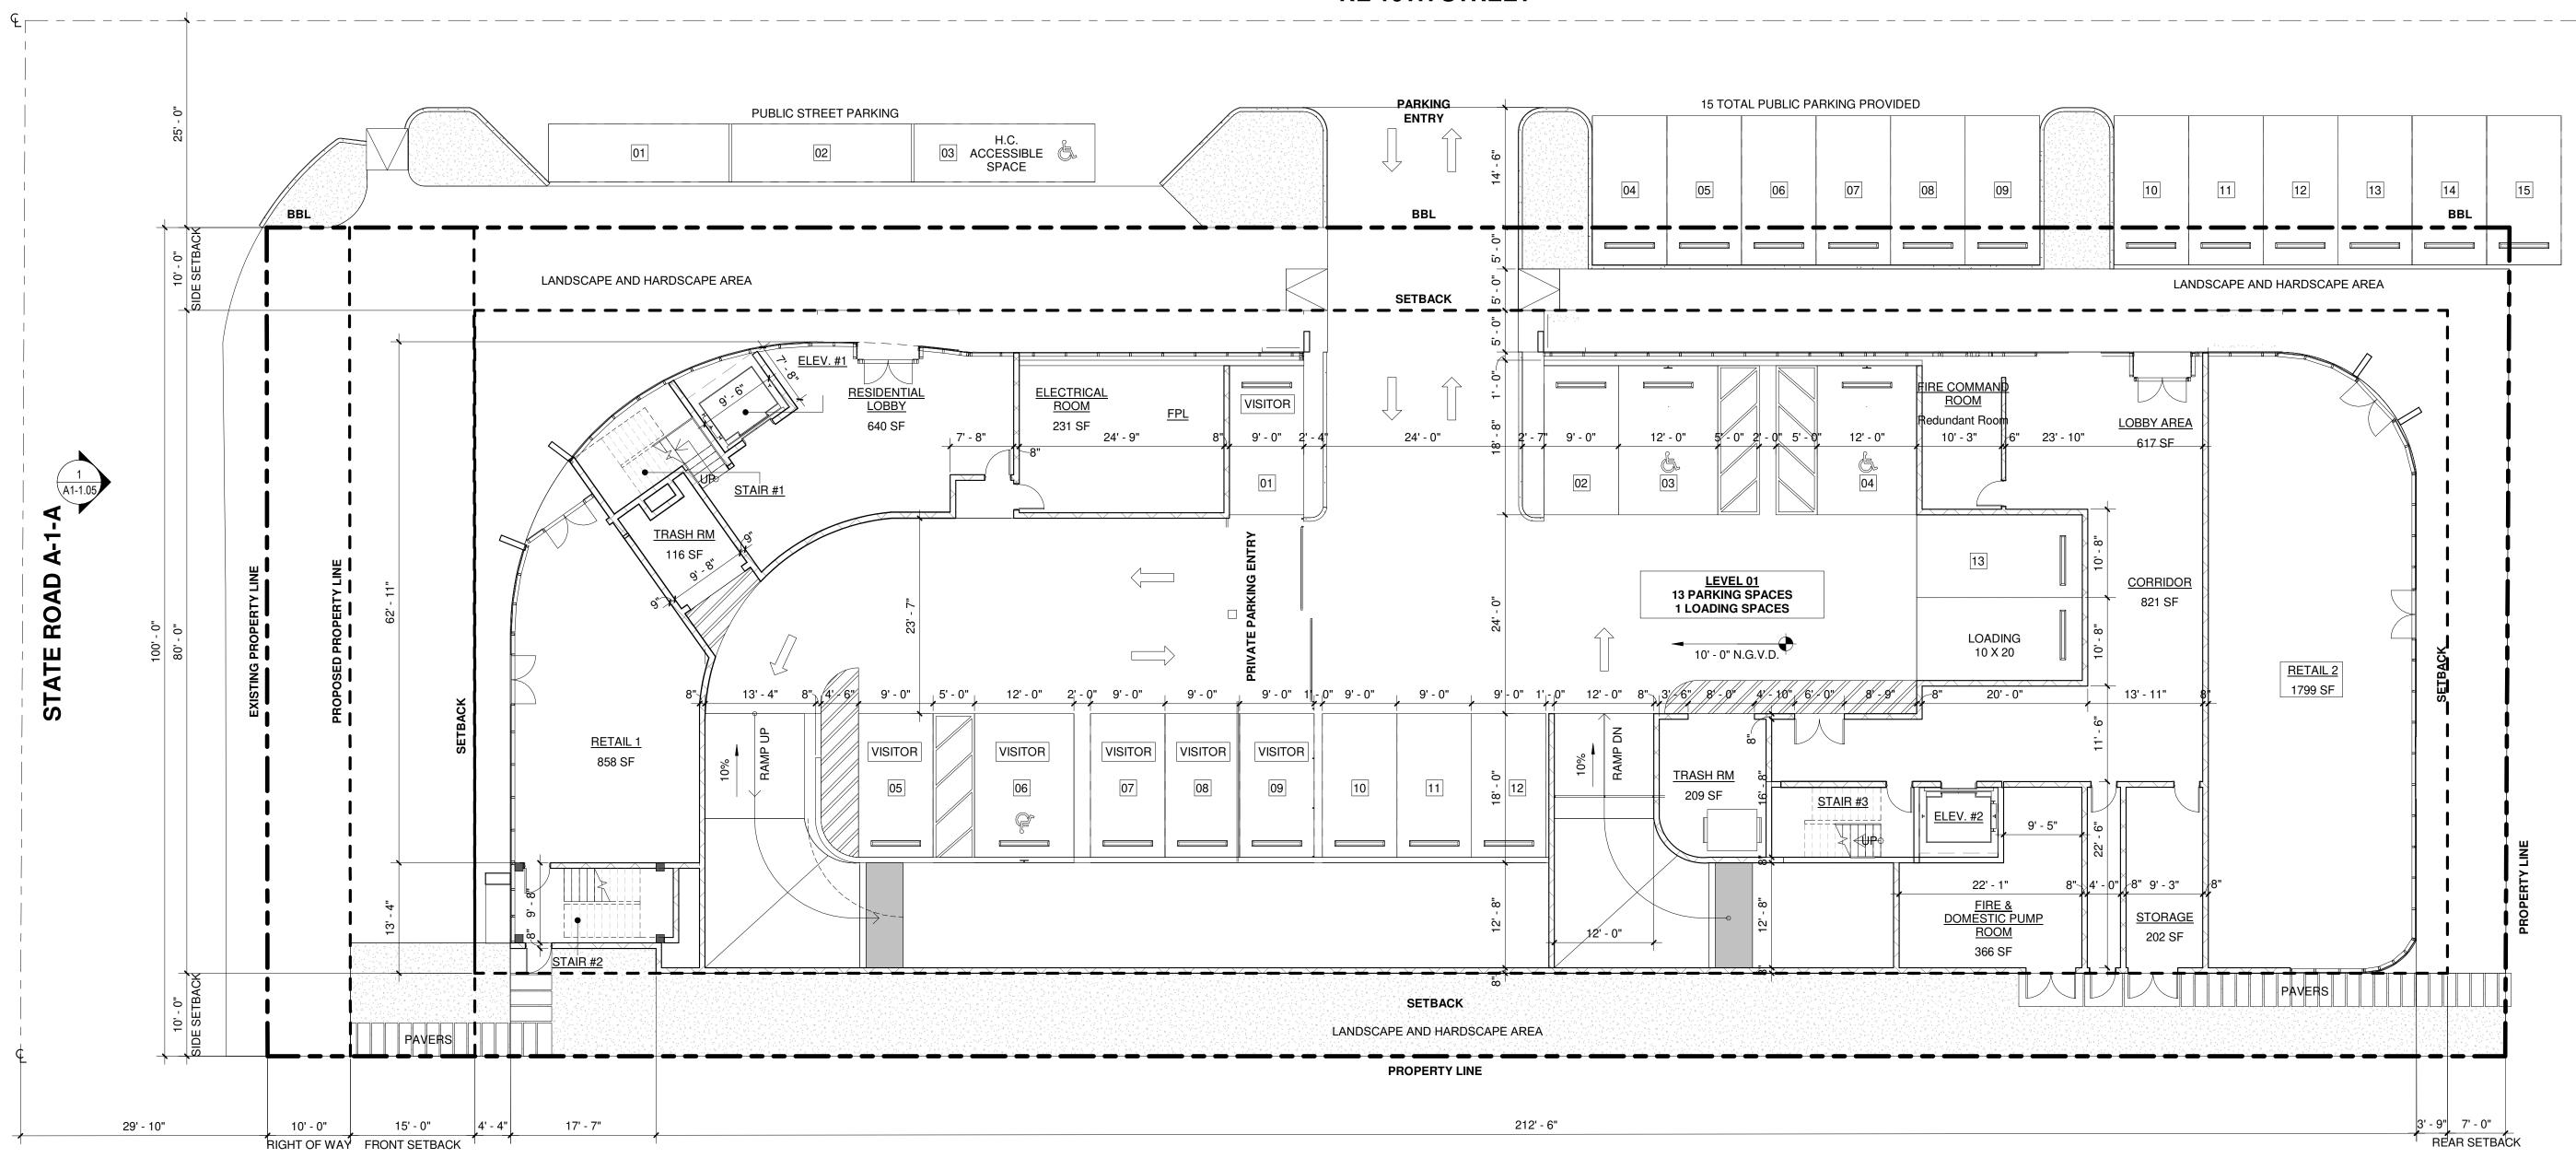



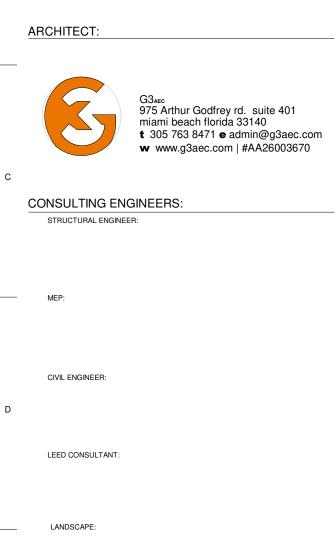

PROJECT, ADDRESS AND OWNER:

**RESIDENCES** 

BEACH, FL | 33062

1508 N OCEAN BLVD POMPANO

Mount Vernon Property
Holdings, LLC
219 NW 12th Ave. #812 Miami, FL 33128

**OCEAN PARK BEACH** 

Reviewed for CODE COMPLIANCE

Signature

CONCEPT LEVEL 01 PLAN

ISSUE DATE:

**REVISIONS:** 

SCALE:

TO THE BEST OF THE ARCHITECT'S OR ENGINEER'S KNOWLEDGE, THE PLANS AND SPECIFICATIONS COMPLY WITH THE APPLICABLE MINIMUM BUILDING CODES AND THE APPLICABLE FIRE-SAFETY

3/32" = 1'-0"

COMPLY WITH THE APPLICABLE MINIMUM BUILDIN
CODES AND THE APPLICABLE FIRE-SAFETY
STANDARDS
AS DETERMINED BY THE LOCAL AUTHORITY

SEAL:

SIGNATURE:

ARTURO G. GRIEGO, AIA
AR94011

SHEET No.:

SHEET No.:


A1-1.01

CONCEPTUAL SITE PLAN

SCALE 3/32" = 1'-0"



## **NE 16TH STREET**

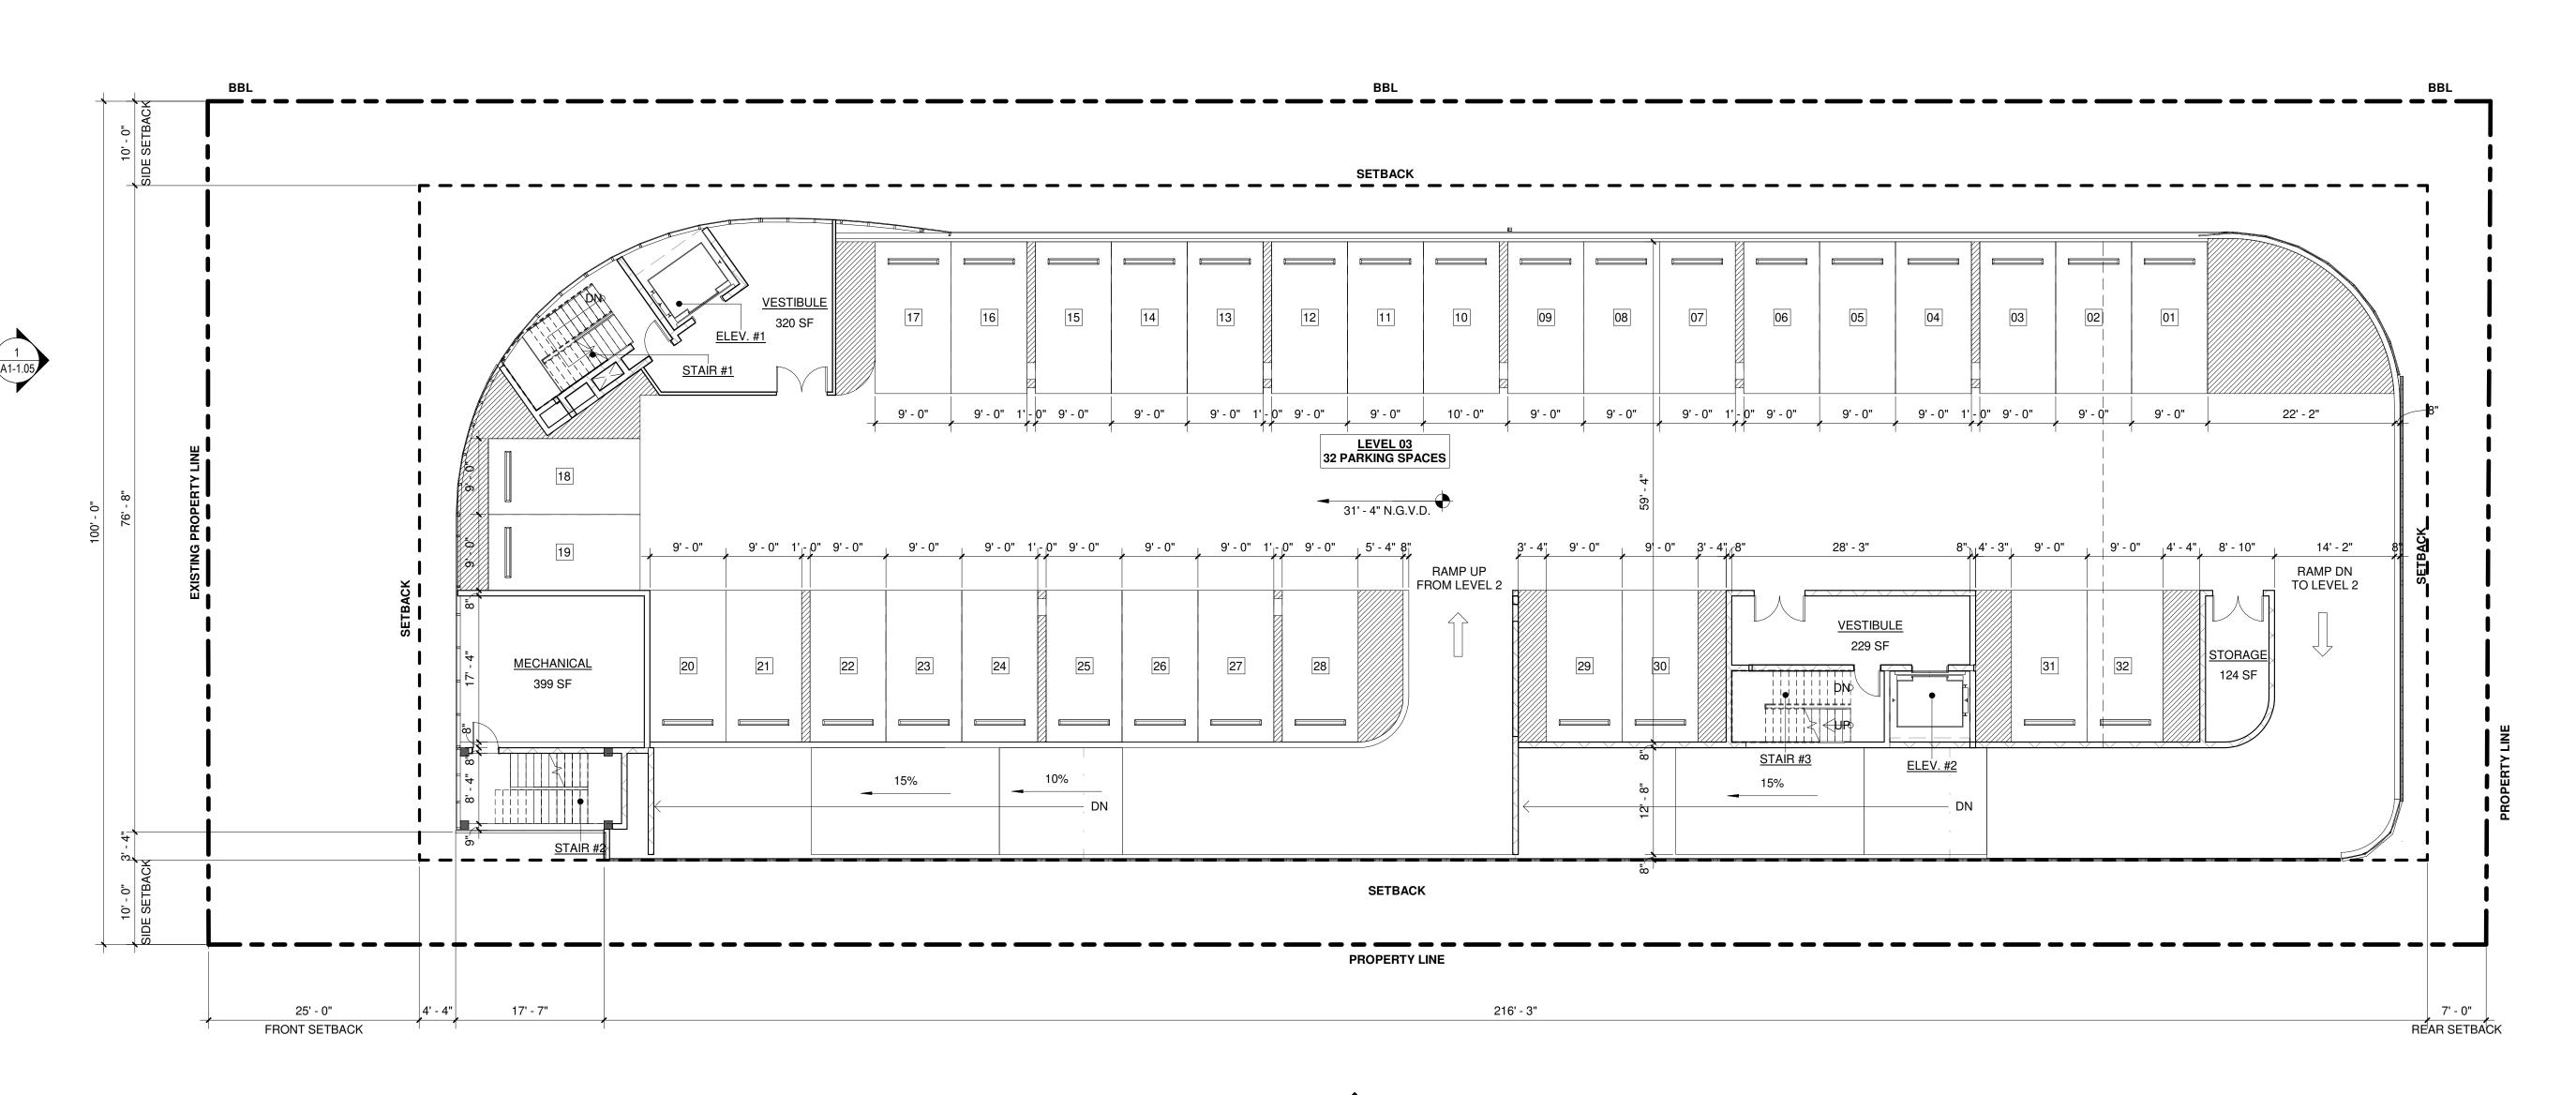



PROJECT, ADDRESS AND OWNER:

### **OCEAN PARK BEACH RESIDENCES**

1508 N OCEAN BLVD POMPANO BEACH, FL | 33062 Mount Vernon Property Holdings, LLC 219 NW 12th Ave. #812 Miami, FL 33128

ARCHITECT:



CONSULTING ENGINEERS:

CIVIL ENGINEER:

LEED CONSULTANT:

Reviewed for CODE COMPLIANCE

	Signature	Date
P. Works		//
Fire Prev		//
Planning		//
Zoning		//
Building		//
Structural		//
Electrical		//
Plumbing		//
Mech		//

### SCHEMATIC DESIGN

ISSUE DATE: REVISIONS:

SCALE:

S. Waste\_

CONCEPT PARKING LEVELS

TO THE BEST OF THE ARCHITECT'S OR ENGINEER'S KNOWLEDGE, THE PLANS AND SPECIFICATIONS COMPLY WITH THE APPLICABLE MINIMUM BUILDING CODES AND THE APPLICABLE FIRE-SAFETY STANDARDS

AS DETERMINED BY THE LOCAL AUTHORITY

3/32" = 1'-0"


SIGNATURE: ARTURO G. GRIEGO, AIA

SHEET No.:

A1-1.03



## **NE 16TH STREET**

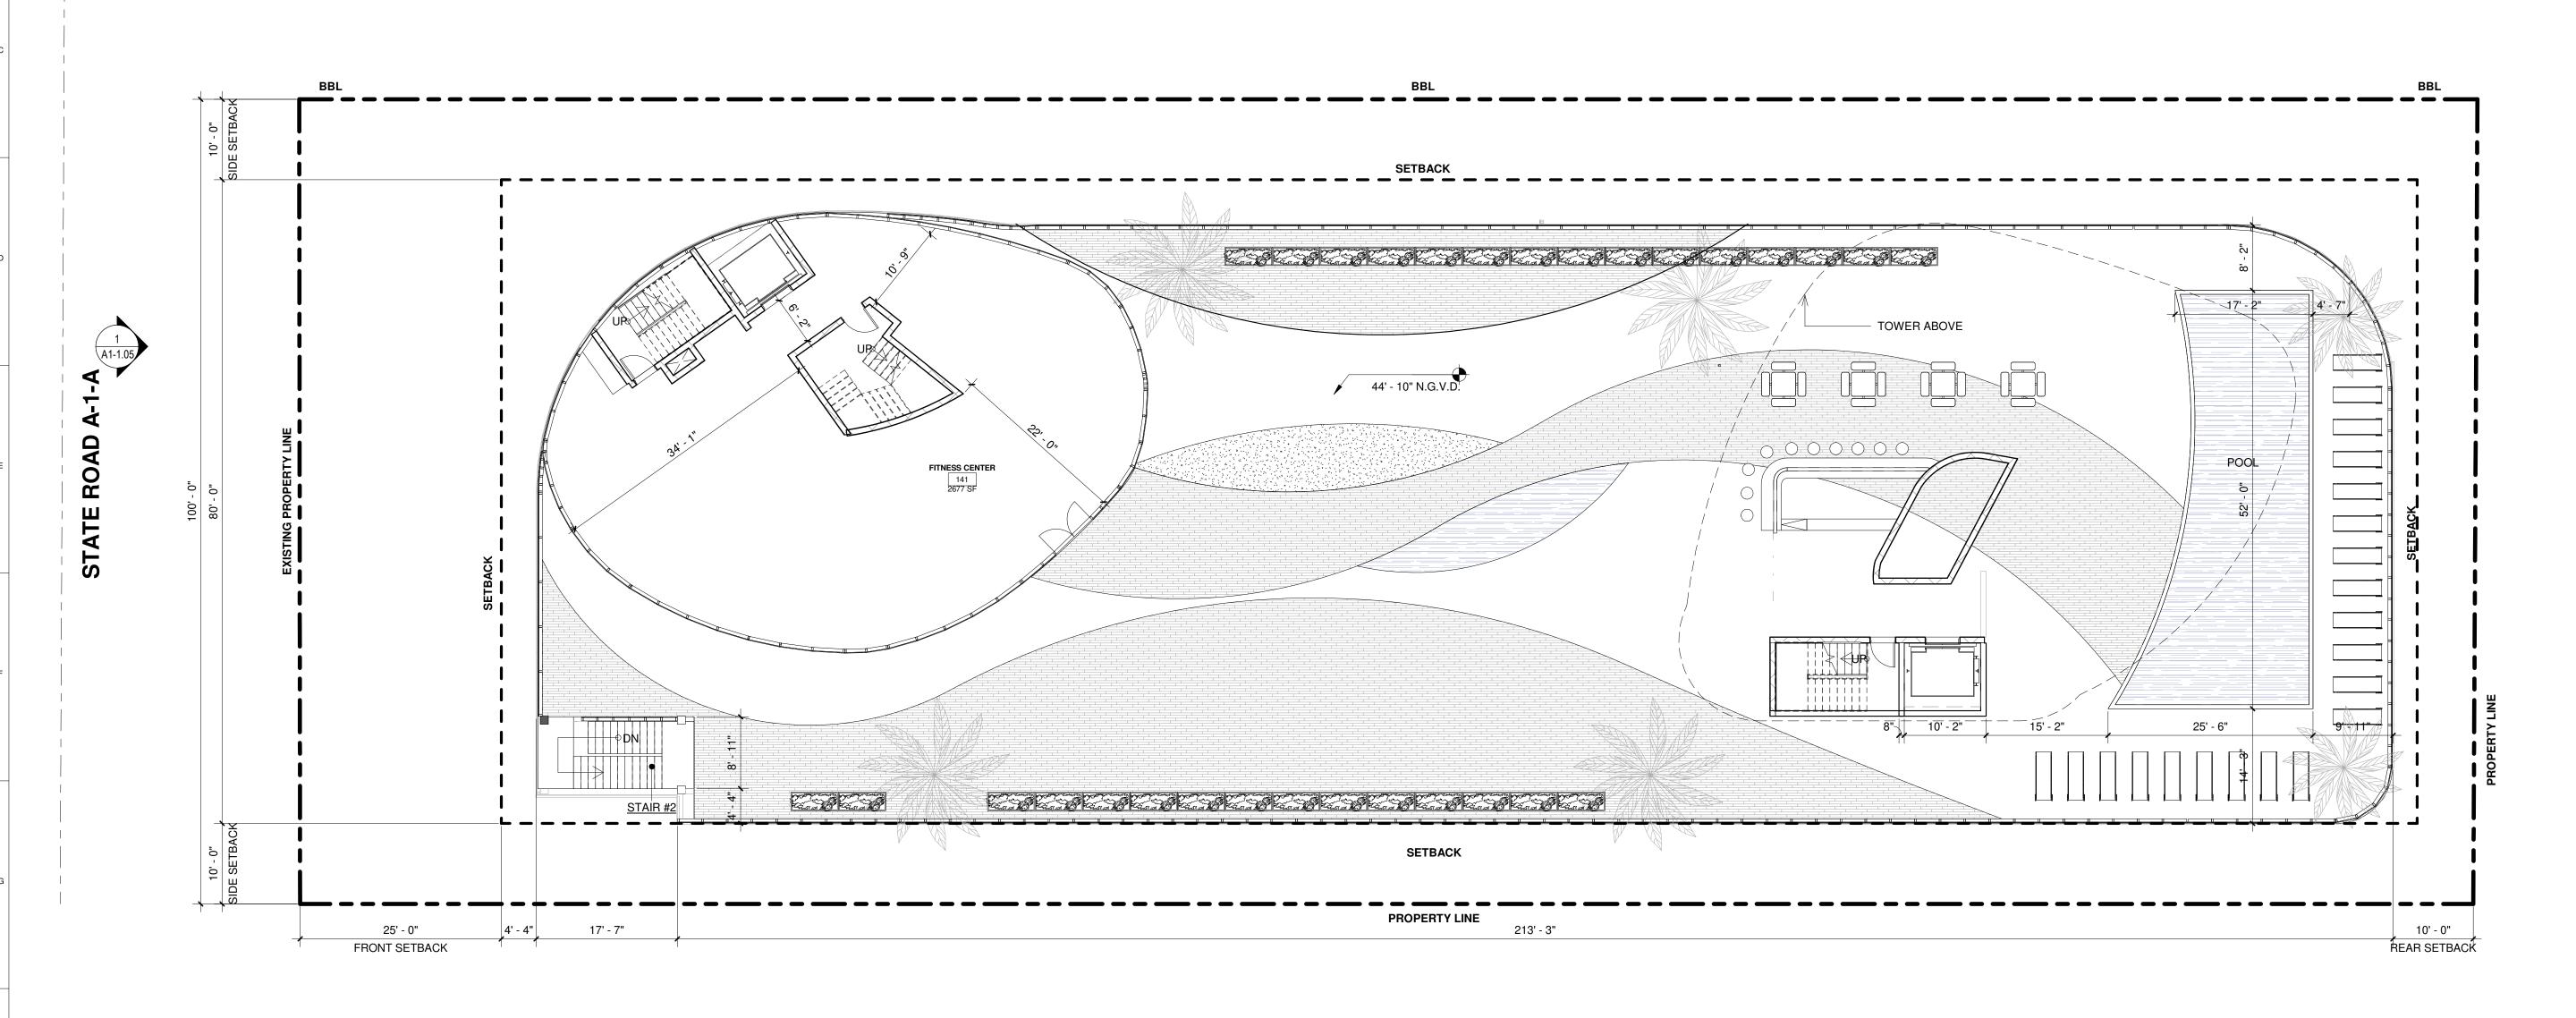



PROJECT, ADDRESS AND OWNER:

## OCEAN PARK BEACH RESIDENCES

1508 N OCEAN BLVD POMPANO BEACH, FL | 33062 Mount Vernon Property Holdings, LLC 219 NW 12th Ave. #812 Miami, FL 33128

NED

ARCHITECT:



CONSULTING ENGINEERS:

CIVIL ENGINEER:

LEED CONSULTANT:

LANDSCAF

Reviewed for CODE COMPLIANCE

	Signature	Date
P. Works		//
Fire Prev		//
Planning		/
Zoning		//
Building		//
Structural		//
Electrical		//
Plumbing		//
Mech		/
S. Waste		//

## SCHEMATIC DESIGN

PROJECT No.: ISSUE DATE: REVISIONS:

SCALE:

CONCEPT AMENITY LEVEL

TO THE BEST OF THE ARCHITECT'S OR ENGINEER'S KNOWLEDGE, THE PLANS AND SPECIFICATIONS COMPLY WITH THE APPLICABLE MINIMUM BUILDING CODES AND THE APPLICABLE FIRE-SAFETY STANDARDS

AS DETERMINED BY THE LOCAL AUTHORITY

3/32" = 1'-0"

STANDARDS
AS DETERMINED BY THE LOCAL AUTHORITY

SEAL:

SEAL:


SIGNATURE:

ARTURO G. GRIEGO, AIA
AR94011

R94011

SHEET No.:

A1-1.04

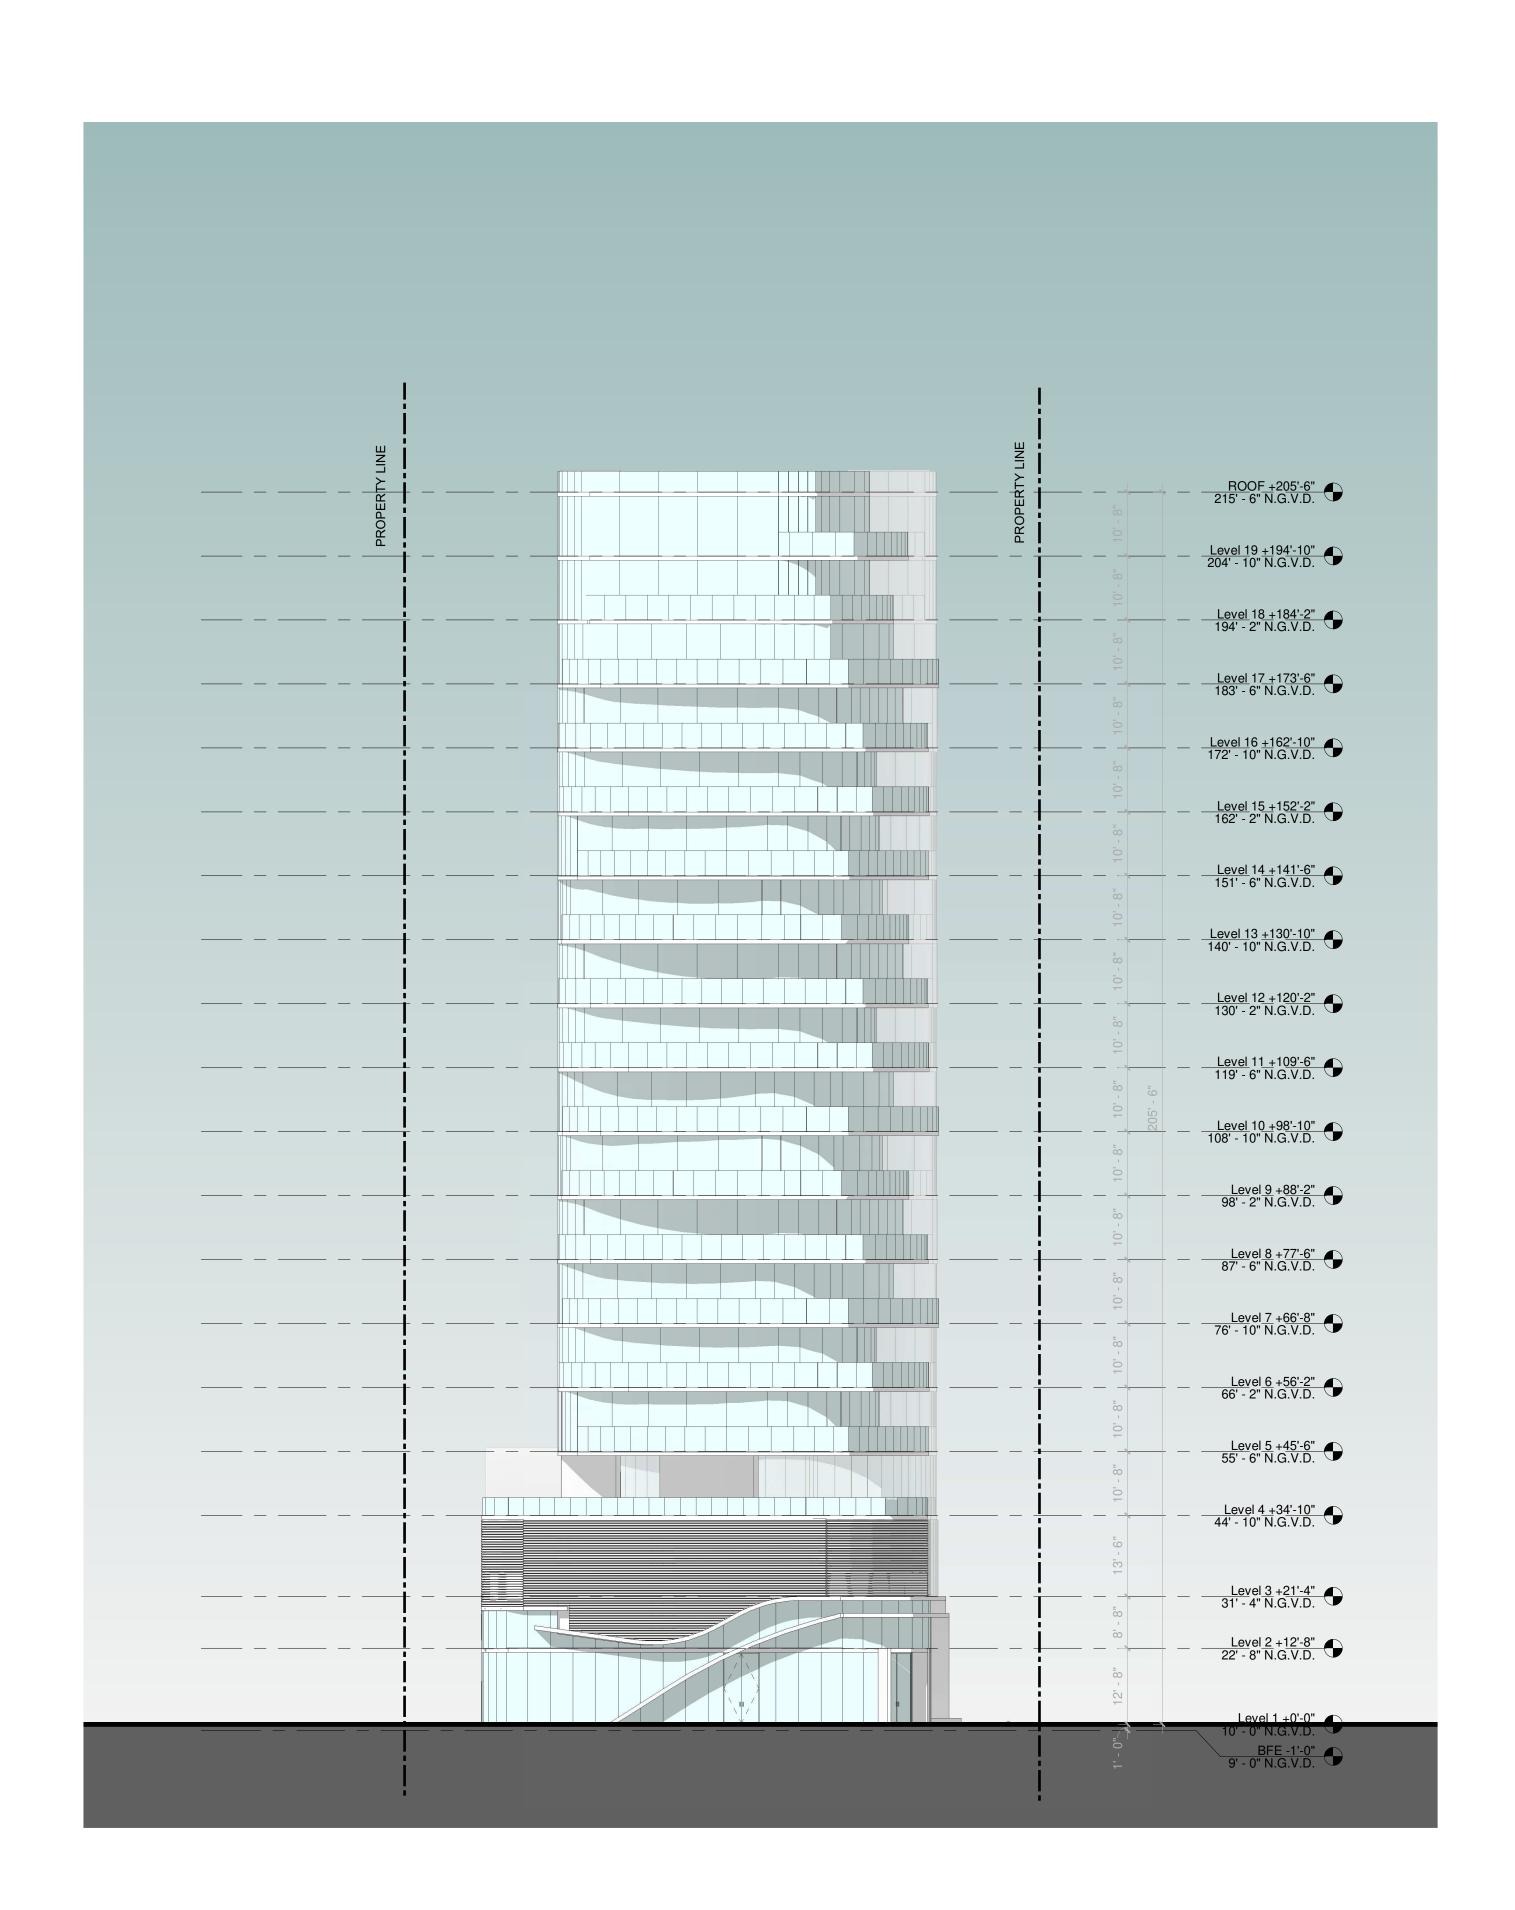

#### CONCEPTUAL FLR BREAKDOWN BY FLOOR LEVEL 01 16,923 SF LEVEL 12 6,779 SF LEVEL 02 16,923 SF LEVEL 13 6,779 SF LEVEL 03 16,841 SF LEVEL 14 6,779 SF LEVEL 04 3,623 SF LEVEL 15 6,779 SF LEVEL 05 6,779 SF LEVEL 16 6,779 SF LEVEL 06 6,779 SF LEVEL 17 6,779 SF LEVEL 07 6,779 SF LEVEL 18 6,779 SF LEVEL 08 6,779 SF LEVEL 19 6,779 SF LEVEL 09 6,779 SF LEVEL 10 6,779 SF LEVEL 11 6,779 SF

TOTAL FLR: 155,995 SF

## ELEVATION LEGEND AND NOTES UNLESS OTHERWISE INDICATED ALL ELEVATIONS SHOWN IN N.G.V.D = 1.56'

1. 0'-0" = 10'-0" N.G.V.D.
2. ALL SHOP DRAWINGS REQUIRE APROVAL OF CITY OF MIAMI BEACH.
3. REFFER TO SHEET A-6.00 FOR WALL SECTION SPECIFICATIONS.
4. ALL CONSTRUCTION AND FINISH MATERIAL INSTALLED BELOW BFE SHALL BE FLOOD RESISTANT MATERIAL

> **CONCEPT ELEVATION - EAST** SCALE 1/16" = 1'-0"

PROJECT, ADDRESS AND OWNER:

### **OCEAN PARK BEACH RESIDENCES**

1508 N OCEAN BLVD POMPANO BEACH, FL | 33062 Mount Vernon Property Holdings, LLC 219 NW 12th Ave. #812 Miami, FL 33128

ARCHITECT:



CONSULTING ENGINEERS: STRUCTURAL ENGINEER:

CIVIL ENGINEER:

LEED CONSULTANT:

LANDSCAPE:

Reviewed for CODE COMPLIANCE

		Signature	Da	ate
	P. Works		/	/
	Fire Prev		/_	
_	Planning			//
	Zoning		/	/
	Building		/_	
	Structural		/	/
	Electrical		/	/
	Plumbing		/	/
	Mech			//

## SCHEMATIC DESIGN

PROJECT No.: ISSUE DATE: REVISIONS:

S. Waste\_\_\_

CONCEPT ELEVATION - EAST

As indicated SCALE:


TO THE BEST OF THE ARCHITECT'S OR ENGINEER'S KNOWLEDGE, THE PLANS AND SPECIFICATIONS COMPLY WITH THE APPLICABLE MINIMUM BUILDING CODES AND THE APPLICABLE FIRE-SAFETY STANDARDS

AS DETERMINED BY THE LOCAL AUTHORITY

SIGNATURE: ARTURO G. GRIEGO, AIA

SHEET No.:

A2-1.01

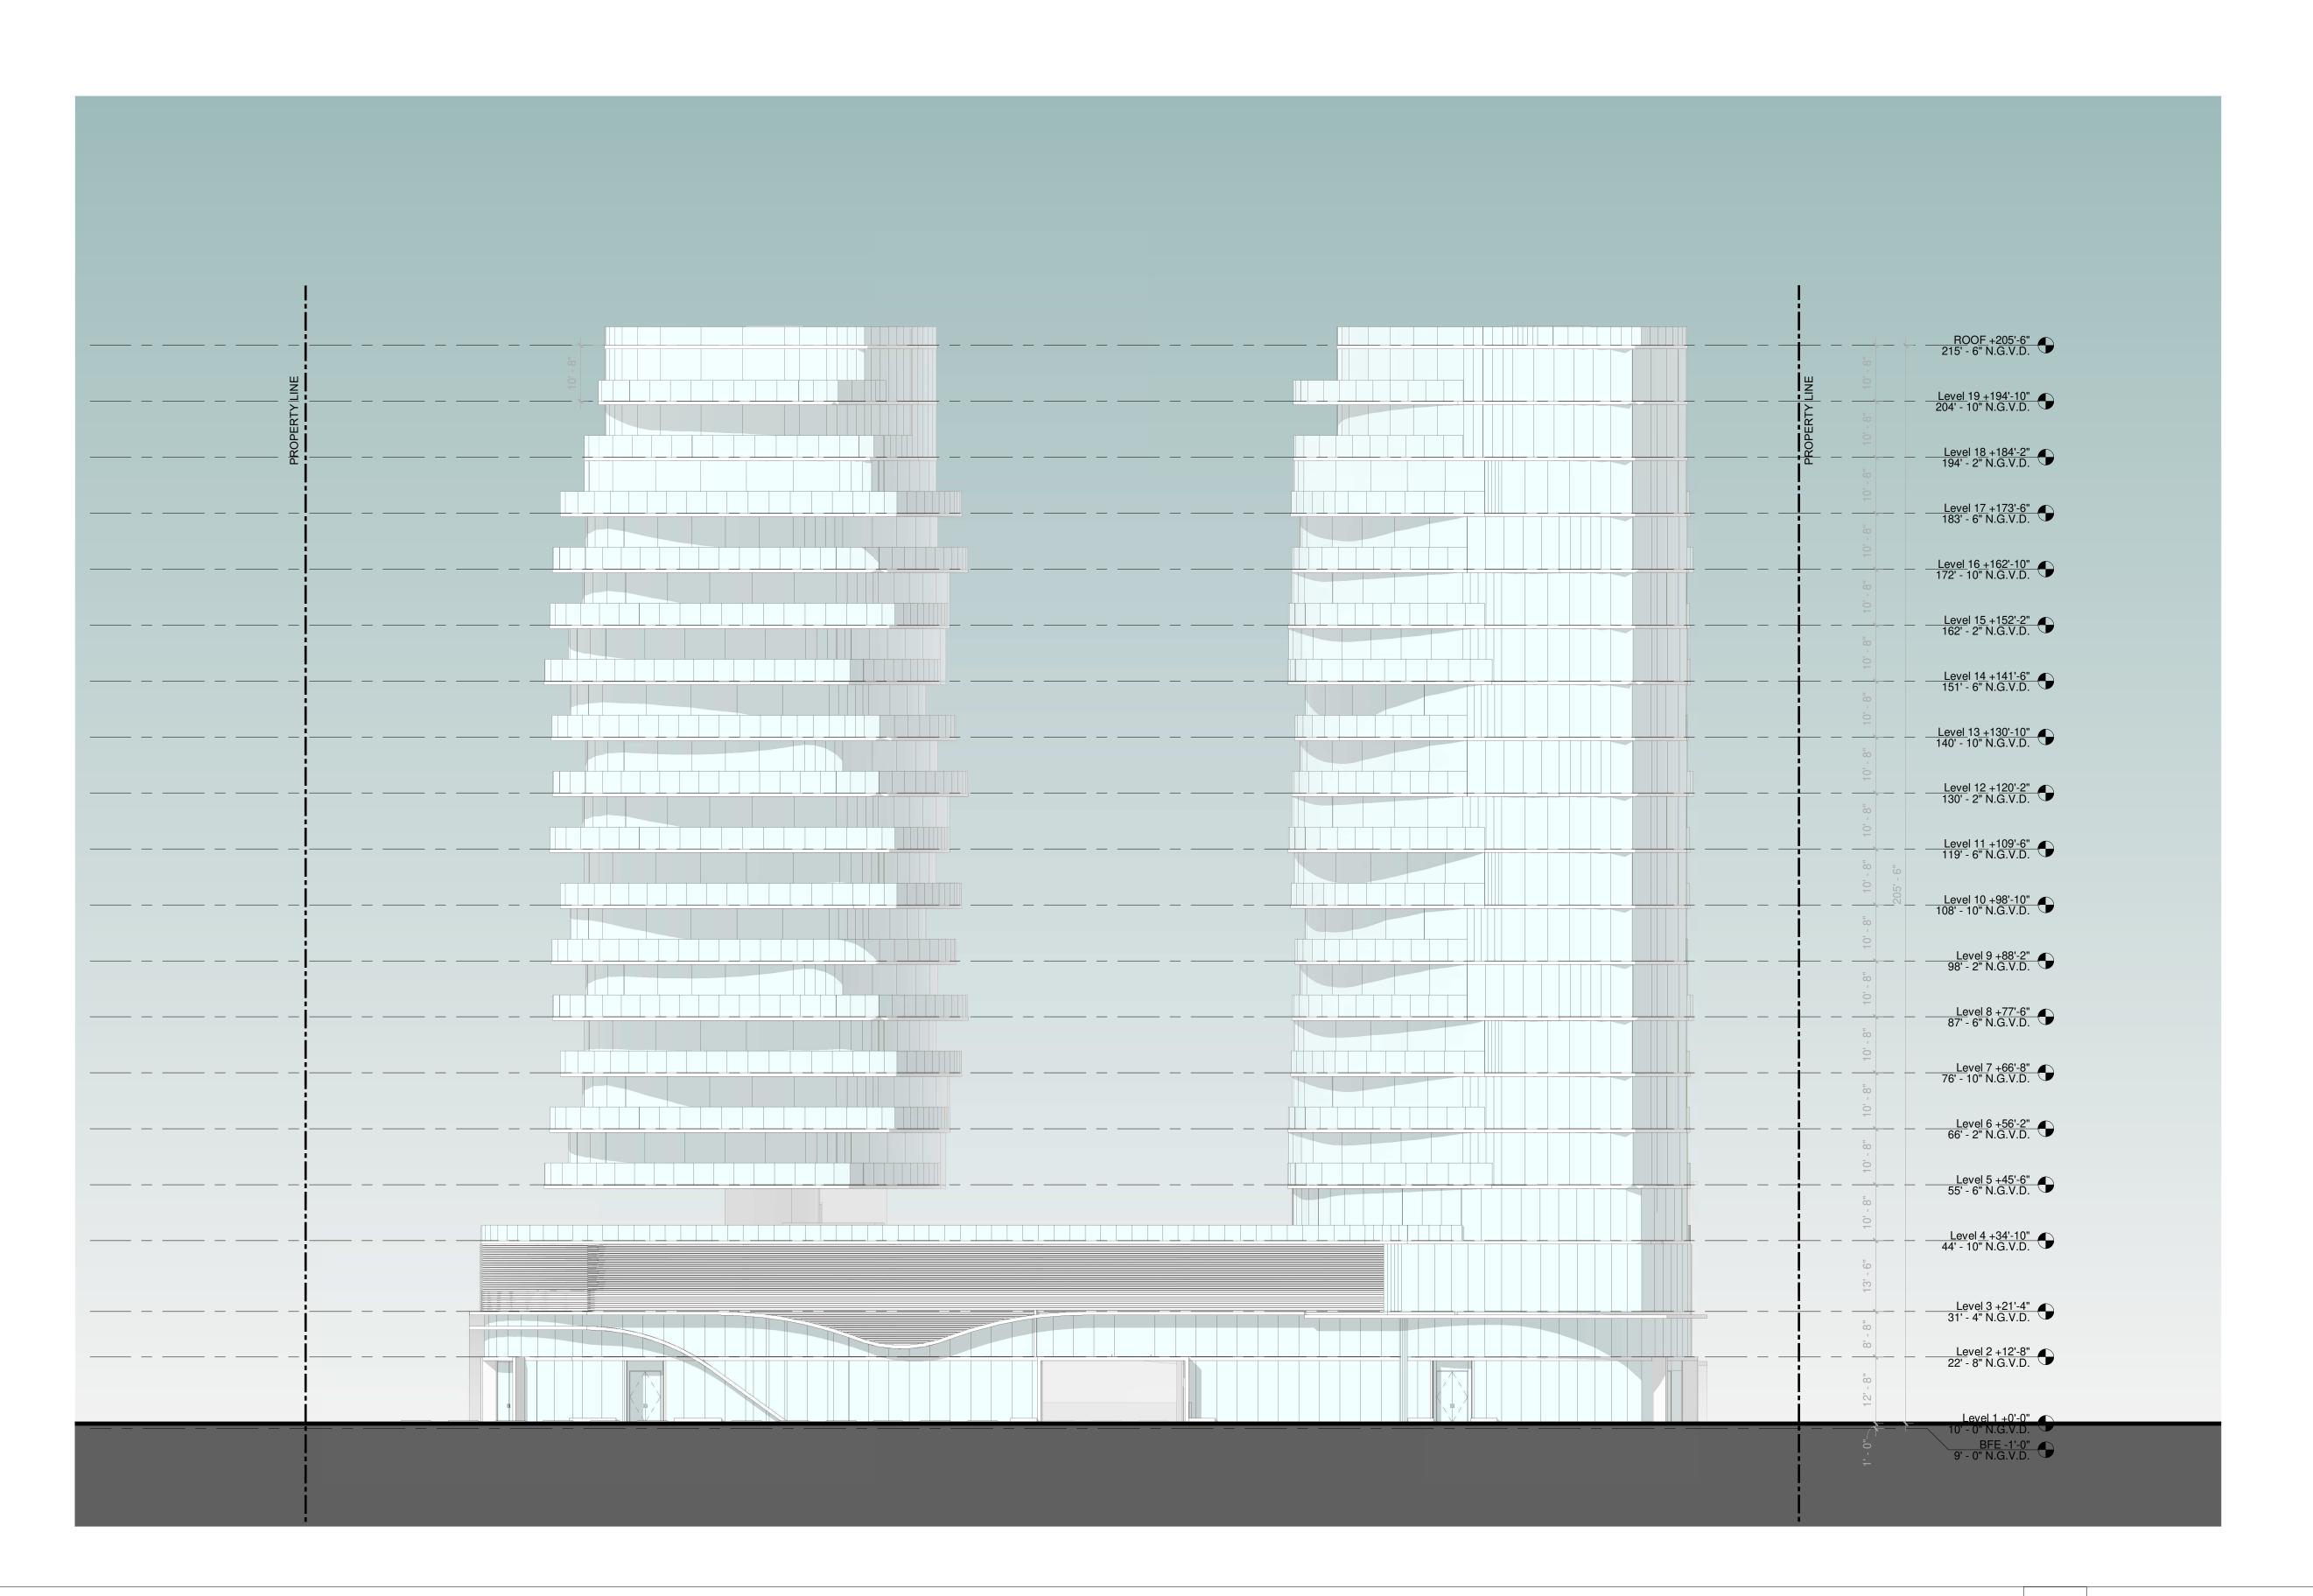

## **OCEAN PARK BEACH RESIDENCES**

1508 N OCEAN BLVD POMPANO BEACH, FL | 33062 Mount Vernon Property Holdings, LLC 219 NW 12th Ave. #812 Miami, FL 33128

OWNER

ARCHITECT:



CONSULTING ENGINEERS: STRUCTURAL ENGINEER:

CIVIL ENGINEER:

LEED CONSULTANT:

LANDSCAPE:

Reviewed for CODE COMPLIANCE

	Signature	9	D	ate
P. Works			/_	_/_
Fire Prev			/_	_/_
Planning				_/_
Zoning			/_	_/_
Building			/_	_/_
Structural			/_	_/_
Electrical			/_	_/_
Plumbing			/_	_/_
Mech				_/_
S. Waste			/_	_/_

## SCHEMATIC DESIGN

ISSUE DATE: REVISIONS:

SCALE:

CONCEPT ELEVATION - NORTH

TO THE BEST OF THE ARCHITECT'S OR ENGINEER'S KNOWLEDGE, THE PLANS AND SPECIFICATIONS COMPLY WITH THE APPLICABLE MINIMUM BUILDING CODES AND THE APPLICABLE FIRE-SAFETY STANDARDS


AS DETERMINED BY THE LOCAL AUTHORITY

1/16" = 1'-0"

SIGNATURE: ARTURO G. GRIEGO, AIA

SHEET No.:

A2-1.02

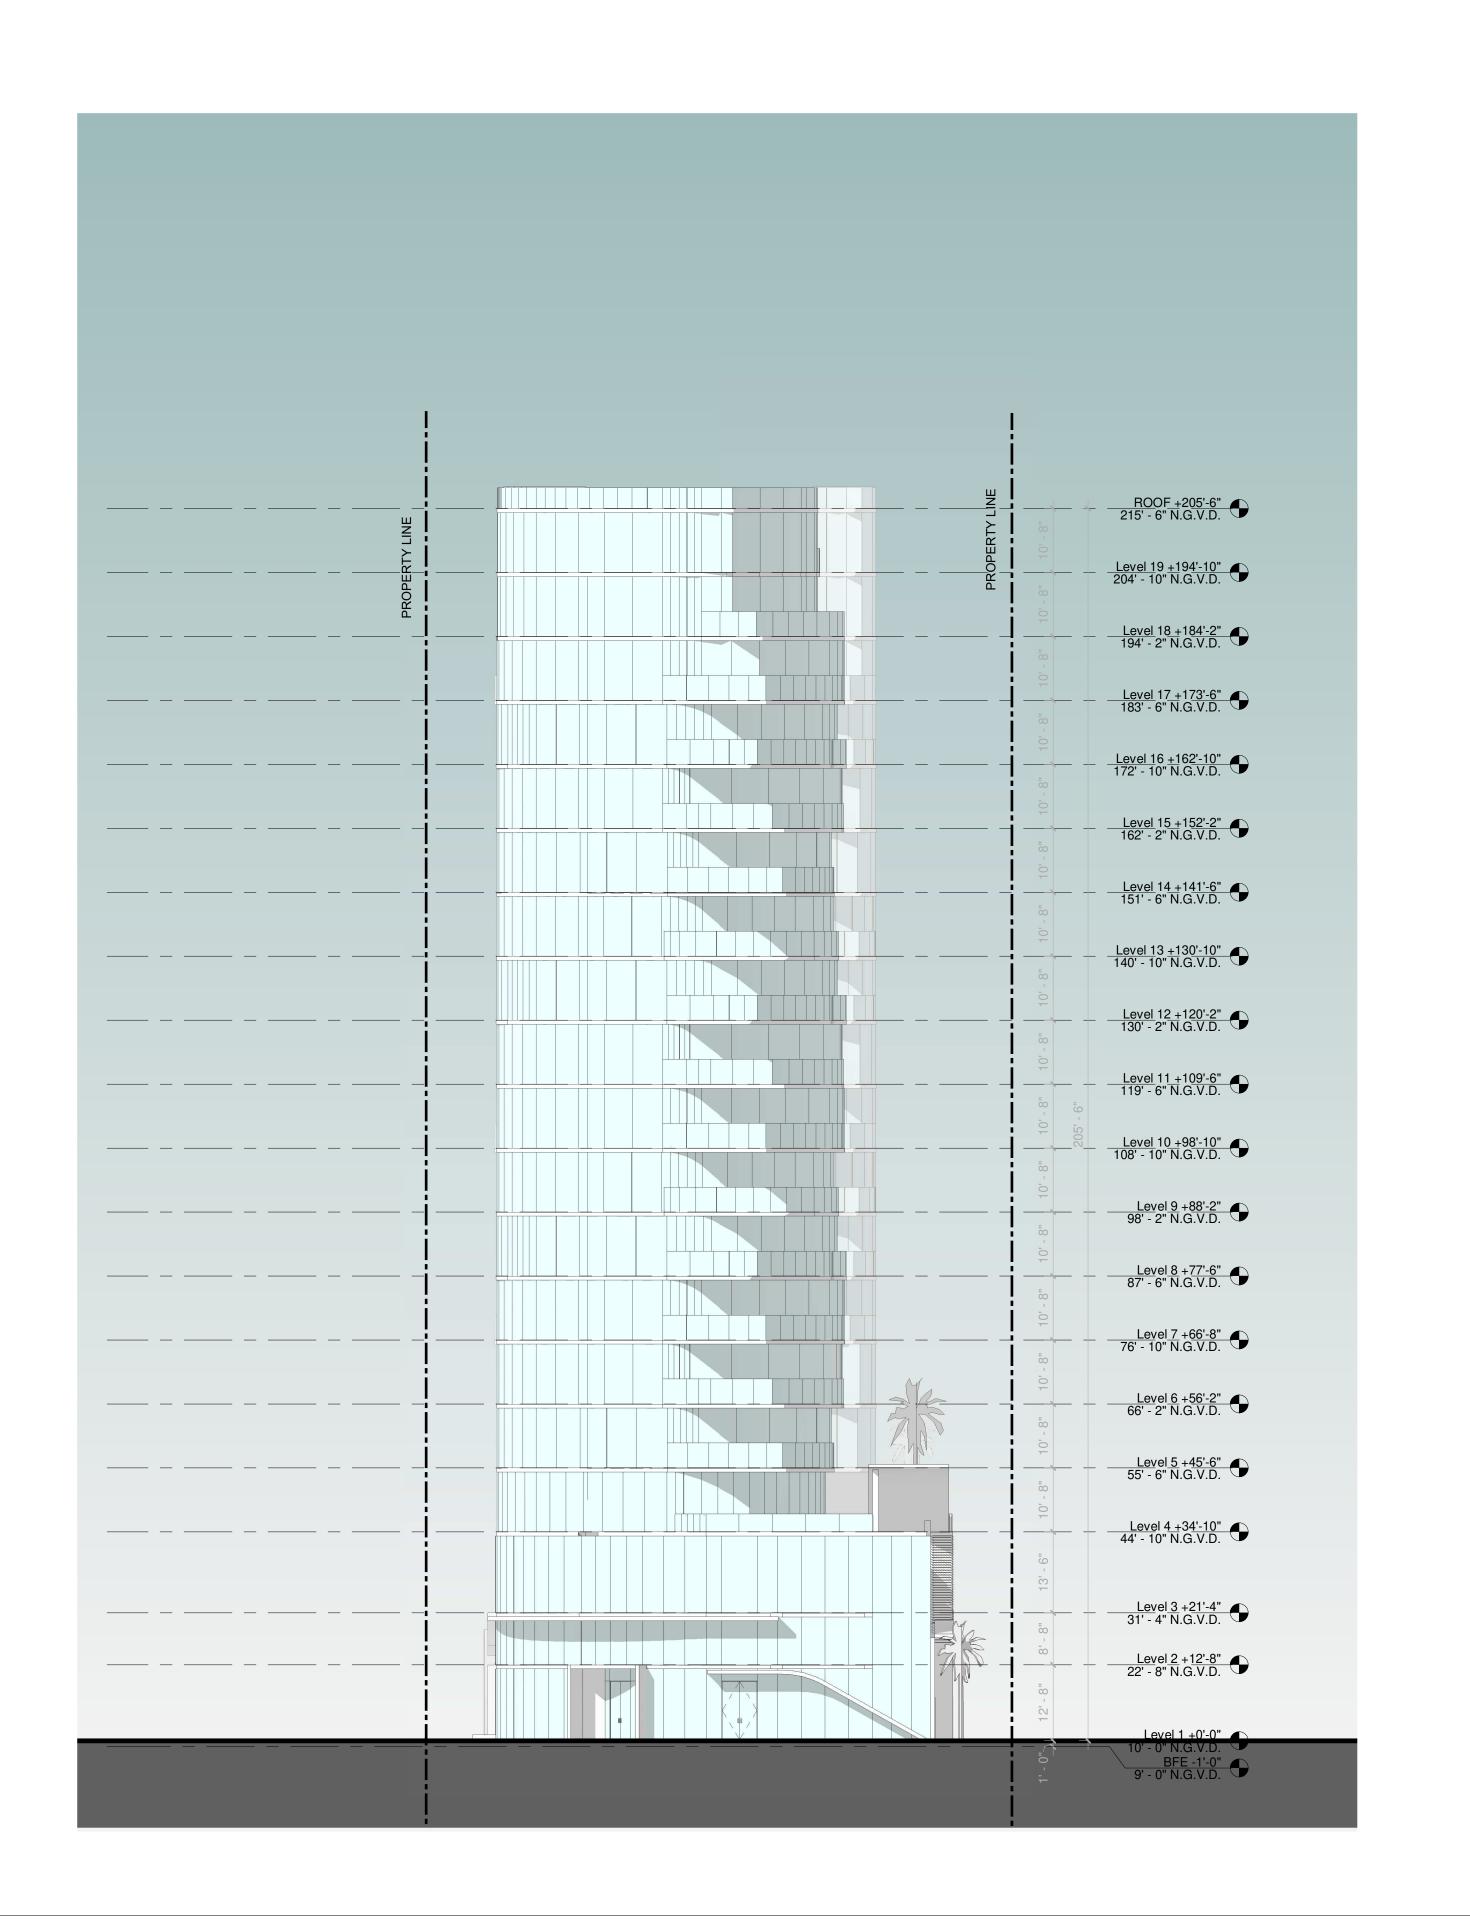

## **OCEAN PARK BEACH RESIDENCES**

1508 N OCEAN BLVD POMPANO BEACH, FL | 33062 Mount Vernon Property Holdings, LLC 219 NW 12th Ave. #812 Miami, FL 33128

OWNER

ARCHITECT:



CONSULTING ENGINEERS: STRUCTURAL ENGINEER:

CIVIL ENGINEER:

LEED CONSULTANT:

LANDSCAPE:

Reviewed for CODE COMPLIANCE

	Signature		)ate	)
P. Works		/_	_/_	_
Fire Prev		/_	_/_	_
Planning		_	_/_	_/_
Zoning		/_	_/_	
Building		/_	_/_	
Structural		/_	_/_	
Electrical		/_	_/_	
Plumbing		/_	_/_	
Mech			_/_	_/_

### SCHEMATIC DESIGN

ISSUE DATE: REVISIONS:

SCALE:


S. Waste\_\_\_

CONCEPT ELEVATION - WEST

1/16" = 1'-0"


TO THE BEST OF THE ARCHITECT'S OR ENGINEER'S KNOWLEDGE, THE PLANS AND SPECIFICATIONS COMPLY WITH THE APPLICABLE MINIMUM BUILDING CODES AND THE APPLICABLE FIRE-SAFETY STANDARDS

AS DETERMINED BY THE LOCAL AUTHORITY

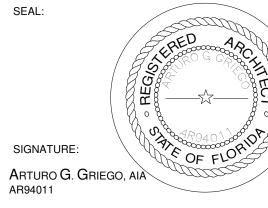

SHEET No.:

A2-1.03

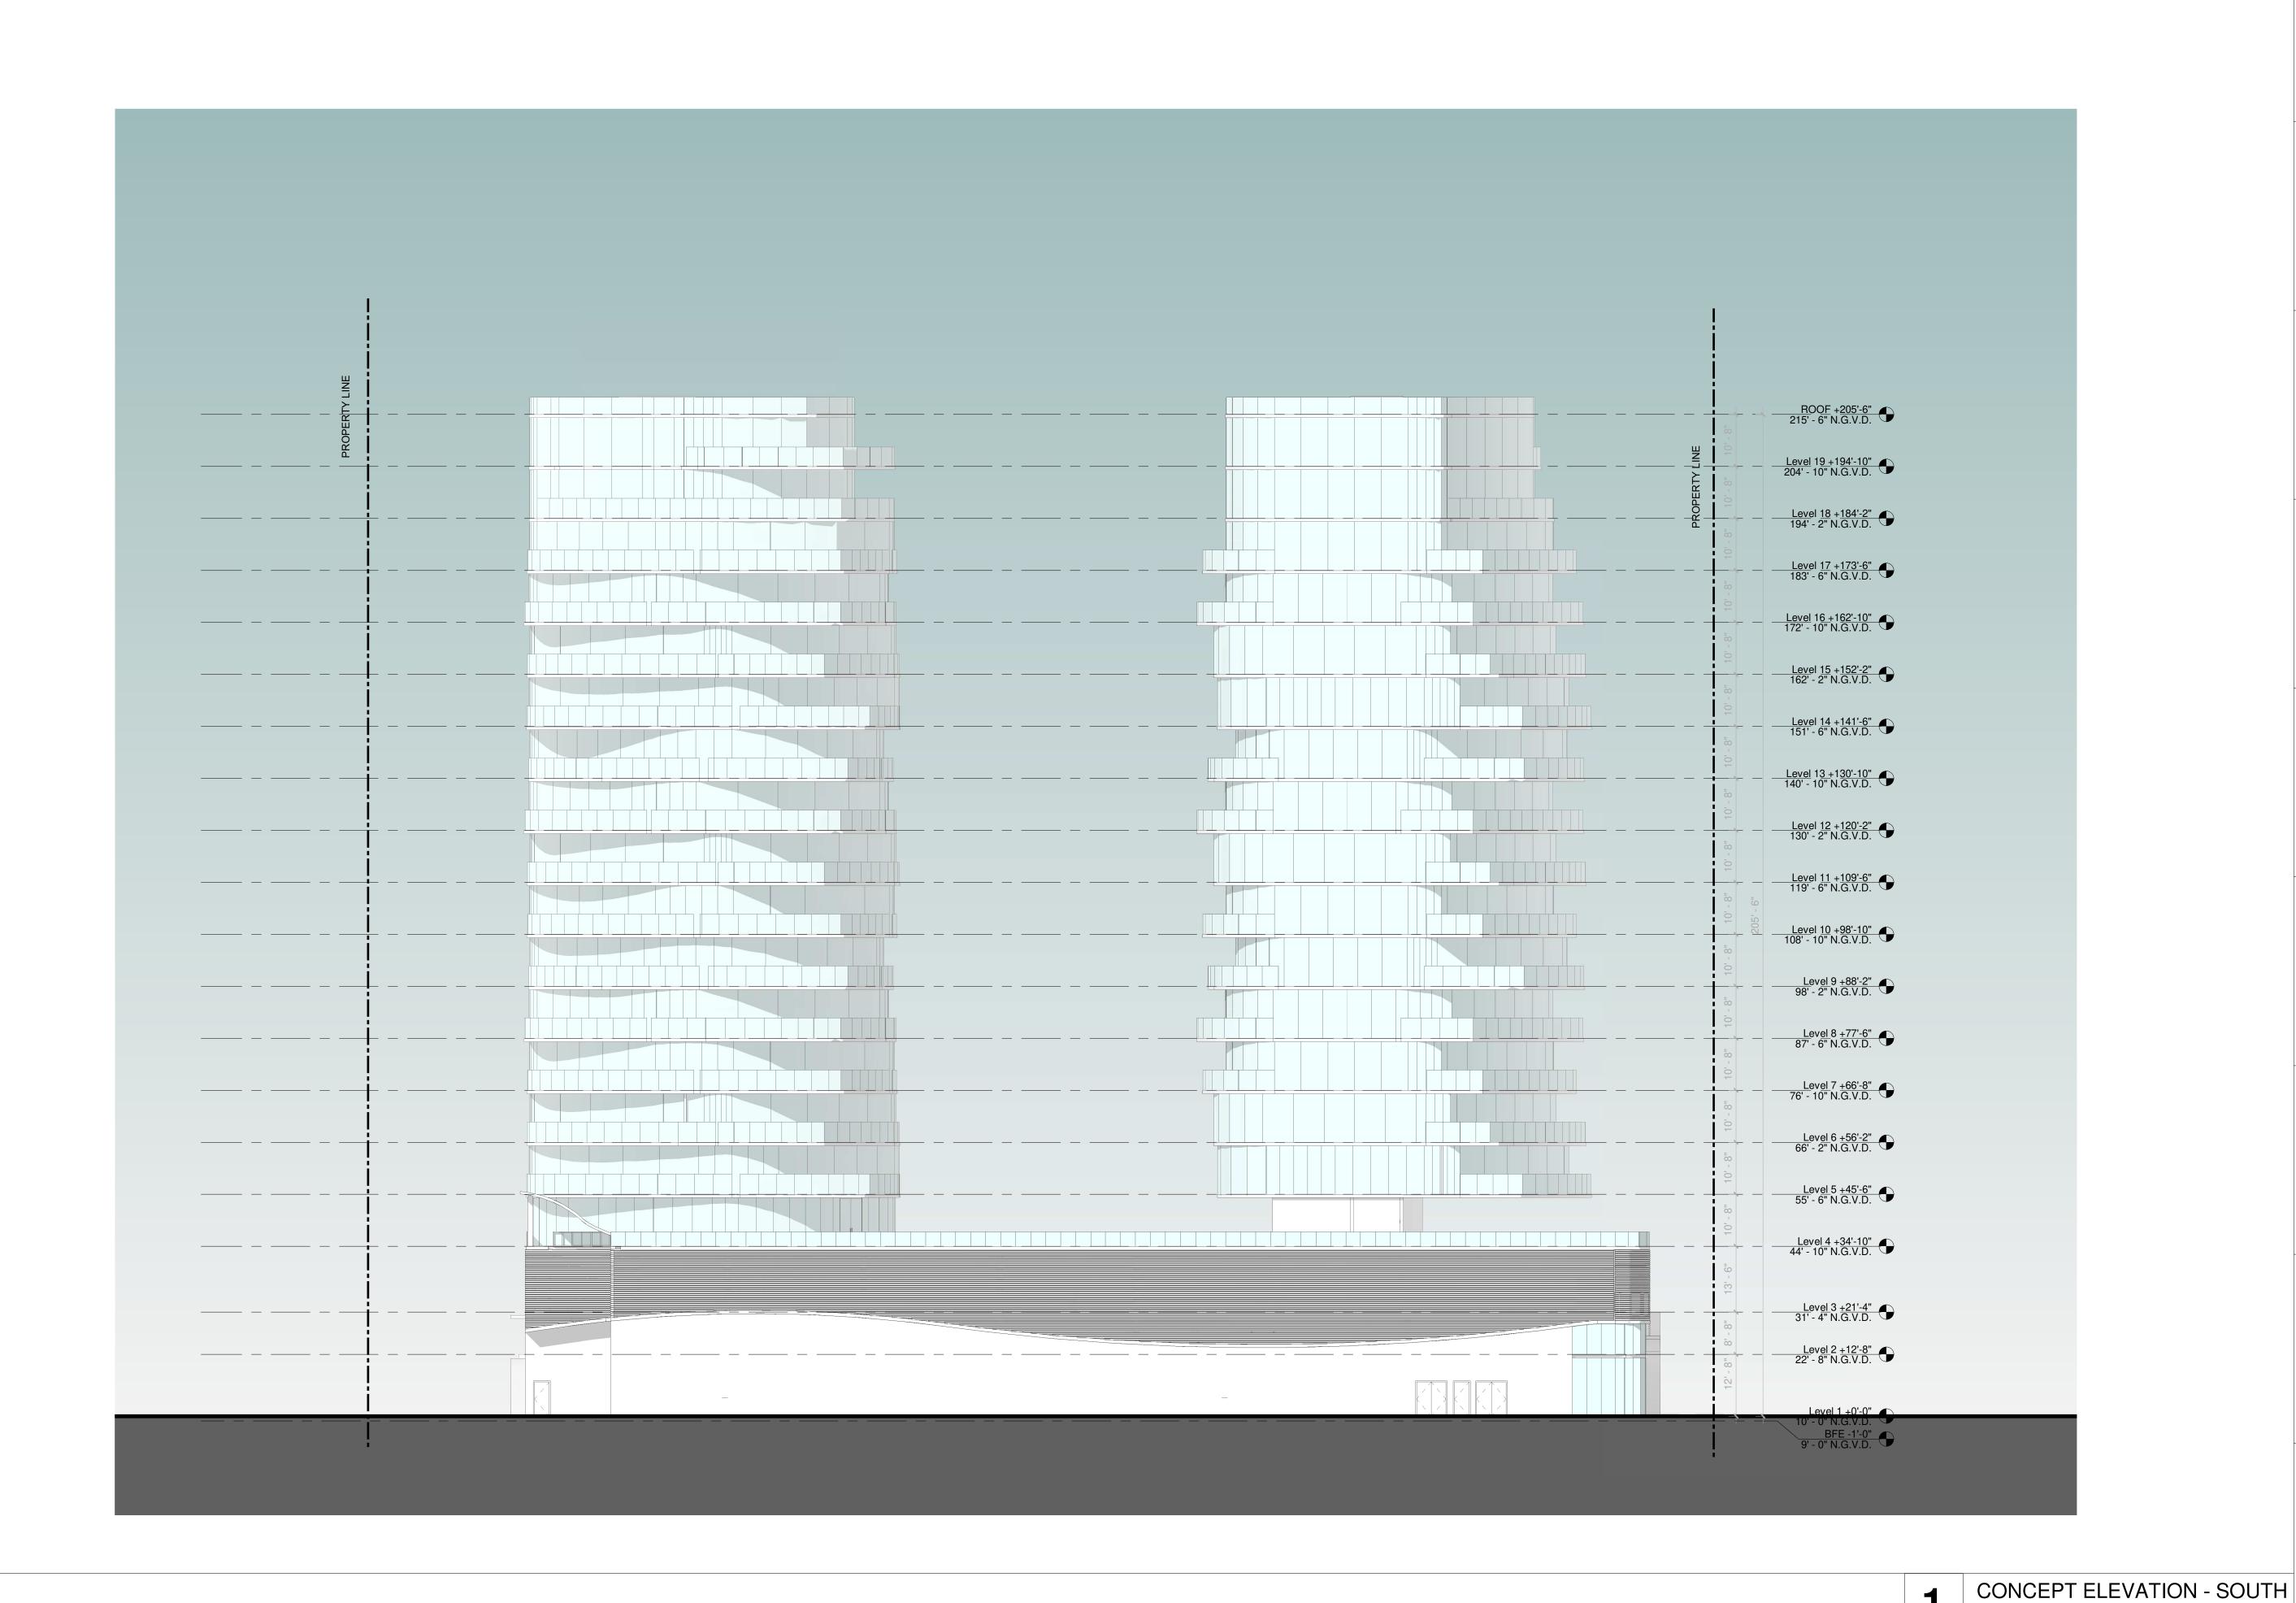

## **OCEAN PARK BEACH RESIDENCES**

1508 N OCEAN BLVD POMPANO BEACH, FL | 33062 Mount Vernon Property Holdings, LLC 219 NW 12th Ave. #812 Miami, FL 33128

OWNER

ARCHITECT:



CONSULTING ENGINEERS: STRUCTURAL ENGINEER:

CIVIL ENGINEER:

LEED CONSULTANT:

LANDSCAPE:

Reviewed for CODE COMPLIANCE

S	Signature	D	ate
P. Works		_/_	_/_
Fire Prev		_/_	_/_
Planning		_	_/_
Zoning		_/_	_/_
Building		_/_	_/_
Structural		_/_	_/_
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## **SCHEMATIC DESIGN**

ISSUE DATE: **REVISIONS:** 


SCALE:

CONCEPT ELEVATION - SOUTH

TO THE BEST OF THE ARCHITECT'S OR ENGINEER'S KNOWLEDGE, THE PLANS AND SPECIFICATIONS COMPLY WITH THE APPLICABLE MINIMUM BUILDING CODES AND THE APPLICABLE FIRE-SAFETY STANDARDS

AS DETERMINED BY THE LOCAL AUTHORITY

1/16" = 1'-0"

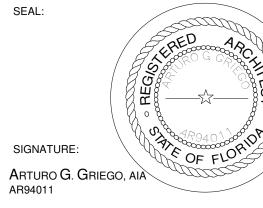

SHEET No.:

SCALE 1/16" = 1'-0"



## OCEAN PARK BEACH RESIDENCES

1508 N OCEAN BLVD POMPANO
BEACH, FL | 33062
Mount Vernon Property
Holdings, LLC
219 NW 12th Ave. #812 Miami, FL 33128

OWNER

ARCHITECT:



CONSULTING ENGINEERS:

STRUCTURAL ENGINEER:

MEP:

CIVIL ENGINEER:

LEED CONSULTANT:

LANDSCAPE:

Reviewed for CODE COMPLIANCE

	Signature	Date
P. Works		//
Fire Prev		
Planning		/_/_
Zoning		/
Building		//
Structural		
Electrical		/
Plumbing		/
Mech		//

## SCHEMATIC DESIGN

PROJECT No.:
ISSUE DATE:

S. Waste\_\_\_

CONCEPT RENDERING

SCALE:

TO THE BEST OF THE ARCHITECT'S OR ENGINEER'S
KNOWLEDGE, THE PLANS AND SPECIFICATIONS
COMPLY WITH THE APPLICABLE MINIMUM BUILDING
CODES AND THE APPLICABLE FIRE-SAFETY
STANDARDS
AS DETERMINED BY THE LOCAL AUTHORITY

SEAL:

SIGNATURE:

ARTURO G. GRIEGO, AIA
AR94011

SHEET No.:

A3-1.01



PROJECT, ADDRESS AND OWNER:

### **OCEAN PARK BEACH RESIDENCES**

1508 N OCEAN BLVD POMPANO BEACH, FL | 33062 Mount Vernon Property Holdings, LLC 219 NW 12th Ave. #812 Miami, FL 33128

ARCHITECT:



CONSULTING ENGINEERS: STRUCTURAL ENGINEER:

OWNER

CIVIL ENGINEER:

LEED CONSULTANT:

LANDSCAPE:

Reviewed for CODE COMPLIANCE

Signature P. Works\_\_\_\_\_

## SCHEMATIC DESIGN

S. Waste

PROJECT No.: ISSUE DATE: **REVISIONS:** 

CONCEPT RENDERING


SCALE:

TO THE BEST OF THE ARCHITECT'S OR ENGINEER'S
KNOWLEDGE, THE PLANS AND SPECIFICATIONS
COMPLY WITH THE APPLICABLE MINIMUM BUILDING
CODES AND THE APPLICABLE FIRE-SAFETY
STANDARDS
AS DETERMINED BY THE LOCAL AUTHORITY

SIGNATURE: ARTURO G. GRIEGO, AIA

AR94011 SHEET No.:

A3-1.02

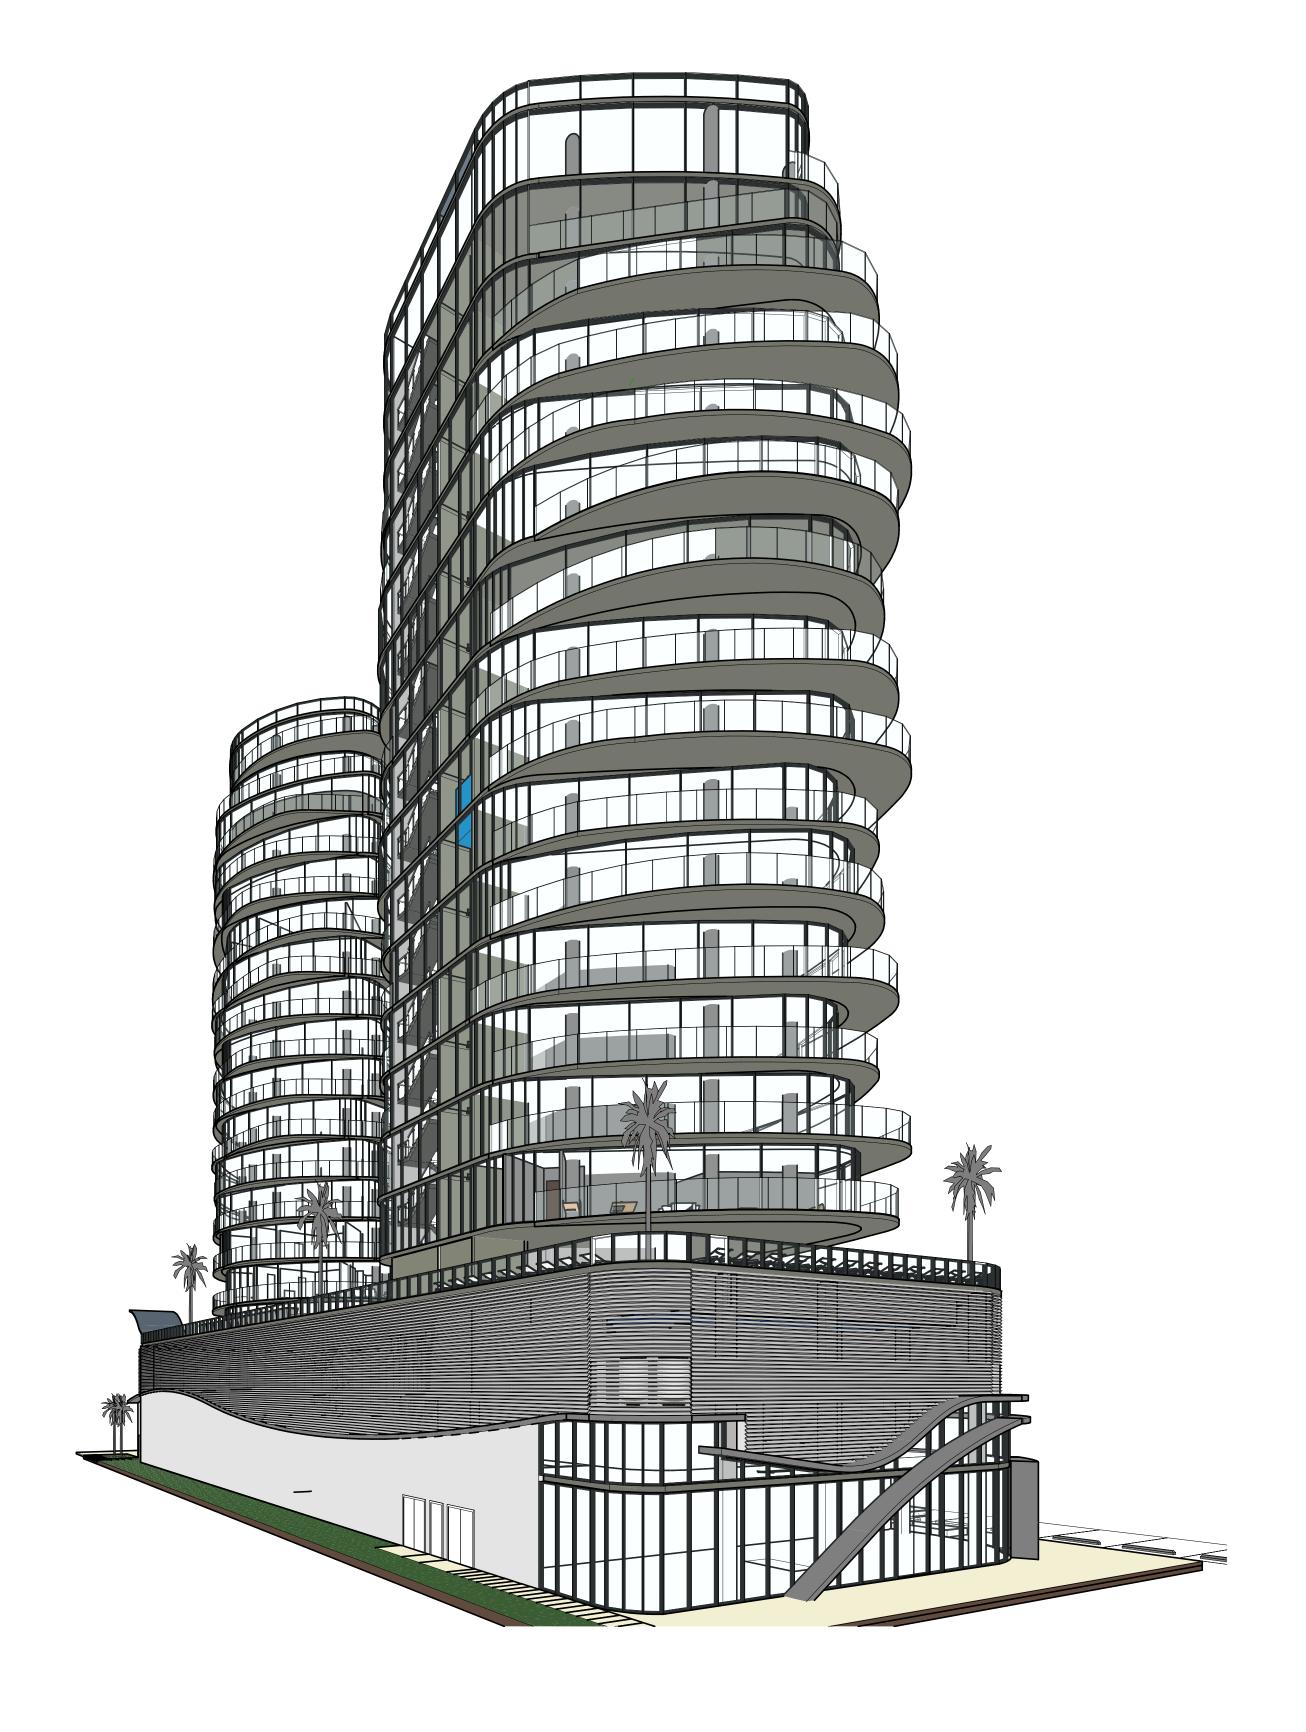

PROJECT, ADDRESS AND OWNER:

### **OCEAN PARK BEACH RESIDENCES**

1508 N OCEAN BLVD POMPANO BEACH, FL | 33062 Mount Vernon Property Holdings, LLC 219 NW 12th Ave. #812 Miami, FL 33128

ARCHITECT:



CONSULTING ENGINEERS: STRUCTURAL ENGINEER:

CIVIL ENGINEER:

LEED CONSULTANT:

Reviewed for CODE COMPLIANCE

Signature	Date
P. Works	//
Fire Prev	
Planning	//
Zoning	
Building	//
Structural	
Electrical	//
Plumbing	//
Mech	/ /

### SCHEMATIC DESIGN

PROJECT No.: ISSUE DATE:

CONCEPT RENDERING

SCALE:

TO THE BEST OF THE ARCHITECT'S OR ENGINEER'S
KNOWLEDGE, THE PLANS AND SPECIFICATIONS
COMPLY WITH THE APPLICABLE MINIMUM BUILDING
CODES AND THE APPLICABLE FIRE-SAFETY
STANDARDS
AS DETERMINED BY THE LOCAL AUTHORITY


SIGNATURE: ARTURO G. GRIEGO, AIA


AR94011


SHEET No.:

A3-1.03

# **EXHIBIT F**

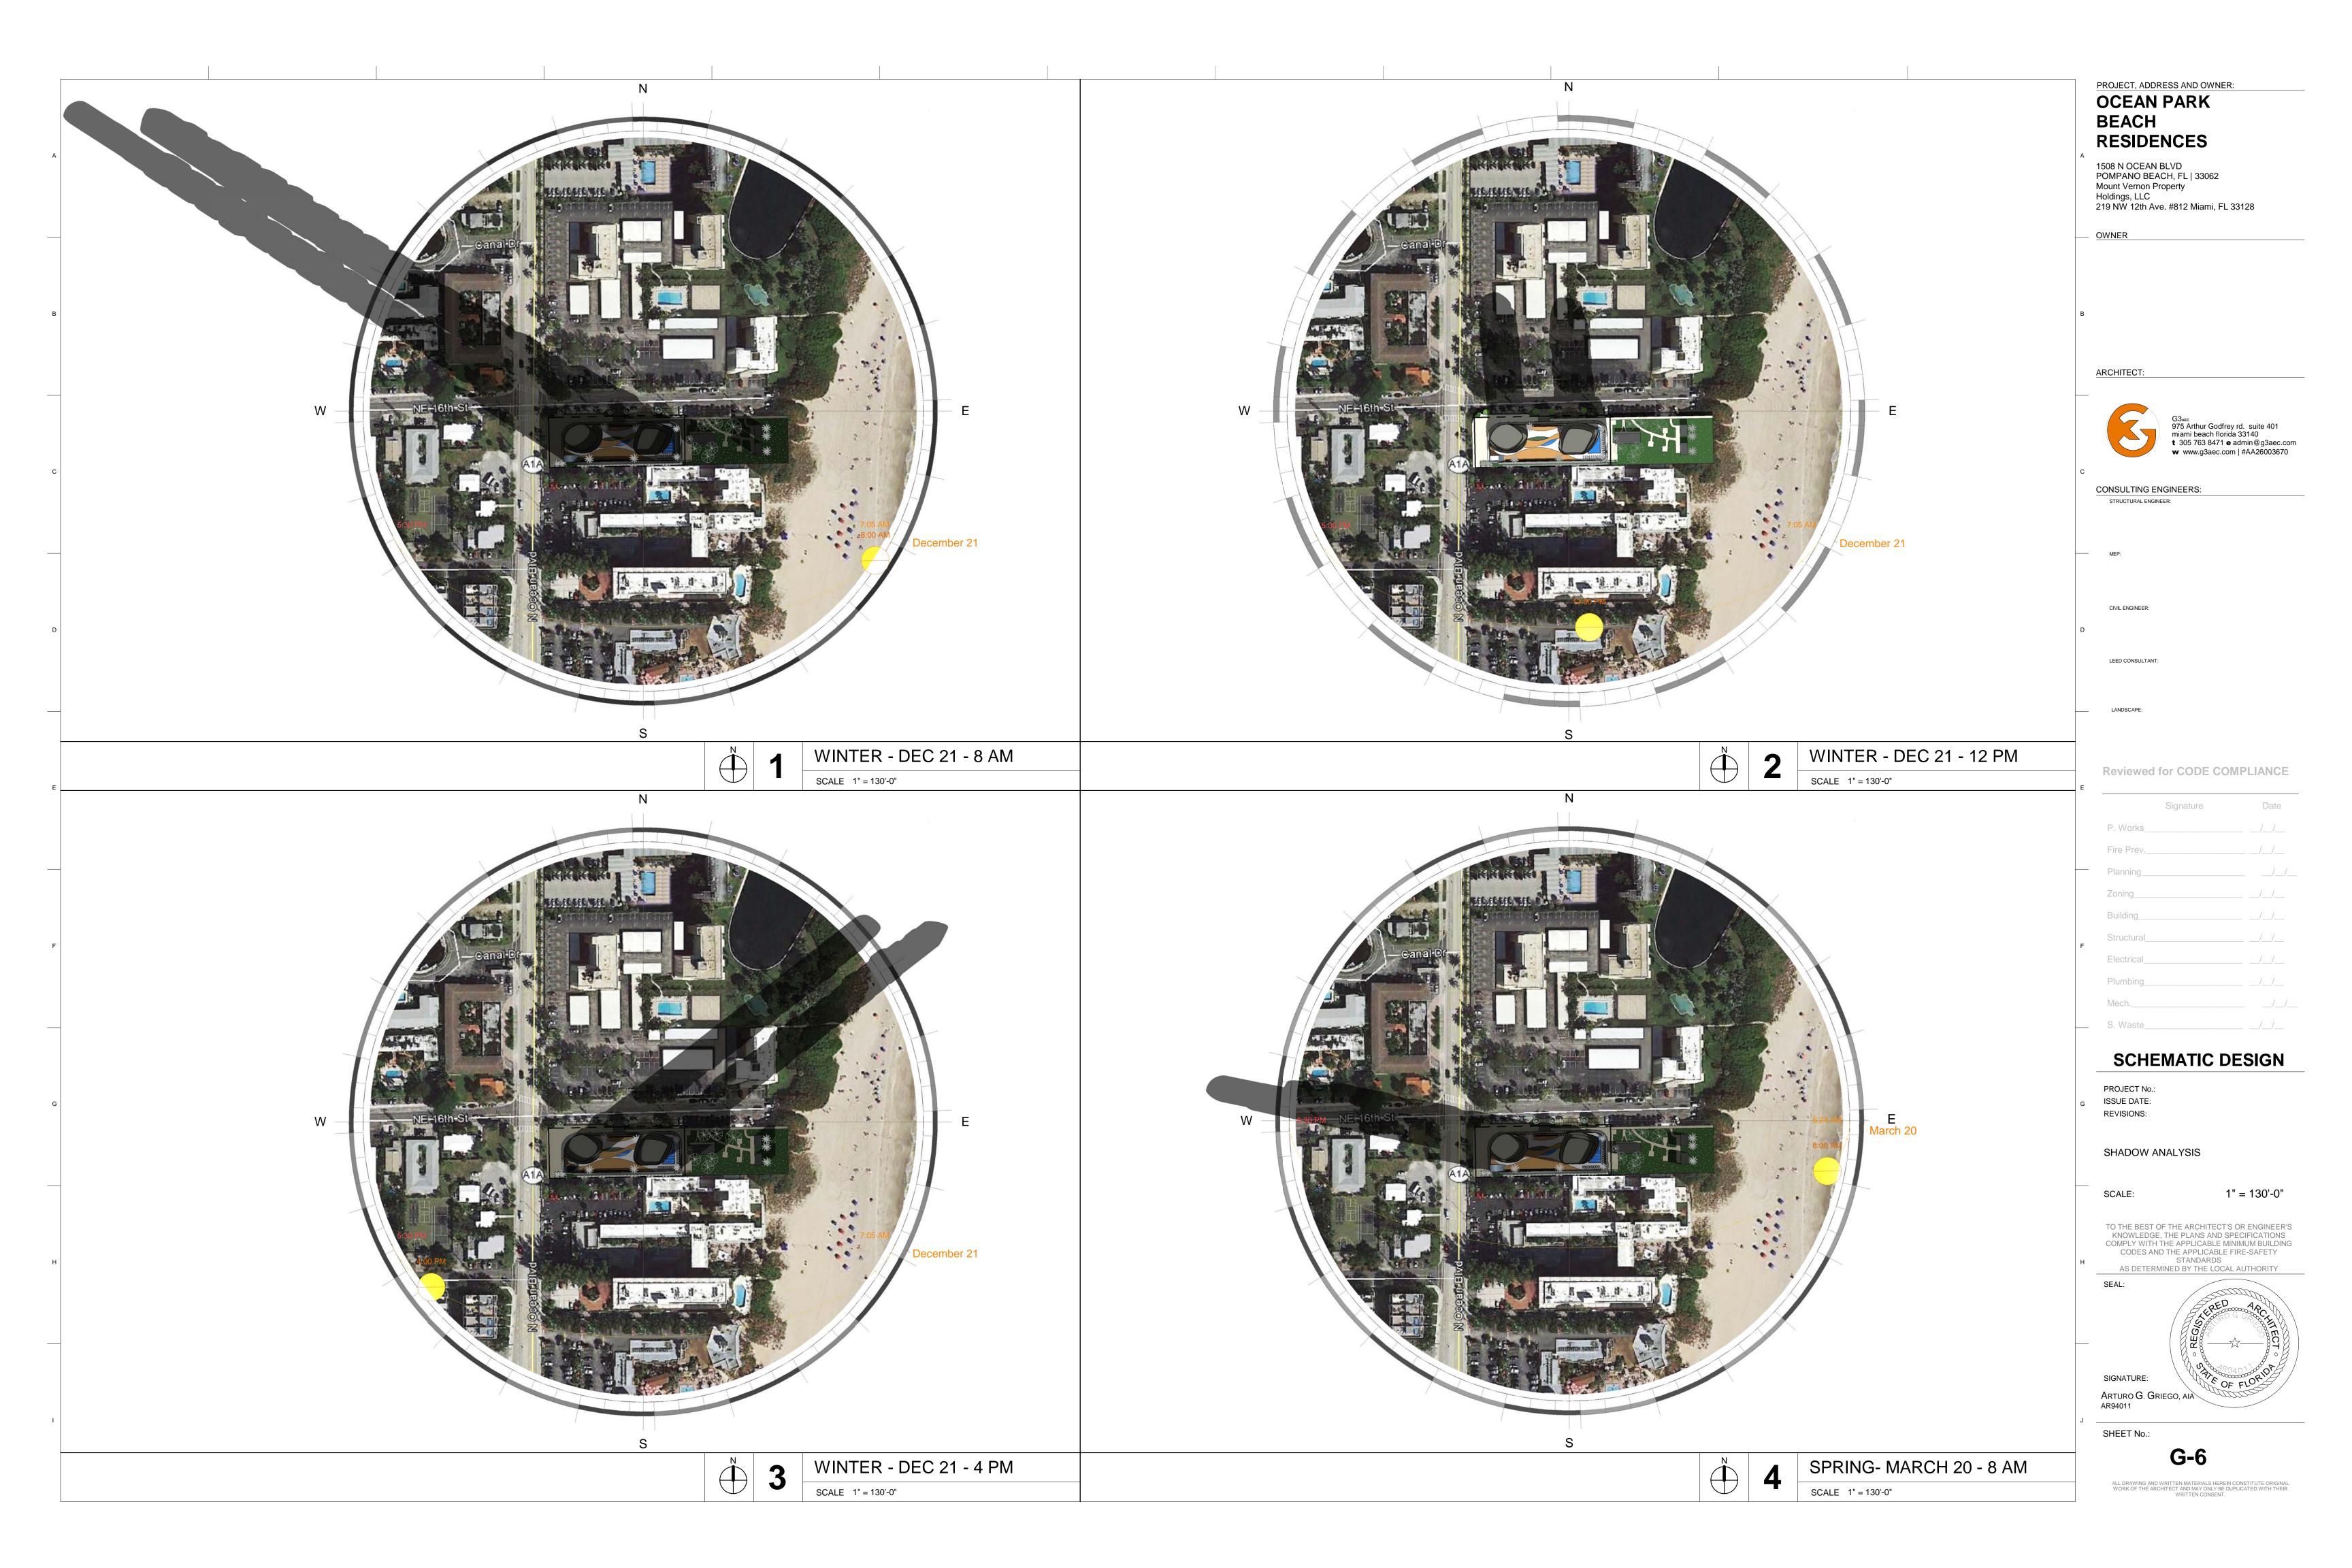

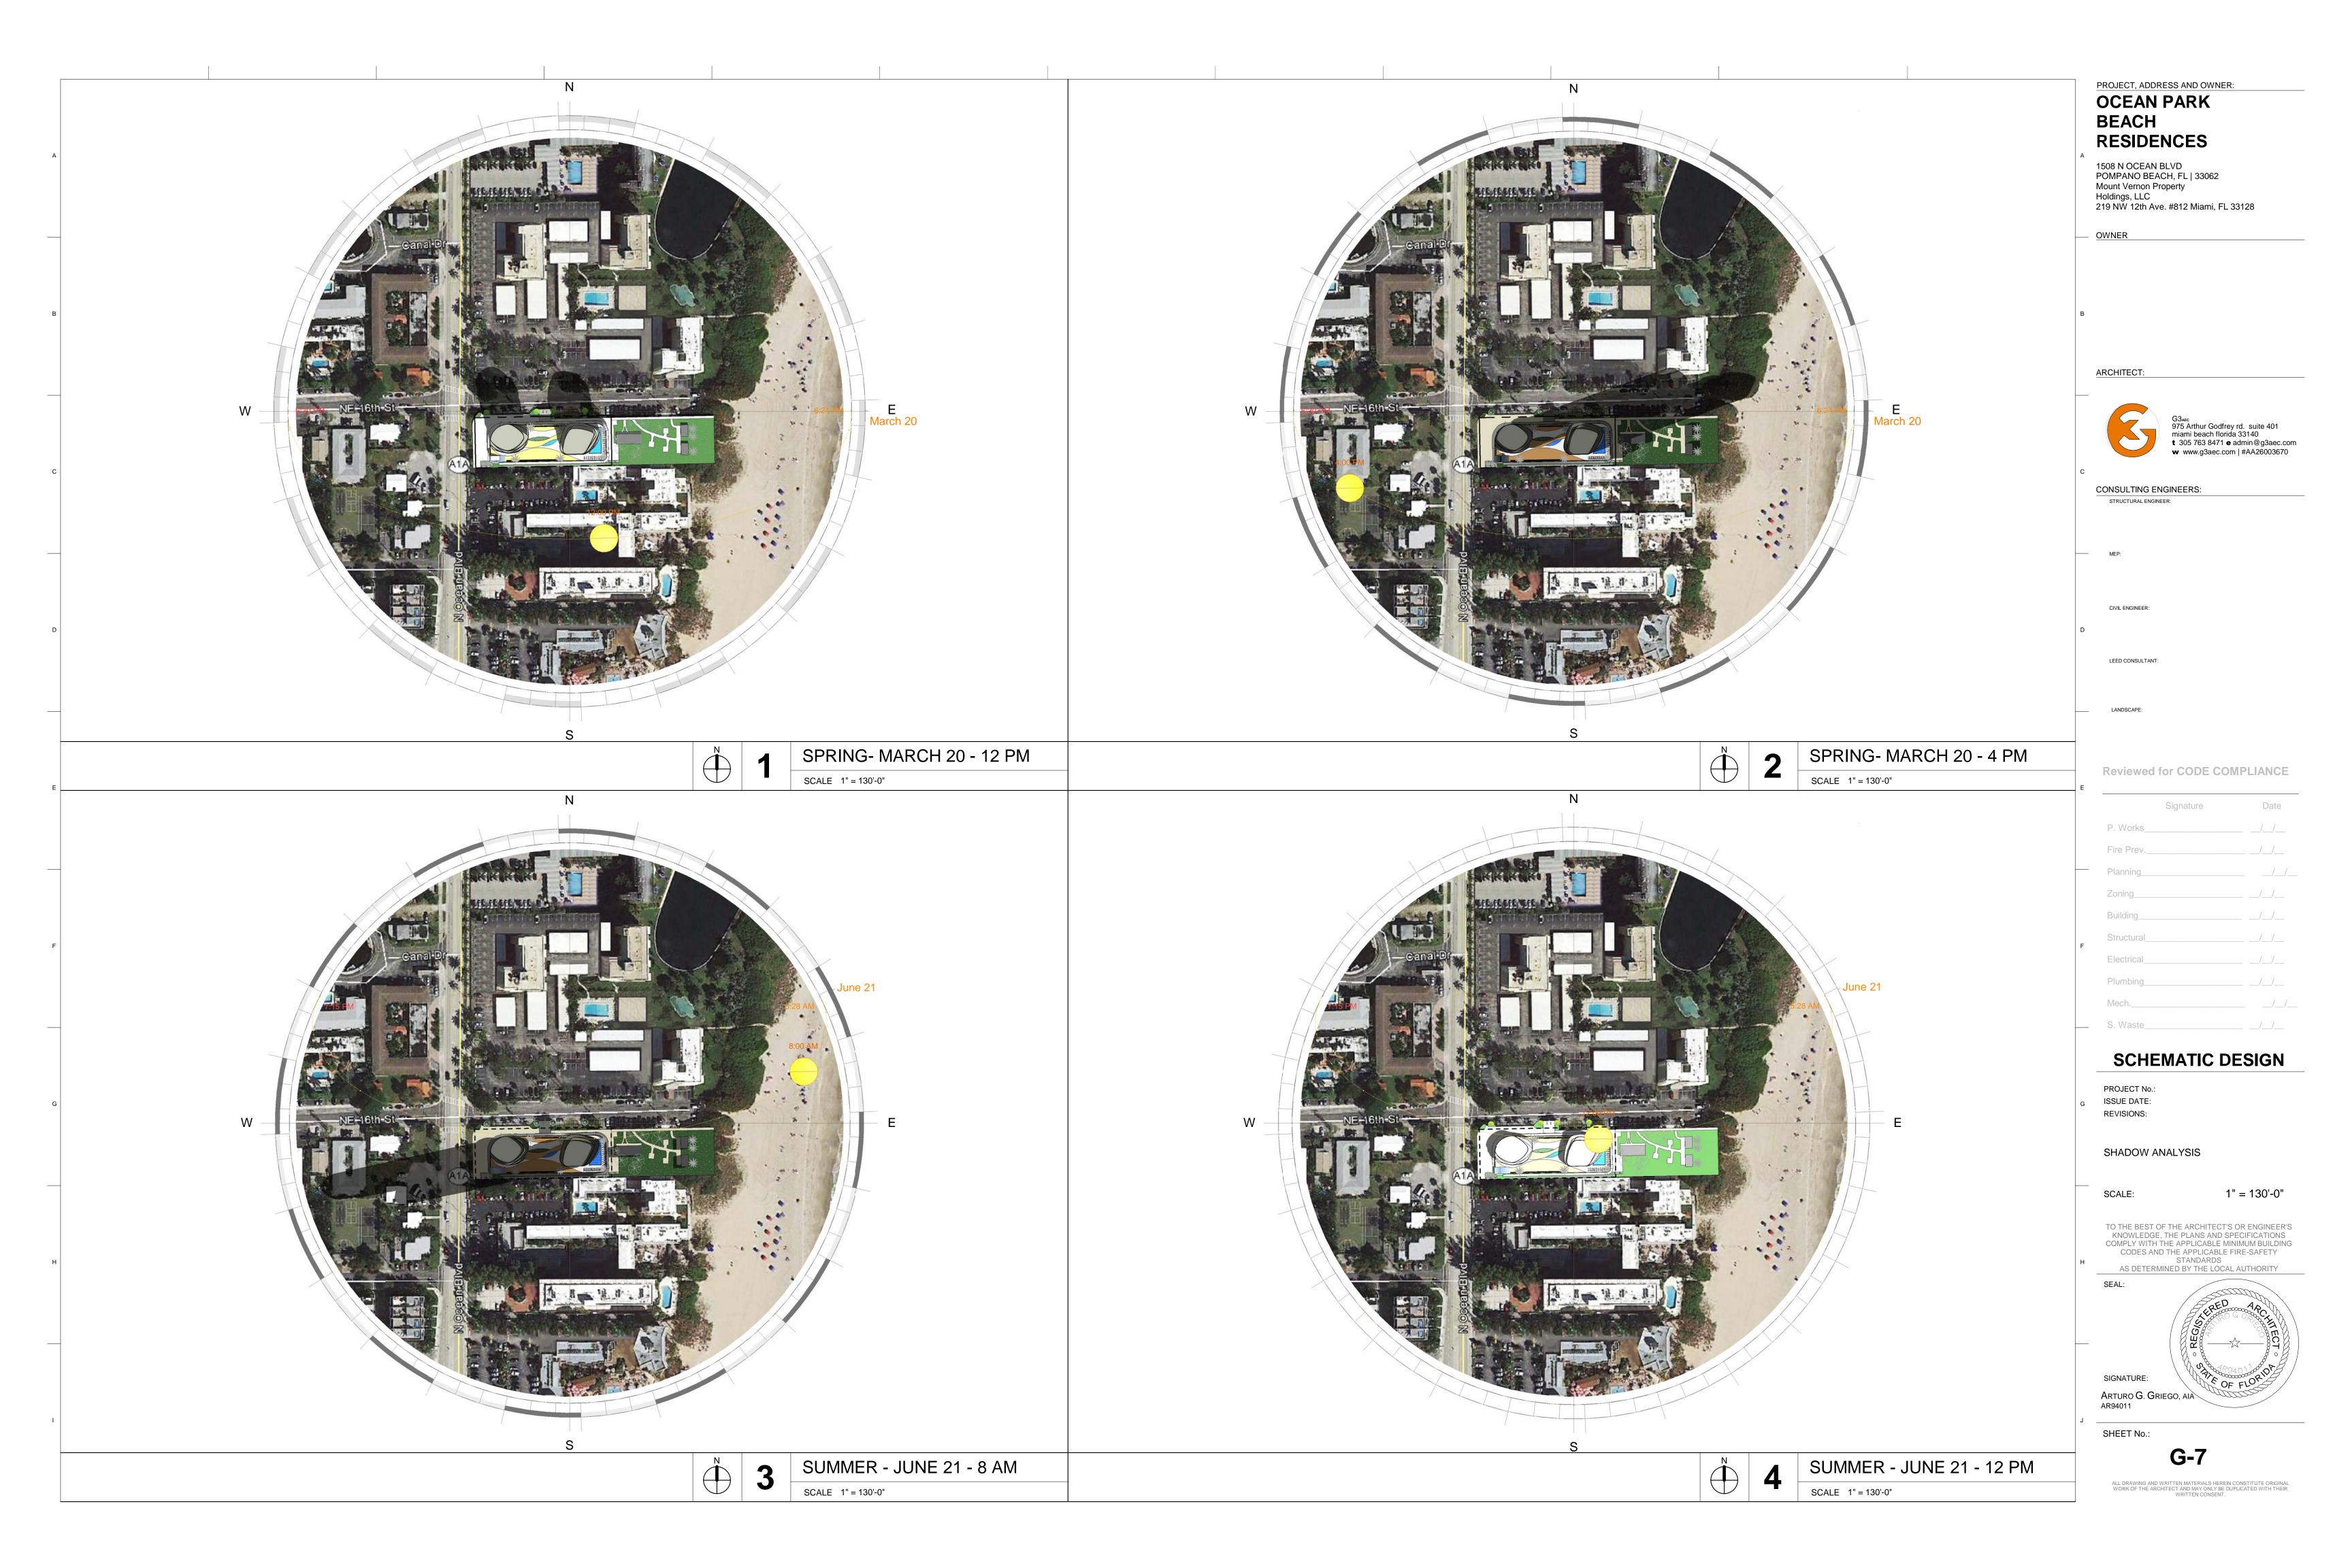

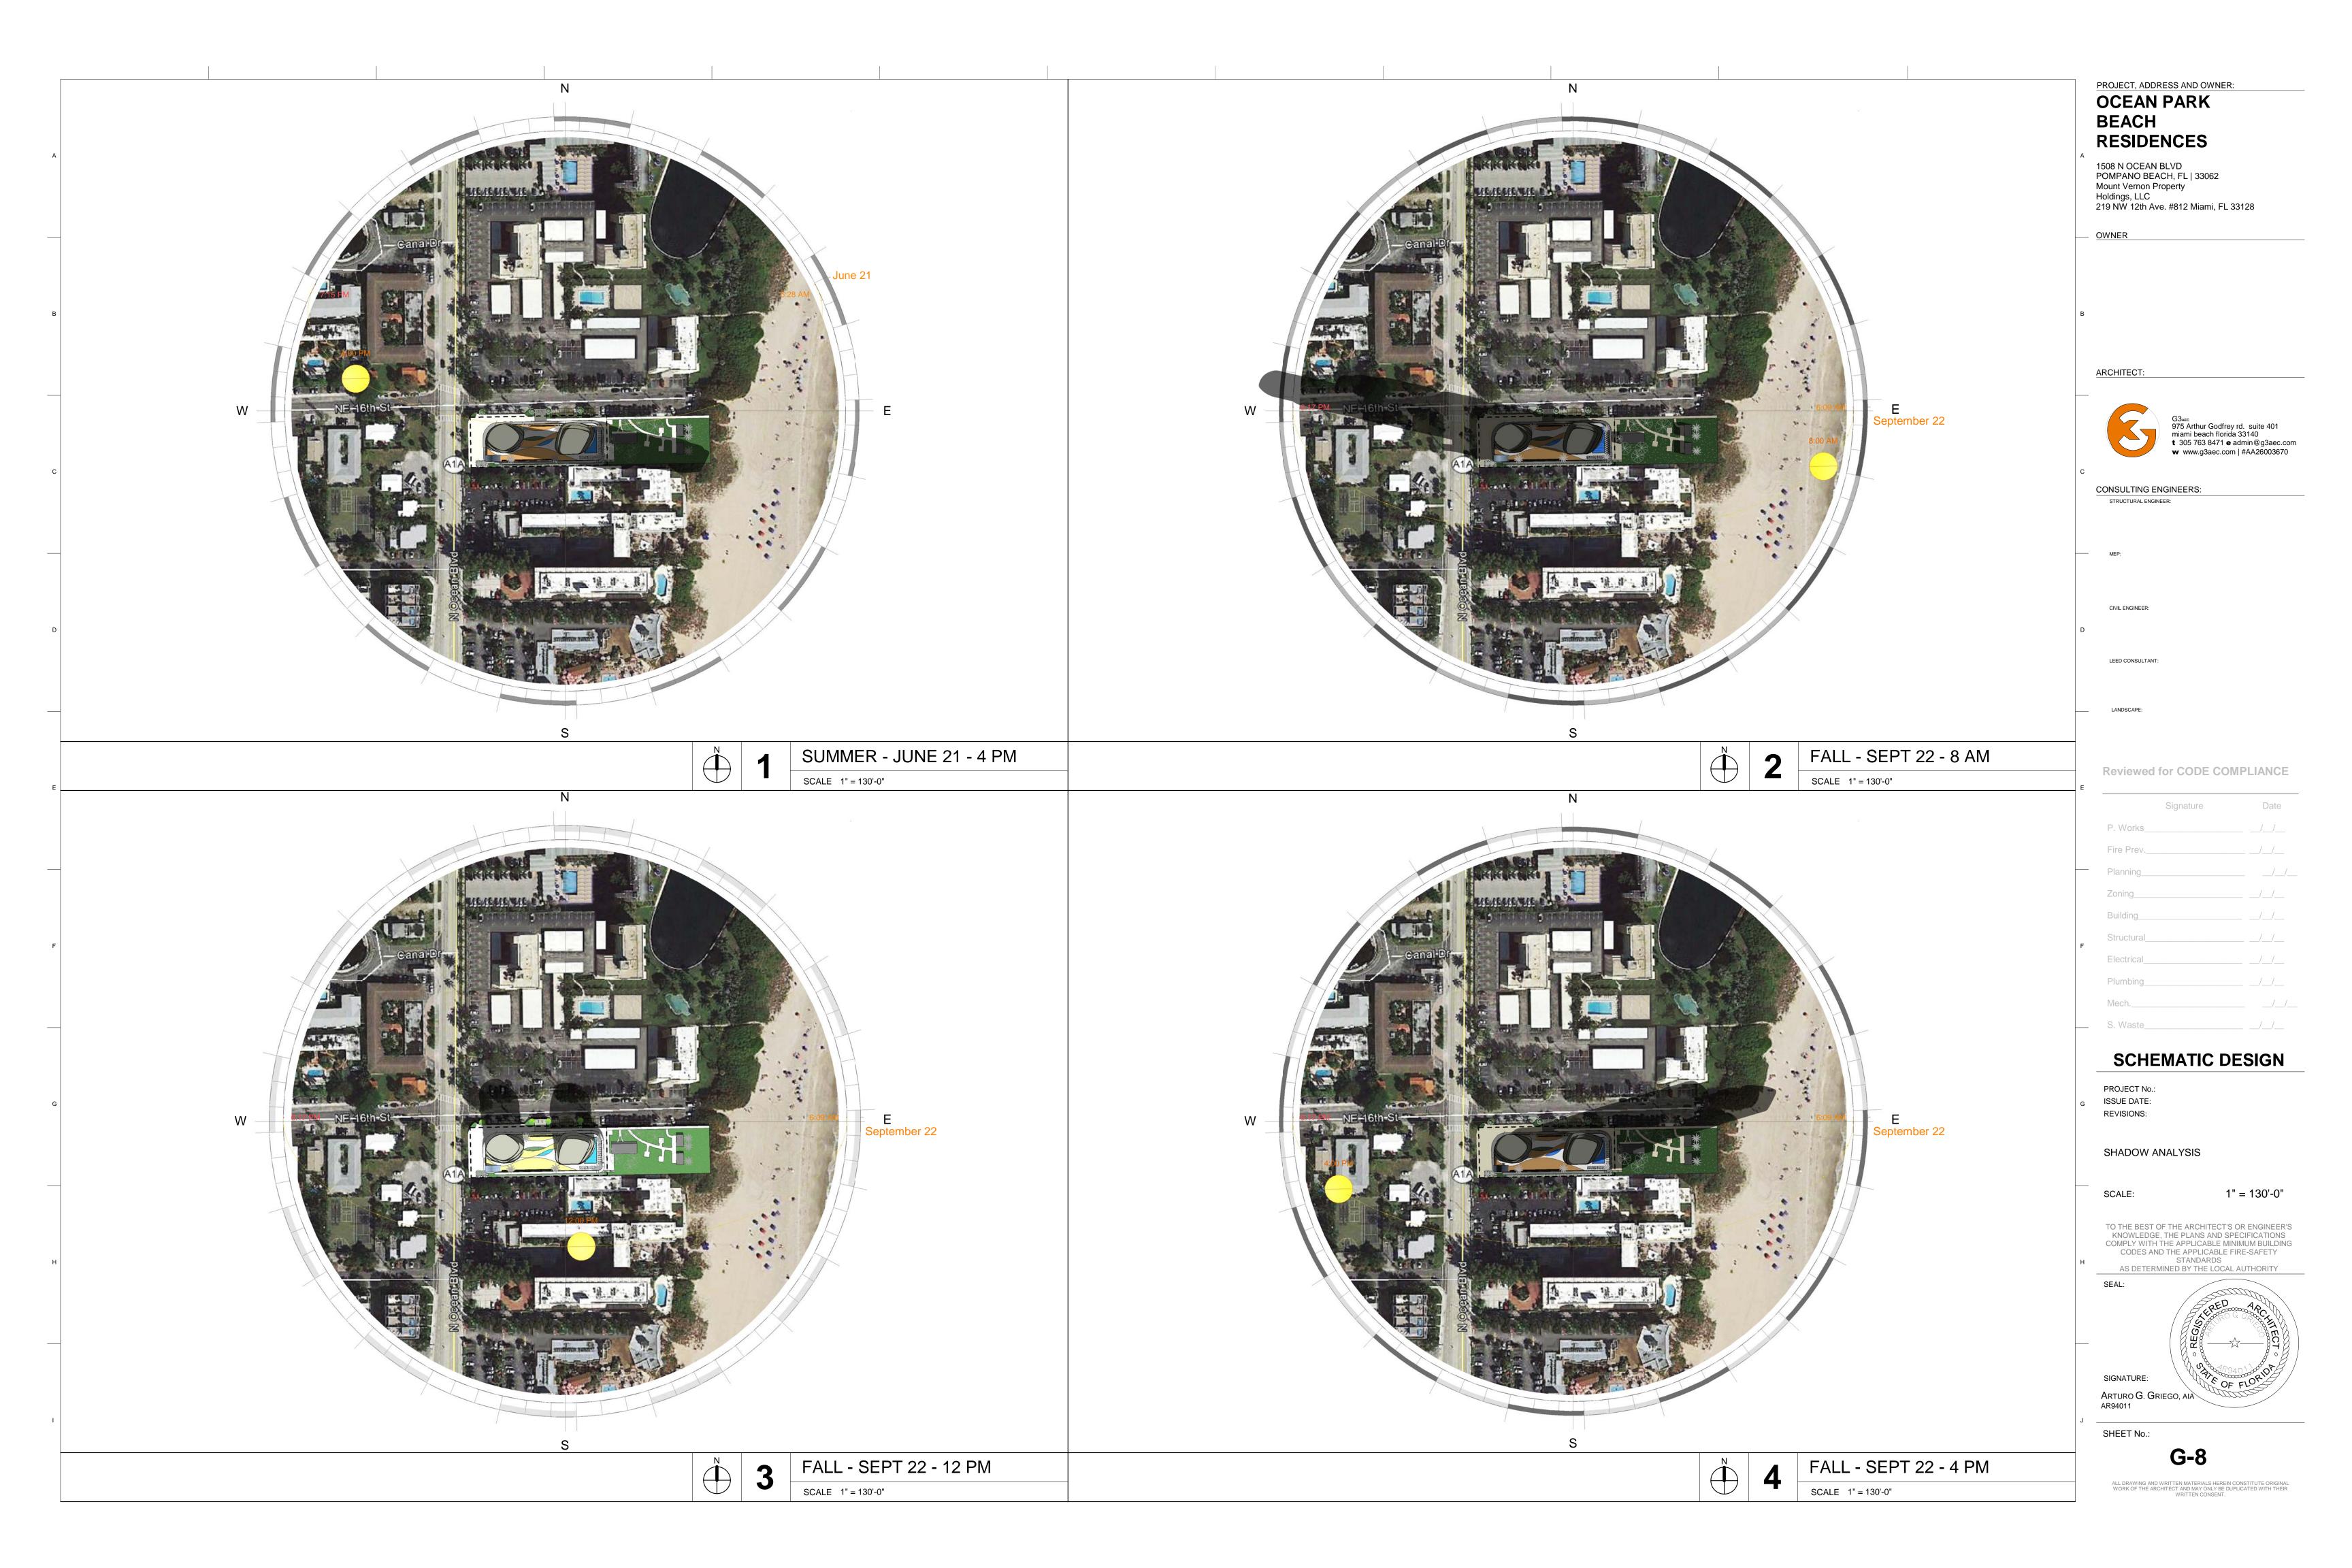

# **EXHIBIT G**



PROPOSED PARKING LAYOUT FOR TIFFANY GARDEN
NE 16TH STREET AND N OCEAN BLVD POMPANO BEACH, FL 33062

DRAWING
UNIT "A" AREA OF VIEW
SCALE
1/32"=1'-0"

V-1

08-10-17

OWNER

A R C H I T E C T 14850 NW 44th Ct | suite 202 miami florida 33054 t 305 673 2121 f 305 673 4640 w www.itecdesign.net





PROPOSED PARKING LAYOUT FOR TIFFANY GARDEN NE 16TH STREET AND N OCEAN BLVD POMPANO BEACH, FL 33062

UNIT "B" AREA OF VIEW SCALE 1/32"=1'-0"

08-10-17

14850 NW 44th Ct | suite 202 miami florida 33054 t 305 673 2121 f 305 673 4640 w www.itecdesign.net



PROPOSED PARKING LAYOUT FOR TIFFANY GARDEN NE 16TH STREET AND N OCEAN BLVD POMPANO BEACH, FL 33062

DRAWING UNIT "C" AREA OF VIEW SCALE 1/32"=1'-0"

08-10-17

OWNER

14850 NW 44th Ct | suite 202 miami florida 33054 t 305 673 2121 f 305 673 4640 w www.itecdesign.net







NE 16TH STREET AND N OCEAN BLVD POMPANO BEACH, FL 33062

SCALE 1/32"=1'-0"

14850 NW 44th Ct | suite 202 miami florida 33054 t 305 673 2121 f 305 673 4640 w www.itecdesign.net

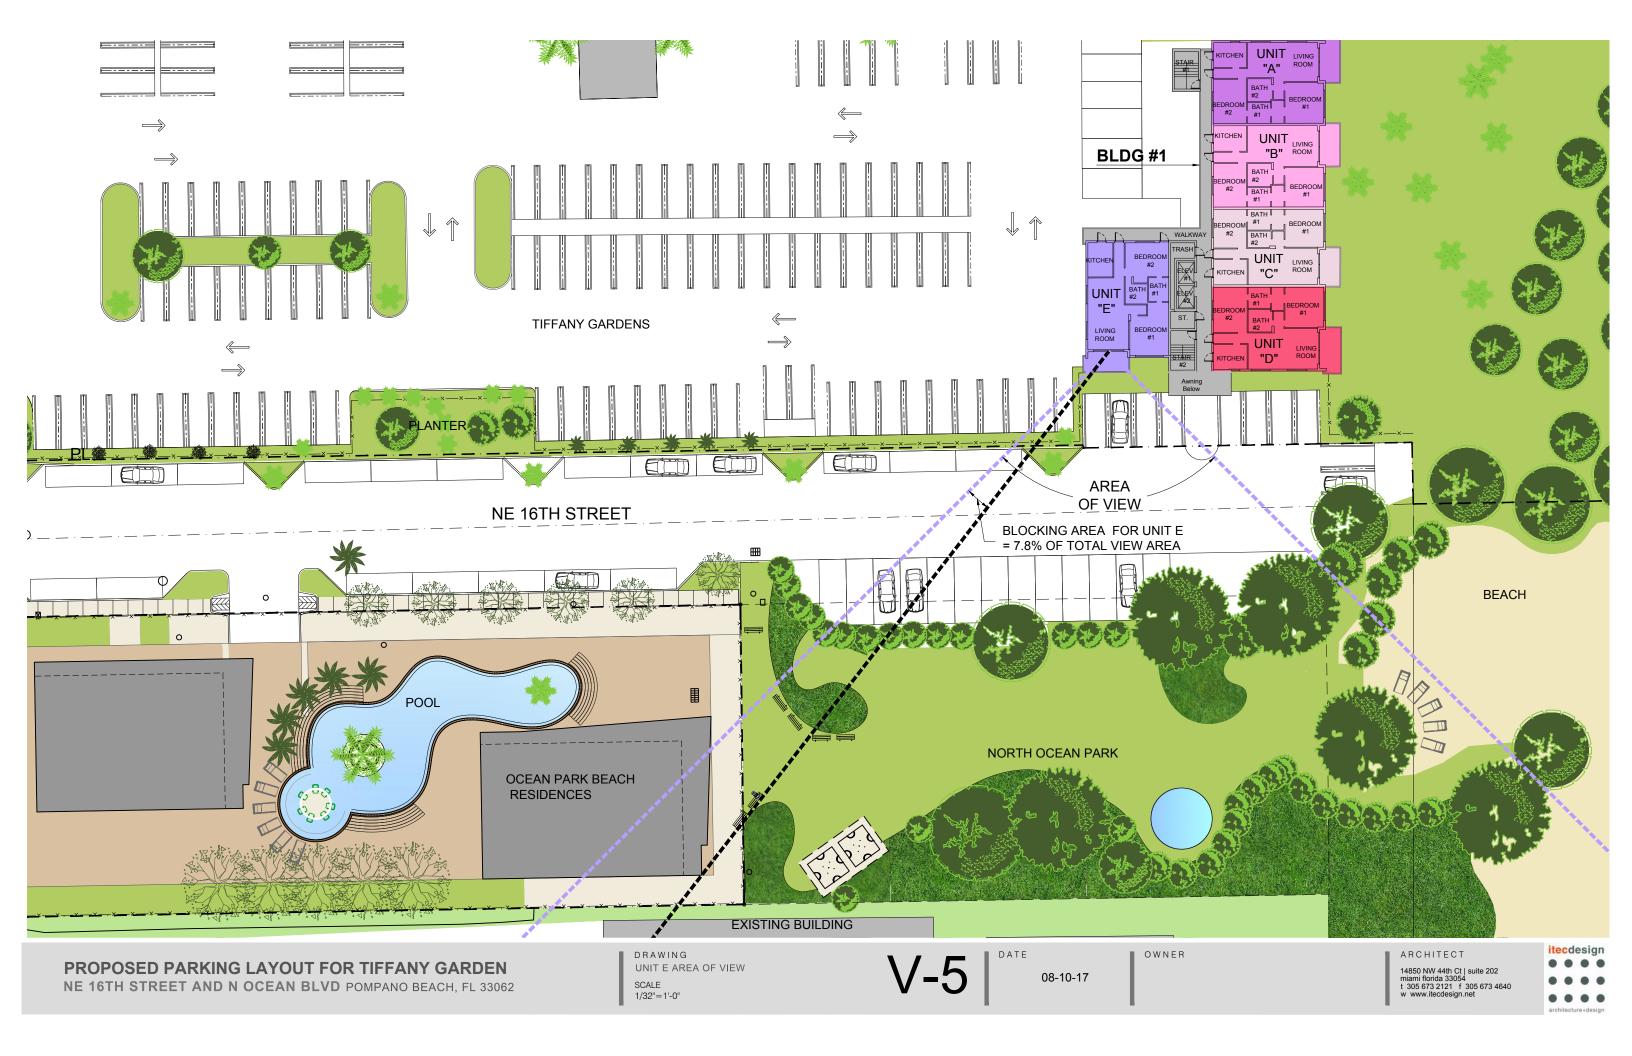

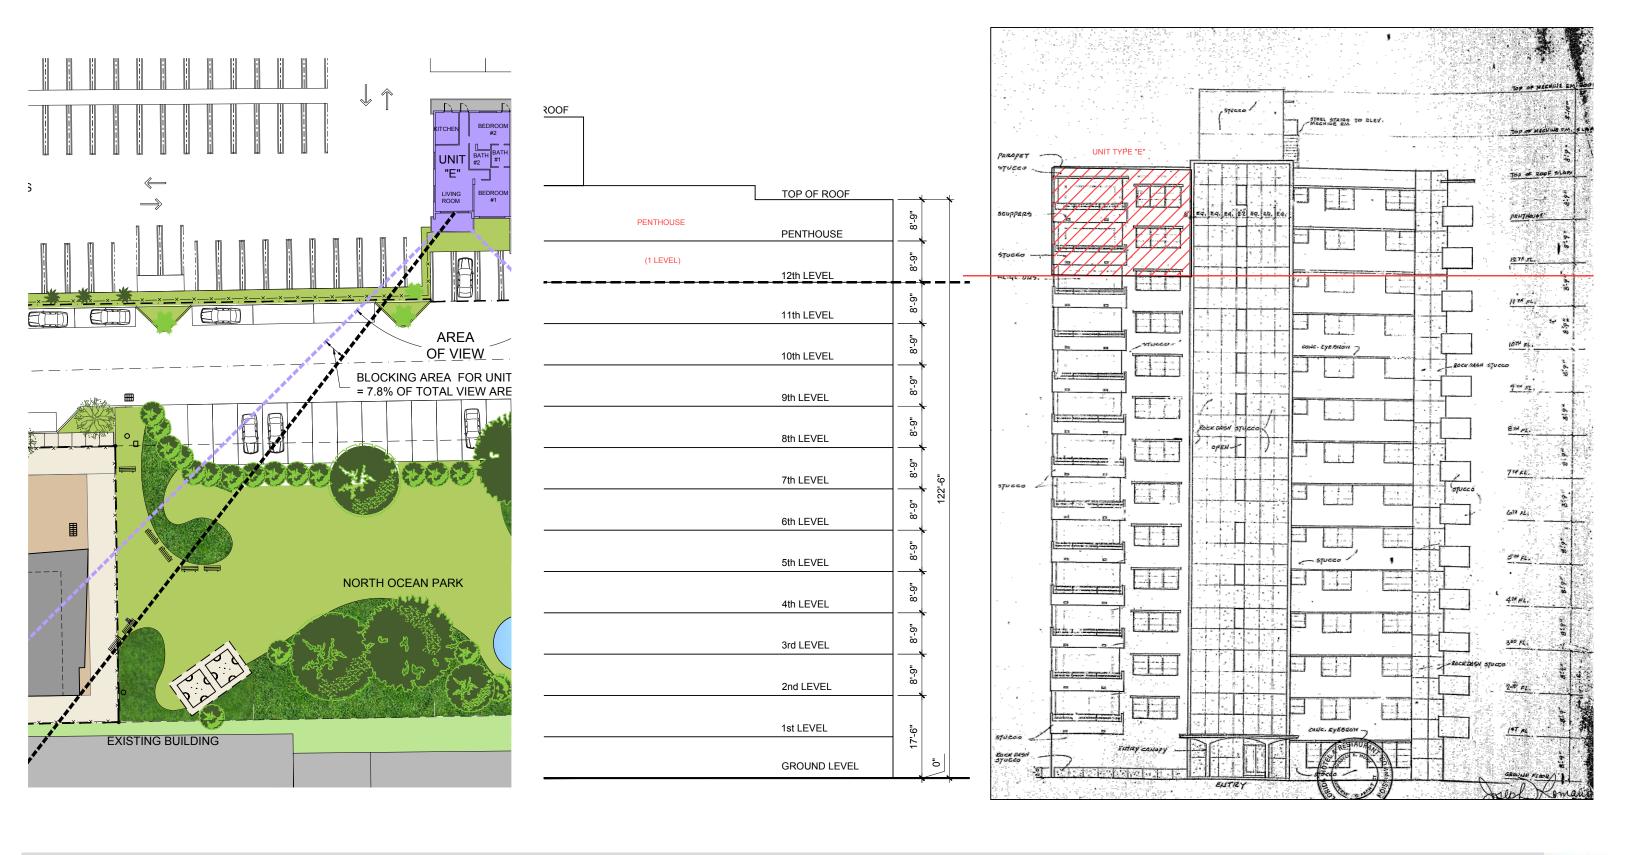

08-10-17



## **EXHIBIT H**

#### Applicable Comprehensive Plan Policies and Responses

The following list of comprehensive plan policies are those policies identified by the Project Team and by City staff that apply to this project. Below each policy, the project team includes a narrative describing how the project meets, achieves, or exceeds each of the policies.

- Future Land Use Map Designation The proposed PD-I zoning designation and the proposed uses are consistent with the City's Residential High (H 25-46 DU/AC) land use designation for the property
- **Goal 01.00.00** The attainment of a living environment which provides the maximum physical, economic and social well-being for the City and its residents through the thoughtful and planned use and control of the natural and man-made environments that discourages urban sprawl, is energy efficient and reduces greenhouse gas emissions.

The project supports Goal 1, providing for the physical, economic and social well-being for the City and its residents, by utilizing an infill parcel to develop relatively dense residential development, as opposed to building sprawling, low-density, residential development elsewhere. The proposed infill development discourages sprawl, since it is in an already developed area. Infill development is more energy efficient because residents are closer to goods and services than sprawling development typically is, which reduces greenhouse gases generated by residents. Infill development also allows for more efficient delivery of services, reducing sprawling infrastructure and allowing the City to provide services cost effectively.

 Policy 01.01.06 All site plan applications shall provide pedestrian facilities, such as but not limited to sidewalks and street trees (where not in conflict with underground utilities and permitted by City Engineer).

The proposed Site Plan incorporates landscaped, pedestrian walkways on AIA and along 16<sup>th</sup> street, between A1A and North Ocean Park. These walkways are not anticipated to conflict with utilities.

• **Objective 01.02.00** Protect the existing and future right-of-way from building encroachments and ensure proper accessibility with the roadway and transit network.

The project will require platting and will comply with all dedication requirements. The City has requested/required the dedication of right-of-way along A1A, which the applicant will comply with.

 Policy 01.03.01 Eliminate or reduce nonconforming uses which are inconsistent with the land development regulations and the designations of the Future Land Use Plan map.

The proposed uses residential and accessory non-residential uses are consistent with the land development regulations and are permitted within the FLUM designation and the existing and proposed zoning districts.

 Policy 01.03.05 All Land Use Plan Map amendments and rezonings shall provide for the orderly transition of varying residential land use designations.

The subject property, along with properties to the north and south are designated High (H) Density Residential, which allows up to 25-46 dwelling units per acre, pursuant to the City's Future Land Use Map<sup>1</sup>. Across A1A, property is designated Medium High (MH) Density Residential, which allows 16-25 dwelling units per acre. The proposed zoning district, Planned

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<sup>&</sup>lt;sup>1</sup> http://pompanobeachfl.gov/assets/docs/pages/planning\_zoning/land\_use.pdf

Development-Infill (PD-I), is consistent with the High Density Future Land Use Designation. The applicant does not propose a change to the future land use designation of the property. The City, in approving the Future Land Use Map, has already determined that the pattern of Future Land Use designations facilitates an orderly transition. The requested rezoning to the PD-I zoning category will allow site designers to create a feasible development on a relatively small infill parcel. The site is half the depth of adjacent properties and feasible development requires this flexible zoning category.

Policy 01.03.07 Require the provision of decorative structural or vegetative buffers between
different density residential land uses, and residential and non-residential land uses unless the
applicant can demonstrate by evidence that the proper buffer is provided.

The site density is consistent with properties to the north and the south, which are all within the RM-45 or RM-45/HR zoning districts. The site has a higher density than property across A1A, which is zoned RM-20. The proposed site plan will include the designated buffers, which the City deemed appropriate for buffering these densities.

• **Policy 01.03.10** Support and promote hotels, motels and other tourist accommodations in designated residential, commercial and commercial recreation land use designations.

The proposed development is not a hotel, motel, or tourist accommodation. The proposed development will include a commercial component intended to support the local population.

 Policy 01.03.11 Consider the compatibility of adjacent land uses in all Land Use Plan amendments and rezonings.

The proposed rezoning is compatible with adjacent land uses. The subject property and properties to the north and south are designated High Density on the Future Land Use Map. The property to the north is designated RM-45, High Rise, which allows development with unlimited height. Property to the south is designated RM-45, which allows development up to 105 feet. The proposed Planned Development – Infill (PD-I) designation allows the applicant to provide their own regulations. The proposed development's zoning height is 205'-6", which provides a transition between the unlimited height to the north, and 105 feet to the south. Property to the west is designated RM-20, which allows a 35-foot height. A similar configuration of high-rise development on the east and RM-20 on the west side of Ocean is common throughout the City on the barrier island.

- Policy 01.03.12 The following criteria may be used in evaluating rezoning requests:
  - 1. Density;

No increase in density requested and is within vested rights.

2. Design;

The project proposes an innovative design with two separated towers, which results in an open feeling that minimizes building bulk, and increases viewsheds. Any feasible building designed with the current zoning regulations would likely result in a bulkier, less innovative design.

3. Distance to similar development;

Property to the north and south have future land use designations and supportive zoning categories that allow the same density as this property. The adjacent property to the south is developed with the residences further to the east with a parking lot adjacent.

The property to the north has parking on the west portion with a residential tower on the east closest to the beach over 100 feet to the southeast.

4. Existing adjoining uses;

Two properties are adjacent to the site; a multi-story residential building to the south, and a city park to the east.

5. Proposed adjoining uses;

No proposed changes to existing developments.

6. Readiness for redevelopment of surrounding uses;

This site is one of the only vacant properties in the area. The west side of Ocean Avenue has the potential for redevelopment. There are some nonconforming buildings and uses on the west side of Ocean Avenue, and it is not unreasonable to surmise that these may be redeveloped in the near future.

7. Proximity to mass transit.

Bus service via route 11, the closest transit service to the site, only serves property as far north as NE 14<sup>th</sup> Street. The site is two blocks north of 14<sup>th</sup> Street.

 Objective Flood Protection 01.05.00 Require all new development and redevelopment to be consistent with Federal Emergency Management Administration's Flood Elevation Maps.

The project will meet applicable FEMA criteria.

• **Policy 01.06.01** Consider the impacts that land use amendments, rezonings or site plan approvals have on natural resources and historic properties.

The proposed site does not impact any historic resources and will not affect any natural resources on the property. Any proposed development on the property will be designed to protect sea turtle nests with appropriate lighting and a resident education program.

 Policy 01.07.02 Continually review and amend new land use designations for Residential, Mixed Use, Transportation Oriented Districts.

The project is an example how the PD-I designation can be utilized to create exciting developments that cannot fit into standard conditions.

 Policy 01.07.11 Through ongoing updates to the land development regulations develop new zoning districts that encourage redevelopment, including mixed uses along major highway corridors.

The project is an example how the seldom used PD-I can be utilized to create exciting developments that cannot fit into standard conditions.

 Policy 01.07.16 Through ongoing updates to the land development regulations provide criteria/ performance standards regulating hotel intensity and incentives for hotel development.

The proposed development is not a hotel. However, the City may update the land development regulations to ensure that appropriate criteria and performance standards for hotel intensity and incentives are codified.

• **Objective Urban Infill Criteria 01.12.00** Establish criteria which encourage development of urban infill and community redevelopment areas to promote economic development, increase housing opportunities and maximize the use of existing public facilities and services.

The project is an example how the seldom used PD-I can be utilized to create exciting developments that cannot fit into standard conditions.

Policy 01.16.01 The City shall emphasize re-development and infill, which concentrates the
growth and intensifies the land uses consistent with the availability of existing urban services and
infrastructure in order to conserve natural and man-made resources.

The project is an example how the seldom used PD-I can be utilized to create exciting developments that cannot fit into standard conditions.

- Policy 01.16.02 The City will encourage and implement the use of compact building design
  principles which preserve more open space, contain mixed use, support multi-modal
  transportation options, make public transportation viable, reduce infrastructure costs and take
  advantage of recycled building materials.
- The project will include bicycle parking, incorporate green building standards, the enhanced landscaped open space will complement the existing open space in the adjacent city park, and utilize existing infrastructure.
- **Policy 09.08.01** The City shall use its development code standards for the beach sand dune to assure proper location, vegetation, walkovers, etc., when private development takes place.

The proposed development is not located on a beach or sand dune.

• **Policy 10.01.03** The City shall coordinate and participate with Broward County in the sea turtle program including beach lighting regulations.

The proposed development will be developed consistent with the sea turtle lighting program.

• Policy 10.03.05 The City shall seek additional beach access in redevelopment.

The proposed development is not located on a beach. Therefore, the applicant cannot offer beach access as part of the proposed development.

• **Policy 10.04.02** Modify the Land Development Regulations to require beachfront properties to construct a sand dune system along the beach frontage as part of redevelopment.

The subject property is not a beachfront property.

• **Policy 11.04.05** To maintain and enhance the existing recreational facilities which provide physical or visual access to water.

The applicant has offered to work with the City to improve North Ocean Park, which provides physical access to the water.

• **Policy 11.05.03** To promote Pompano Beach as a year-round tourist destination (formerly 11.05.04).

The proposed application will likely provide near-beach amenities that will bolster Pompano Beach's image as a year-round tourist destination.


• **Objective Funding 11.06.00** - To seek a mixture of public and private funding sources for the acquisition, development, maintenance and programming of recreational facilities.

The Applicant is willing to work with the City to provide capital improvements to the adjacent city park.

 Objective 13.05.00 - To adequately fund the Capital Improvement Plan through a variety of funding sources including property taxes, impact fees, general revenues, state and county contributions, assessments, private contributions, and bonded indebtedness.

The project will generate extensive tax revenues which the city can utilize to implement a variety of programs.


## **EXHIBIT I**

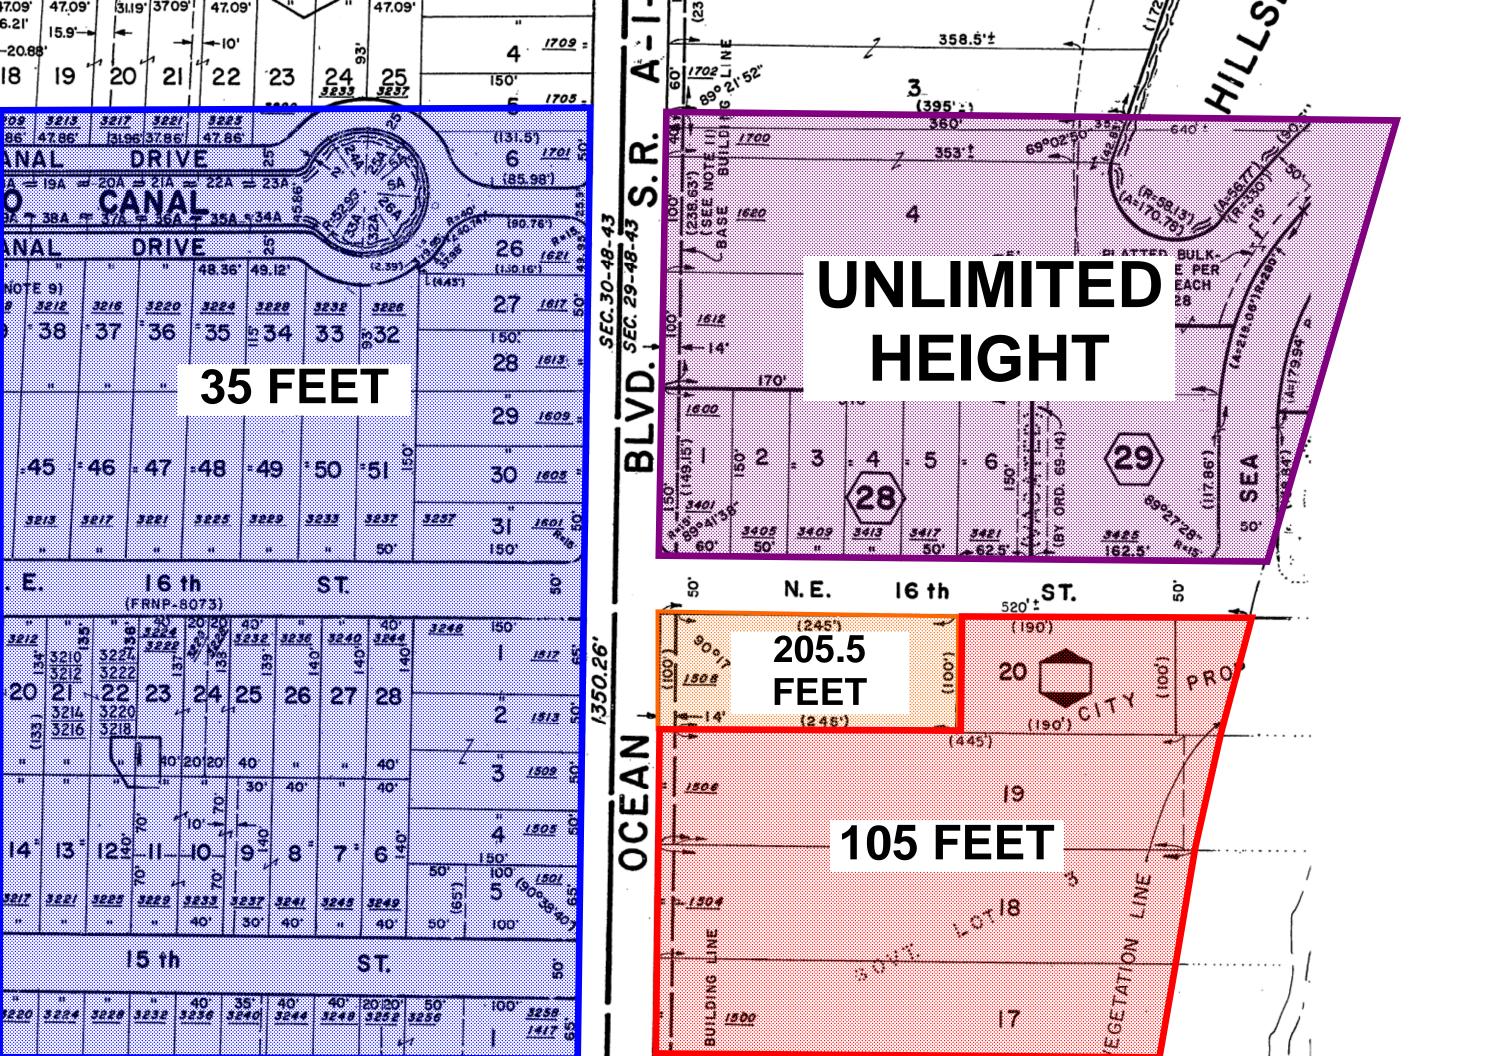

# **EXHIBIT J**

\*Exhibit J was removed from PD-I document

## **EXHIBIT K**

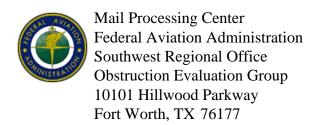

Aeronautical Study No. 2016-ASO-24552-OE Prior Study No. 2016-ASO-7295-OE

Issued Date: 10/12/2017

Mike Vonder Meulen Keith & Associates 301 East Atlantic Blvd. Pompano Beach, FL 33060

#### \*\* DETERMINATION OF NO HAZARD TO AIR NAVIGATION \*\*

The Federal Aviation Administration has conducted an aeronautical study under the provisions of 49 U.S.C., Section 44718 and if applicable Title 14 of the Code of Federal Regulations, part 77, concerning:

Structure: Building Ocean Park
Location: Pompano Beach, FL
Latitude: 26-15-06.98N NAD 83

Longitude: 80-05-10.92W

Heights: 10 feet site elevation (SE)

245 feet above ground level (AGL) 255 feet above mean sea level (AMSL)

This aeronautical study revealed that the structure would have no substantial adverse effect on the safe and efficient utilization of the navigable airspace by aircraft or on the operation of air navigation facilities. Therefore, pursuant to the authority delegated to me, it is hereby determined that the structure would not be a hazard to air navigation provided the following condition(s) is(are) met:

As a condition to this Determination, the structure is to be marked/lighted in accordance with FAA Advisory circular 70/7460-1 L Change 1, Obstruction Marking and Lighting, red lights - Chapters 4,5(Red),&12.

Any failure or malfunction that lasts more than thirty (30) minutes and affects a top light or flashing obstruction light, regardless of its position, should be reported immediately to (877) 487-6867 so a Notice to Airmen (NOTAM) can be issued. As soon as the normal operation is restored, notify the same number.

It is required that FAA Form 7460-2, Notice of Actual Construction or Alteration, be e-filed any time the project is abandoned or:

	At least 10 days prior to start of construction (7460-2, Part 1)	
X_	Within 5 days after the construction reaches its greatest height (7460-2, Part 2	2)

See attachment for additional condition(s) or information.

The structure considered under this study lies in proximity to an airport and occupants may be subjected to noise from aircraft operating to and from the airport.

This determination expires on 04/12/2019 unless:

- (a) the construction is started (not necessarily completed) and FAA Form 7460-2, Notice of Actual Construction or Alteration, is received by this office.
- (b) extended, revised, or terminated by the issuing office.
- (c) the construction is subject to the licensing authority of the Federal Communications Commission (FCC) and an application for a construction permit has been filed, as required by the FCC, within 6 months of the date of this determination. In such case, the determination expires on the date prescribed by the FCC for completion of construction, or the date the FCC denies the application.

NOTE: REQUEST FOR EXTENSION OF THE EFFECTIVE PERIOD OF THIS DETERMINATION MUST BE E-FILED AT LEAST 15 DAYS PRIOR TO THE EXPIRATION DATE. AFTER RE-EVALUATION OF CURRENT OPERATIONS IN THE AREA OF THE STRUCTURE TO DETERMINE THAT NO SIGNIFICANT AERONAUTICAL CHANGES HAVE OCCURRED, YOUR DETERMINATION MAY BE ELIGIBLE FOR ONE EXTENSION OF THE EFFECTIVE PERIOD.

This determination is subject to review if an interested party files a petition that is received by the FAA on or before November 11, 2017. In the event a petition for review is filed, it must contain a full statement of the basis upon which it is made and be submitted to the Manager, Airspace Policy & Regulation, Federal Aviation Administration, 800 Independence Ave, SW, Room 423, Washington, DC 20591.

This determination becomes final on November 21, 2017 unless a petition is timely filed. In which case, this determination will not become final pending disposition of the petition. Interested parties will be notified of the grant of any review. For any questions regarding your petition, please contact Airspace Regulations & ATC Procedures Group via telephone -- 202-267-8783 - or facsimile 202-267-9328.

This determination is based, in part, on the foregoing description which includes specific coordinates, heights, frequency(ies) and power. Any changes in coordinates, heights and frequencies or use of greater power, except those frequencies specified in the Colo Void Clause Coalition; Antenna System Co-Location; Voluntary Best Practices, effective 21 Nov 2007, will void this determination. Any future construction or alteration, including increase to heights, power or the addition of other transmitters, requires separate notice to the FAA. This determination includes all previously filed frequencies and power for this structure.

This determination does include temporary construction equipment such as cranes, derricks, etc., which may be used during actual construction of the structure. However, this equipment shall not exceed the overall heights as indicated above. Equipment which has a height greater than the studied structure requires separate notice to the FAA.

This determination concerns the effect of this structure on the safe and efficient use of navigable airspace by aircraft and does not relieve the sponsor of compliance responsibilities relating to any law, ordinance, or regulation of any Federal, State, or local government body.

This aeronautical study considered and analyzed the impact on existing and proposed arrival, departure, and en route procedures for aircraft operating under both visual flight rules and instrument flight rules; the impact on all existing and planned public-use airports, military airports and aeronautical facilities; and the cumulative impact resulting from the studied structure when combined with the impact of other existing or proposed structures. The study disclosed that the described structure would have no substantial adverse effect on air navigation.

An account of the study findings, aeronautical objections received by the FAA during the study (if any), and the basis for the FAA's decision in this matter can be found on the following page(s).

If we can be of further assistance, please contact Michael Blaich, at (404) 305-6462, or mike.blaich@faa.gov. On any future correspondence concerning this matter, please refer to Aeronautical Study Number 2016-ASO-24552-OE.

Signature Control No: 305138408-346089104

(DNH)

Mike Helvey Manager, Obstruction Evaluation Group

Attachment(s)
Additional Information
Map(s)

#### Additional information for ASN 2016-ASO-24552-OE

PMP = Pompano Beach Airpark Airport

ASN = Aeronautical Study Number

SIAP = Standard Instrument Approach Procedure

AGL = Above Ground Level

AMSL = Above Mean Sea Level

NM = Nautical Miles

ARP = Airport Reference Point

RWY = Runway

IFR = Instrument Flight Rule

This ASN is for a proposed building at height of 245 feet AGL, 255 feet AMSL.

The structure would be located approximately 1.37 NM east of the PMP ARP.

It would exceed the Obstruction Standards of Title 14, Code of Federal Regulations (14 CFR), Part 77 as follows:

Section 77.17 (a)(2) PMP  $\rightarrow$  Exceeds by 36 feet.

Section 77.19 (a) PMP: Horizontal Surface --- > Exceeds by 86 feet.

Part 77 Obstruction Standards are used to screen the many structures submitted in order to identify those which warrant further aeronautical study in order to determine if they would have significant adverse effect on protected aeronautical operations. While the obstruction standards trigger formal aeronautical study, including circularization, they do not constitute absolute or arbitrary criteria for identification of hazards to air navigation. Accordingly, the fact that a structure exceeds an obstruction standard of Part 77 does not provide a basis for a determination that the structure would constitute a hazard to air navigation.

Details of the structure were circularized to the aeronautical public for comment. No letters of objection were received during the comment period.

AERONAUTICAL STUDY FOR POSSIBLE INSTRUMENT FLIGHT RULES (IFR) EFFECT DISCLOSED THE FOLLOWING:

- > The proposed structure would have no effect on any existing or proposed IFR arrival/departure routes, operations, or procedures.
- > The proposed structure would have no effect on any existing or proposed IFR en route routes, operations, or procedures.
- > The proposed structure would have no effect on any existing or proposed IFR minimum flight altitudes.

AERONAUTICAL STUDY FOR POSSIBLE VISUAL FLIGHT RULES (VFR) EFFECT DISCLOSED THE FOLLOWING:

- > The proposed structure would have no effect on any existing or proposed VFR arrival or departure routes, operations or procedures.
- > The proposed structure would not conflict with airspace required to conduct normal VFR traffic pattern operations at any known public use or military airports.
- > The proposed structure would not penetrate those altitudes that are normally considered available to airmen for VFR en route flight.
- > The proposed structure will be appropriately obstruction marked and lighted to make it more conspicuous to airmen flying in VFR weather conditions at night.

The proposed structures' proximity to the airport was considered and found to be acceptable.


The impact on arrival, departure, and en route procedures for aircraft operating under VFR/IFR conditions at existing and planned public use and military airports, as well as aeronautical facilities, was considered during the analysis of the structure. The aeronautical study disclosed that the proposed structure would have no substantial adverse effect upon any terminal or en route instrument procedure or altitude.


The cumulative impact (IFR/VFR) resulting for the structure, when combined with the impact of other existing or proposed structures was considered and found to be acceptable.

Therefore, it is determined that the proposed structure would not have a substantial adverse effect upon the safe and efficient utilization of the navigable airspace by aircraft or on any navigation facility and would not be a hazard to air navigation.

#### TOPO Map for ASN 2016-ASO-24552-OE



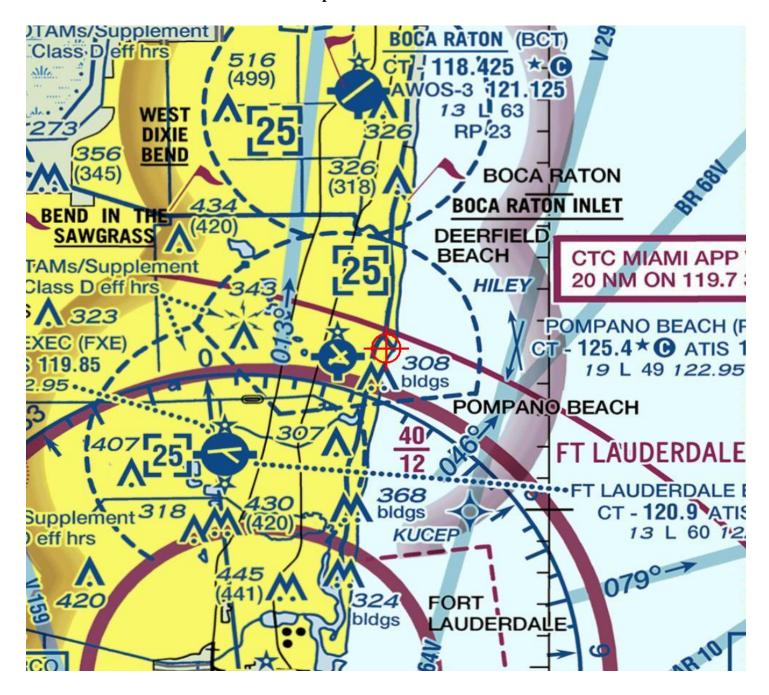

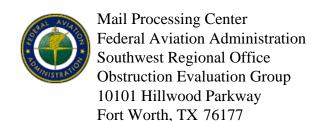

Aeronautical Study No. 2016-ASO-24552-OE Prior Study No. 2016-ASO-7295-OE

Issued Date: 06/10/2019

Mike Vonder Meulen Keith & Associates 301 East Atlantic Blvd. Pompano Beach, FL 33060

#### \*\* Extension \*\*

A Determination was issued by the Federal Aviation Administration (FAA) concerning:

Structure: Building Ocean Park
Location: Pompano Beach, FL
Latitude: 26-15-06.98N NAD 83

Longitude: 80-05-10.92W

Heights: 10 feet site elevation (SE)

245 feet above ground level (AGL) 255 feet above mean sea level (AMSL)

In response to your request for an extension of the effective period of the determination, the FAA has reviewed the aeronautical study in light of current aeronautical operations in the area of the structure and finds that no significant aeronautical changes have occurred which would alter the determination issued for this structure.

This extension is subject to review if an interested party files a petition that is received by the FAA on or before July 10, 2019. In the event a petition for review is filed, it must contain a full statement of the basis upon which it is made and be submitted to the Manager of the Airspace Policy Group. Petitions can be submitted via mail to Federal Aviation Administration, 800 Independence Ave, SW, Room 423, Washington, DC 20591, via email at OEPetitions@faa.gov, or via facsimile (202) 267-9328.

This extension becomes final on July 20, 2019 unless a petition is timely filed. In which case, this determination will not become final pending disposition of the petition. Interested parties will be notified of the grant of any review. For any questions regarding your petition, please contact Airspace Policy Group via telephone – 202-267-8783.

Accordingly, pursuant to the authority delegated to me, the effective period of the determination issued under the above cited aeronautical study number is hereby extended and will expire on 12/10/2020 unless otherwise extended, revised, or terminated by this office. You must adhere to all conditions identified in the original determination.

This extension issued in accordance with 49 U.S.C., Section 44718 and, if applicable, Title 14 of the Code of Federal Regulations, part 77, concerns the effect of the structure on the safe and efficient use of navigable airspace by aircraft and does not relieve the sponsor of compliance responsibilities relating to any law, ordinance, or regulation of any Federal, State, or local government body.

If we can be of further assistance, please contact our office at (847) 294-7575, or vivian.vilaro@faa.gov. On any future correspondence concerning this matter, please refer to Aeronautical Study Number 2016-ASO-24552-OE.

Signature Control No: 305138408-408026980

(EXT)

Vivian Vilaro Specialist

Attachment(s)

Map(s)

#### TOPO Map for ASN 2016-ASO-24552-OE



