## CITY OF POMPANO BEACH Broward County, Florida

AN ORDINANCE OF THE CITY COMMISSION OF THE CITY OF POMPANO BEACH, FLORIDA REZONING PROPERTY LYING BETWEEN NORTH OCEAN BOULEVARD AND NORTH POMPANO BEACH BOULEVARD, BOUNDED ON THE NORTH AND SOUTH BY NE THIRD STREET AND NE SECOND STREET, TO AMEND THE PD-I (PLANNED DEVELOPMENT INFILL DISTRICT) WITHIN THE ATLANTIC BOULEVARD OVERLAY DISTRICT, BY AND THROUGH MODIFICATION OF THE CURRENT APPROVED MASTER PD PLAN; PROVIDING FOR CONFORMANCE TO A PLANNED DEVELOPMENT PLAN AND STANDARDS; PROVIDING FOR SEVERABILITY; PROVIDING AN EFFECTIVE DATE.

WHEREAS, pursuant to law, ten (10) days' notice has been given by publication in a paper of general circulation in the City, notifying the public of this proposed ordinance and of a public hearing in the City Commission Chambers of the City of Pompano Beach, Florida; and

**WHEREAS,** a public hearing before the City Commission was held pursuant to the aforesaid notice, at which hearing the parties in interest and all other citizens so desiring, had an opportunity to be, and were, in fact, heard; now, therefore,

## BE IT ENACTED BY THE CITY OF POMPANO BEACH, FLORIDA:

SECTION 1. - FINDINGS: The City Commission finds as follows: that the rezoning of the property described herein is consistent with the Comprehensive Plan; that the rezoning complies with Section 155.3602., General Standards for All Planned Development Districts, as well as all other requirements of the Zoning Code; that the rezoning does not have a potentially injurious effect on land adjacent to the rezoned parcel; and that rezoning is reasonably related to the public health, safety and welfare.

SECTION 2. REZONING AND APPROVAL OF PLANNED DEVELOPMENT PLAN AND MASTER SITE PLAN: That the property more particularly described in Exhibit "A," attached hereto and made a part hereof ("Property), which Property is hereby rezoned from the present zoning classification of

PD-I (Planned Development-Infill) District by and through modification of the current approved Master PD Plan within the AOD (Atlantic Boulevard Overlay), as said zoning classification is defined in Section

155.3607., Planned Development-Infill, of the Code of Ordinances of the City of Pompano, Beach, Florida.

SECTION 3. Pursuant to the requirements of Section 155.3602 and Section 155.3607 of the Code of Ordinances of the City of Pompano Beach, Florida, the Planned Development Plan ("Master Site Plan") submitted for the Property, attached hereto and made a part hereof as Exhibit "B," is hereby adopted. All development of the Property shall proceed in accordance with the Plan, as approved, and Section

**SECTION 4**. That the Development Services Director is hereby directed to mark the zoning provided for in this Ordinance on the Official Zoning Map of the City of Pompano Beach.

SECTION 5. If any provision of this Ordinance or the application thereof to any person or circumstance is held invalid, such invalidity shall not affect other provisions or applications of this Ordinance that can be given effect without the invalid provision or application, and to this end the provisions of this Ordinance are declared to be severable.

**SECTION 6**. This Ordinance shall become effective upon passage.

155.3607 of the Code of Ordinances of the City of Pompano Beach.

PASSED FIRST READING this 26th day of September , 2017.

PASSED SECOND READING this 10th day of October , 2017.


AMAR FISHER, MAYOR

ATTEST:

ASCELETA HAMMOND, CITY CLERK

MEB/jrm 8/9/17

1:ord/2017-280

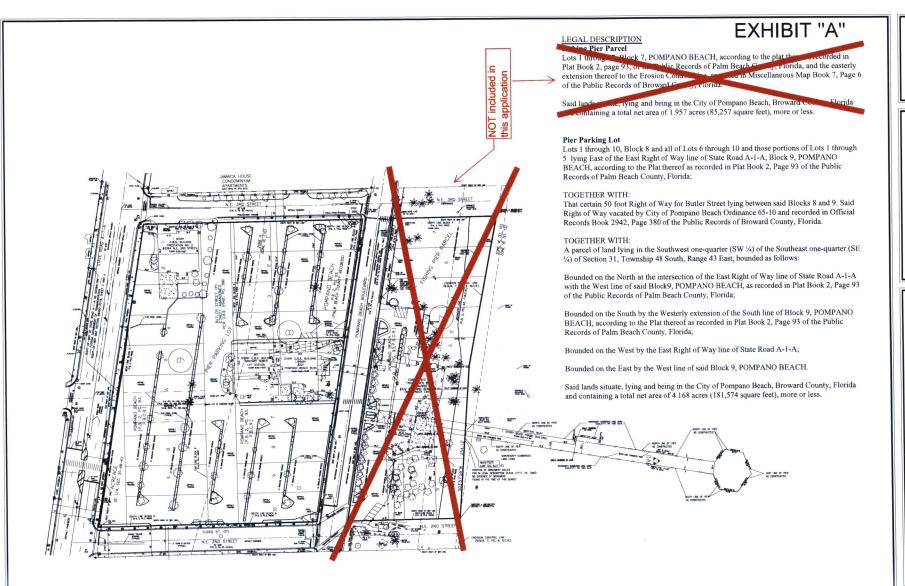

BOUNDARY EXHIBIT

SHEET 01 OF 01
PROJECT NUMBER
07470.05

SCALE 1"=100"
FIELD BOOK
DRAWI BY LP

CONSULTING ENGINEERS
SOLAND RAIGH STANDING BACK STANDING SACK TOPPLA 3300-6643
PORPHA 3300-6643
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**EAST** 

SECTION 31, TOWNSHIP 48 SOUTH, RANGE 43 POMPANO BEACH, BROWARD COUNTY, FLORIDA

## EXHIBIT "B"




## MASTER SITE PLAN REZONING

POMPANO BEACH, FL APRIL 18, 2017





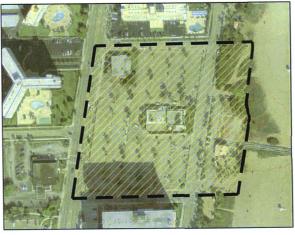



## INDEX OF DRAWINGS:

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L - 4.01	PHASING PLAN
L - 5.00	LANDSCAPE NOTES
L - 5.01	TREE PLAN
L-6.01	SHRUB PLAN









## EXHIBIT "B"







## Planning, Landscape Archite 1512 East Broward Boulevar Suite 110 Fort Lauderdale, FL 33301

CRAVEN THOMPSON & ASSOCIATES, INC.

BOUNDS + GILLESPIE ARCHITECTS, PLLC Architecture 7975 Stage Hills Boulevard, Suite 4 Memphis, TN 38133

Architecture 4304 NE 2nd Avenue Miami, FL 33137

Rev:	Date:	Description:	Ву
Δ	05/31/17	REZUNNIC AND BUILDING APPLICATION RESUBSITITAL	EDSA

MASTER SITE PLAN REZONING **EXISTING ZONING** MAP



Date: 1	APR 2017	Designed By:
Project N	: 113037	Drawn By:

Sheet Number:
L-0.01



**AERIAL MAP** 





ZONING MAP





LAND USE **LEGEND** 

LAND USE MAP



0

ZONING

**LEGEND** 









EDSA, INC. EOSA, INC. Planning, Landscape Architectur 1512 East Broward Boulevard Suite 110 Fort Lauderdale, FL 33301

CRAVEN THOMPSON & ASSOCIATES, INC. CIVIL Engineering 3663 NW 53rd Street Fort Lauderdale, FL 33309

BOUNDS + GILLESPIE ARCHITECTS, PLLC Architecture 7975 Stage Hills Boulevard, Suite 4 Memphis, TN 38133

GONZALES ARCHITECTURE

Rev:	Date:	Description:	Ву:
Δ	05/31/17	REZUMBNG AND BURLDONG APPLICATION PESSIBIRITIAL	EDSA

Sheet Title:
MASTER SITE PLAN REZONING ICW TO PIER PLAN



Date: 18 APR 2017	Designed By
Project No: 113037	Drawn By:

Sheet Number:

L-0.02











CRAVEN THOMPSON & ASSOCIATES, INC. Civil Engineering 3563 NW 53rd Street Fort Lauderdale, FL 33309

BOUNDS + GILLESPIE ARCHITECTS, PLLC Architecture 7975 Stage Hills Boulevard, Suite 4 Memphis, TN 38133

GONZALES ARCHITECTURE Architecture 4304 NE 2nd Avenue Miami, FL 33137

Rev:	Date:	Description:	Ву:
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Sheet Title:
MASTER SITE PLAN
REZONING EXISTING CONDITIONS





Date:	18 A	PR 2017	Designed By:
Project	No:	113037	Drawn By:

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BOUNDS + GILLESPE ARCHTECTS, PLLC
Architecture
7975 Stage + Hill Boulevard, Sulte 4
Memplet, TN 28133
CONZALES ARCHTECTURE
Architecture
450, N E Drd 4 overuse
Marri, F., 33137

Consultants:
EBSA, MC. decage Architecture, Urban Design
1612 Feel Emerated Booleand
5612 Feel Emerated Booleand
Feel Laudensian, FL 333091
CAMEN HOUSENA A ASSOCIATES INC.
CAREN HOUSENA A ASSOCIATES INC.
CAREN LOUGHISM, FL 33309
Feel Laudensian, FL 33309
Feel Laudensian, FL 33309

EXHIBIT "B"



pempano beach.

New Urban Communities

CASTER developers



MASTER SITE PLAN
REZONING
TREE DISPOSITION
LIST

L-0.10

Date: 18 APR 2017 Designed By Project No: 113037 Drawn By:

# 3 R D STREET **NW-PARCEL** EAST PARCEL SW-PARCEL

## **EXHIBIT "B"**









DSA. INC

CRAVEN THOMPSON & ASSOCIATES, INC. Civit Engineering 3563 NW 53rd Street Fort Lauderdale, FL 33309

Architecture 7975 Stage Hills Boulevard, Suite 4 Memphis, TN 38133

SONZALES ARCHITECTURE Architecture 4304 NE 2nd Avenue Miaml, FL 33137

Rev:	Date:	Description:	By:
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MASTER SITE PLAN REZONING TREE DISPOSITION PLAN



Date: 18 APR 2017 Designed By: Project No: 113037 Drawn By:

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TREE DISPOSITION NOTES:

- REFER TO THE TIRE DISPOSITION TABLES ON LO. 10 FOR REFERENCE.

  2. THE CONTRACTOR SHALL CLAL FOR MID ATTEM ON MERFECTION OF
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  INCLUDING BUT NOT LIMITED TO IDENTIFICATION OF THESE AND POTENTIAL
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- PHOTICITIVE BARRIERS AND UNIT HE UNSTYLE. OF THESE STRUCK ALL, SILS. THEE PROTECTION BARRIERS SHALL BE INSTALLED PRIOR TO COMMENCEMENT OF DEMOLITION AND MAINTAINED THROUGHOUT CONSTRUCTION.

  5. ALL TREES SUBJECT TO ENGOGNEHMENT INTO THE RODIZZONE, DUE TO PROPOSED CONSTRUCTION, SHALL BE ROOT FRINGED IF FROM THE PARAMENTE LODG ON TRIBION AS BOOT FRINGED.

- PARCHART EDGE OR TRENCH AS DIOCATED ON THE DRAWNINGS AND HERBIT.

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- SO HAMSPLANINGS STANLANDS, ST-LOWAN THE PREPERFULES, SE-DEPHITONIS, STANSPLANTING PRACTICES.

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- NATERING: S.A. ALL TREES TO BE RELOCATED ARE TO BE PROVIDED WITH AN
- 5.4 ALL TREES TO BE RELOCATED ARE TO BE PROVIDED WITH A AUTOMATO REGISTATION STEEL MICHOPHOYOUSES SILBIBIERE HEADS FED BY POP BY TO EACH THEE. 8.8 THE CONTINCTOR SHALL VERPE A SOURCE OF MUNICIPAL OR WELL WATER AND PROVIDE FOR A TEMPORARY MEETE TO OPERATE THE PROBACINOW WITH TO BE THE MEETE FOR SALT CONTINUE IF WELL WATER IF LEVELS ARE NOT CONDUCING TO THAT MATERIAL GROWN, AM A TEMPORE SOURCE OF WHITE SHALL BE UTILIZED AT
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  NO ADDITIONAL EXPENSE.
  SC. PROVIDE RINGSATION TIMER, OR BATTERY POWERED VALVE TO
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  AUTOMATIC SYSTEM SHALL NOT BE ALLEMADE, HAWNER HAND
  WATERING SHALL BE PERFORMED TO AVOID LAPSES SHALLD THE
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- BARRIAGES
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   (TWO FEET) OUTSIDE. THE TREE DRIP LINEEDGE OF TREE CAMPAY,
   PRIOR TO ANY CONSTRUCTION ACTIVITY.
   B. BARRIAGE ALL EXISTING TREES AND PAUM SWITH SXY FOOT (H)
   CHANLIN REVISIC ON OTHER BARRIAGEA PREPAYED BY OWNER.
   ROOT PRIMING TECHNOLINE.
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   TALL ALL TREES SHALL BE EXCLAVITED BY DIGGING A TRENZH A MINIMUM
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- 11.A. ALL BROADLEAF TREES ARE TO BE RELOCATED SHALL BE MAINTAINED FOR A MINIMUM OF TWELVE (12) WEEKS AFTER ROOT PRUNING PRICE TO RELOCATION.




EXISTING PALM/TREE - PROTECT IN PLACE






EXISTING PALM/TREE - RELOCATE EXISTING PALM/TREE - REMOVE

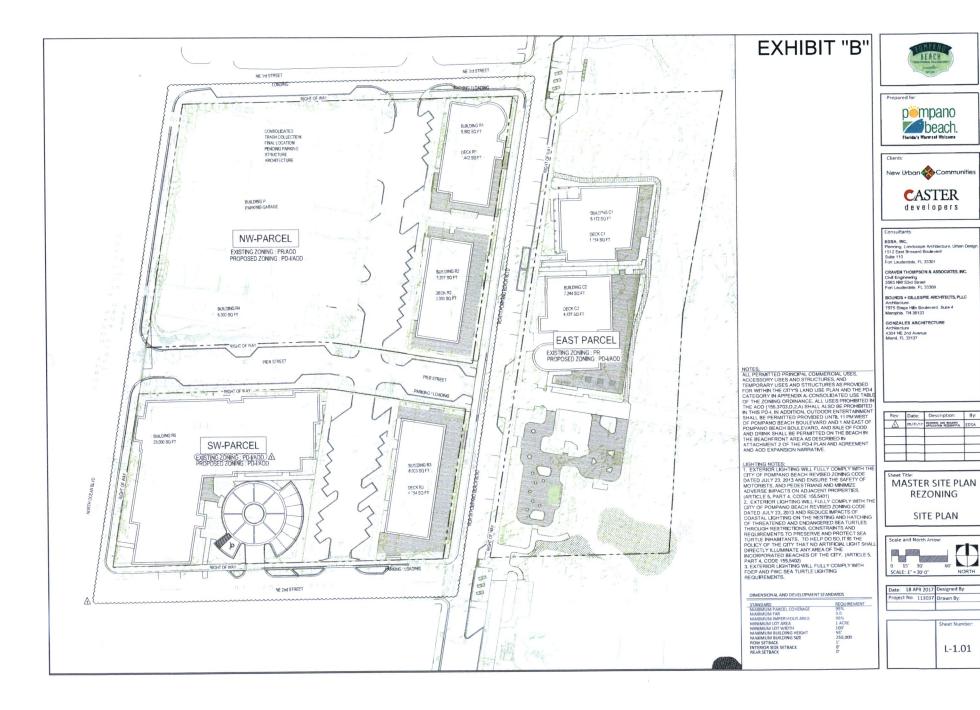


NORTH

Drawn By:

L-1.01

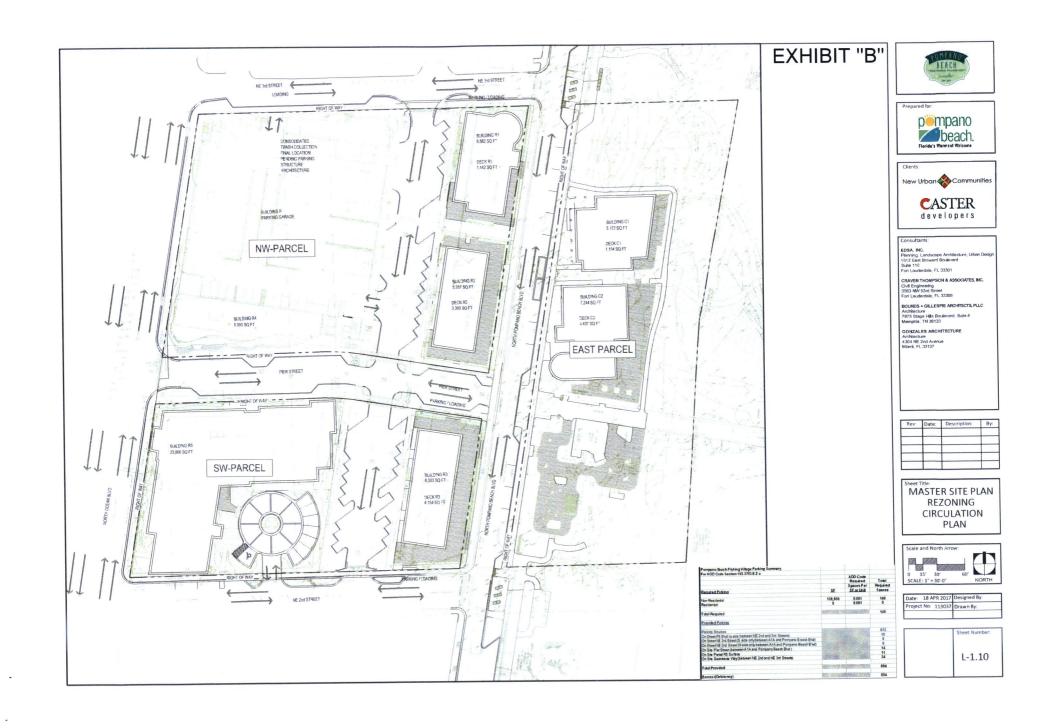

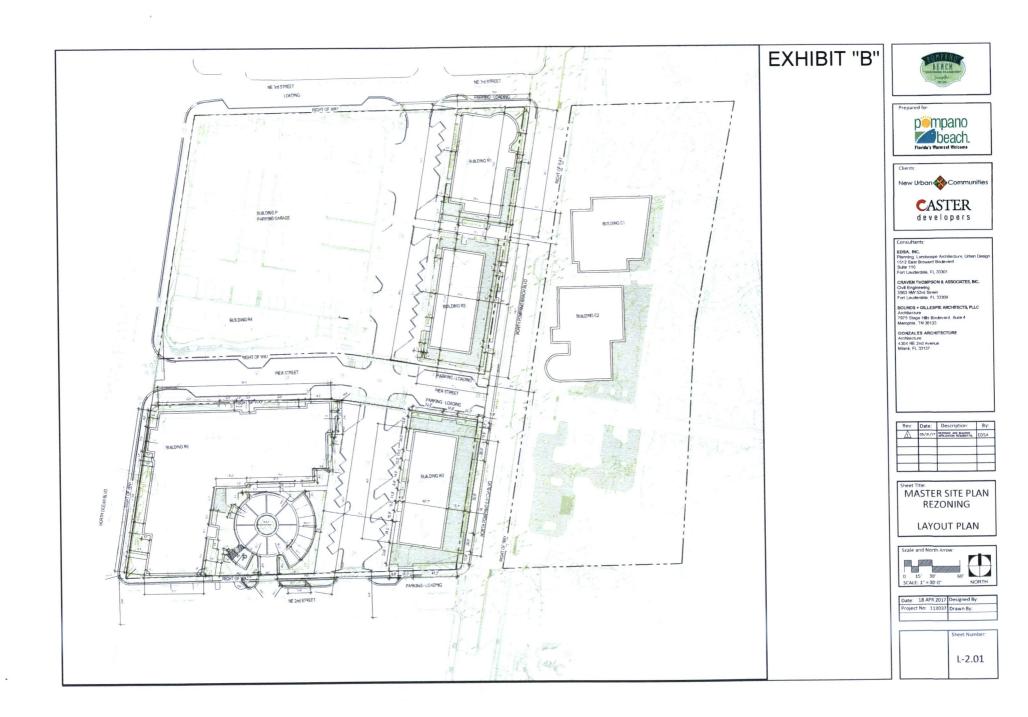









Consultants:
EDSA, INC.
Planning, Landscape Architecture, Urban Designation
1512 East Broward Boulevard
Suite 110

CRAVEN THOMPSON & ASSOCIATES, INC.
Civil Engineering

BOUNDS + GRLLESPIE ARCHITECTS, PLLC

Architecture 7975 Stage Hills Boulevard, Suite 4 Memphis, TN 38133

GONZALES ARCHITECTURE Architecture 4304 NE 2nd Avenue Miami, FL 33137


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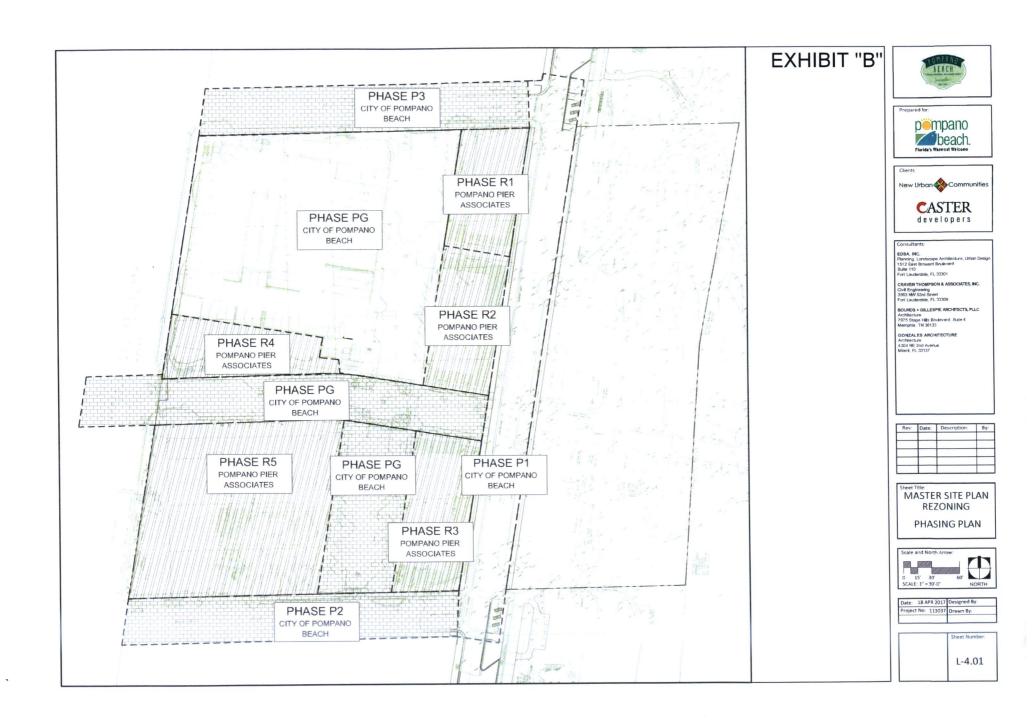
MASTER SITE PLAN
REZONING
EXISTING
COVERAGE



Date:	18 A	PR 2017	Designed By:
Project	No:	113037	Drawn By:

Sheet Number:



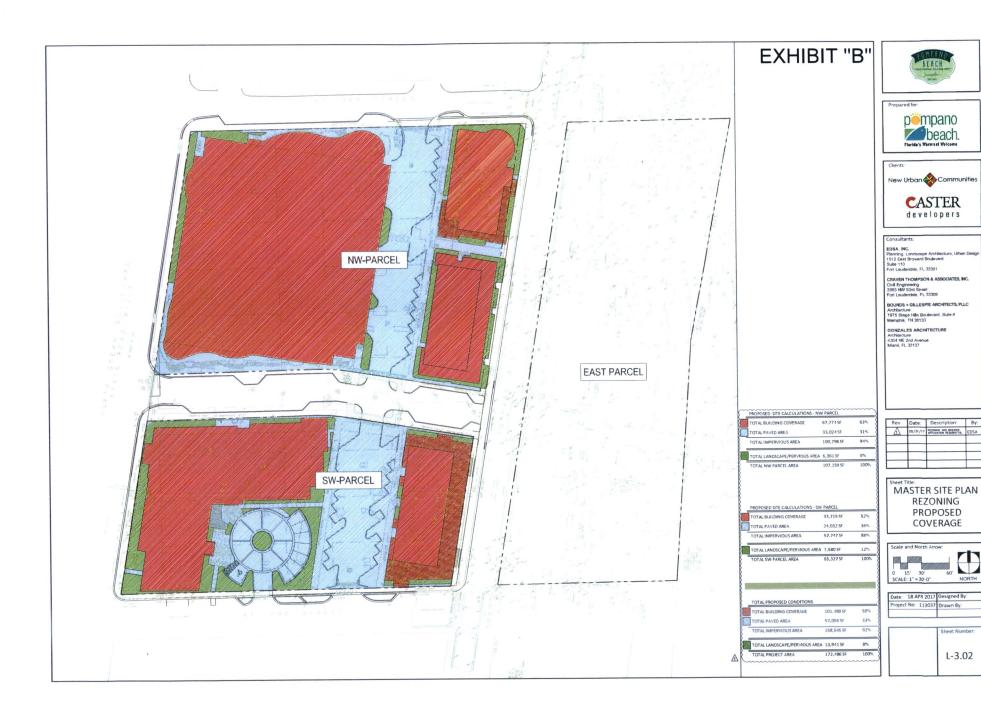

## PLANTING NOTES:

- ALI PLANTS FIGURE FIGURE OF STRONG MATERIAL FREE OF PLACIE AND SIGNESS. ALL PLANTS MUST BE IN COMMETE AND STROT ACCORDANCE WITH ARTICLE BY, 1 OF FLORIDA'S COULTY STANDARDS FOR MURRERY PLANTS PLANTS PLANTS PLANTS FOR STANDARD FOR MURRERY PLANTS PLANTS FOR SIGNESS. AND SOME PASTANCES THE PLANT MUST BE OF SUPERIOR QUALITY THAN NO. 110 BE ARILE TO ACHEVIE THE MINIMAL RECURREMENT FOR THIS PROJECT.
- THE CONTRACTOR IS RESPONSIBLE FOR THE PLANTS MEETING THE SPECIFICATIONS AS NOTED PRIOR TO THEIR INSTALLATION. THE CONTRACTOR MUST IMMEDIATELY REMOVE ANY PLANT THAT DOES NOT MEET THE SPECIFICATIONS.
- 3. ALL ROOT BALLS MUST BE IN ACCORDANCE TO THE SIZE STANDARDS ESTABLISHED IN "AMERICAN STANDARDS FOR
- THE CONTRACTOR MUST PRESENT TO THE LANDSCAPE ARCHITECT THE INSPECTION CERTIFICATE FROM THE NURSERY AND/OR THE STATE OF ALL PLANTS TWO (2) WEEKS PRIOR TO COMMENCEMENT OF WORK.
- 5. ALL PLANTS MUST BE PROTECTED DURING THEIR TRANSPORT AND TAKEN TO THE SITE COVERED WITH A CLOTH FOR SHADE R OTHER PREVENTIVE FORM TO PROTECT THE PLANTS AGAINST WIND BURN
- 6. THE CONTRACTOR MUST VERIFY ALL INFORMATION ON SITE BEFORE INSTALLATION BEGINS. ALL EXISTING PLANTS MUST REMAIN INTACT AND UNDISTURBED UNLESS IT IS SPECIFIED IN THE PLANS.
- ANY SUBSTITUTION OF SIZE AND/OR PLANT TYPE MUST BE PRE-APPROVED BY THE LANDSCAPE ARCHITECT. ALL PLANTS ARE SUBJECT TO THE APPROVAL OF THE LANDSCAPE ARCHITECT BEFORE THEY ARE PLANTED.
- 8. THE LANDSCAPE CONTRACTOR MUST PLACE STAKES ON THE PLANT LOCATION BEFORE THE PLANTING BEGINS FOR REVIEW ND APPROVAL BY THE LANDSCAPE ARCHITECT
- 9. ALL TREES MUST HAVE STRAIGHT, LEAFY TRUNKS, AND MUST MEET ALL THE SPECIFIED REQUIREMENTS.
- 10. BEFORE CONSTRUCTION BEGINS, THE CONTRACTOR IS RESPONSIBLE FOR LOCATING ALL UNDERGROUND UTILITIES AND MUST AVOID DAMAGING ANY SERVICES DURING CONSTRUCTION. IF ANY DAMAGE OCCURS BY FAULT OF THE CONTRACTOR THE NECESSARY REPARA WIST TAKE PLACE AT THE CONTRACTORS EXPENSE AND UNDER THE SUFFERINSHOOT OF THE
- INSTALLATION -ALL PLANTS MUST BE INSTALLED PROFESSIONALLY AND WITH GREAT CARE AND OF THE QUALITY PREVIOUSLY DESCRIBED. ALL LANDSCAPE ELEMENTS MUST BE INSTALLED IN A WAY TO MEET ALL REQUIRED CODES AND ORDINANCES.
- 12. TYPICALLY, THE PLANTING OF SHRUBS AND GROUNDCOVER ARE SHOWN AS PLANTING BED LAYERS. THE PLANTS MUST BE PLACED IN A TRANSQUAR SPACING CONFIDURATION (RREQULAR SPACING) AS SHOWN IN THE PLANTING DETAILS. THE DIMENSIONS FROM DETAILE TO CENTER (IC.) OF THE PLANTS CAN BE FOUND IN THE PLANT IL ST.
- 13. THE CONTRACTOR MUST SECURE THE DRAINAGE AND PERCOLATION OF ALL PLANTING WELLS PRIOR TO THE PLANT THE CONTRACTOR WAS ESCORED THE CONGREGOR AND PRECIDENCE OF PERSONS OF THE CONTRACTOR AND THE CONTRACTOR STEEL ALL HELD SHOTH HATER BEFORE PLANTING TO MAKE SURE THAT DRAMAGE AND PERCOLATOR AND FEASING AND PLANTING THE CONTRACTOR SPESIONISE. TO REPLAY TO ACCOUNT HE HAS THE CONTRACTOR SPESIONISE. DRAINAGE CONDITIONS.
- 14. ANY TREE THAT HAS BEEN PLANTED IN A GROW BAG OR SIMILAR MATERIAL MUST HAVE THE BAG COMPLETELY REMOVED
- 15. THE TOP HALF PART OF THE BURLAP HAS TO BE CUT OR REMOVED SURROUNDING THE TRUNK FROM THOSE FLANTS THAT HAVE BURLAP OR ARE INSIDE BADS, IT SHOULDN'T BE TOTALLY REMOVED. WHE CAGES STRAPS, ETC. SHOULD BE CUT AND REMOVED BEFOR INSTILLATION.
- 16. THE CONTRACTOR SHOULD REPLACE ANY PLANT THAT IS NOT APPROVED WITHIN A WEEK OF BEING NOTIFIED.
- 17. THE CONTRACTOR SHOULD REFER TO THE LANDSCAPE PLANTING DETAILS. PLANT LIST, NOTES AND PLANTING ECIFICATIONS FOR COMPLETE INSTRUCTIONS ON THE LANDSCAPE PLANTING

FERTILIZATION
PAINS 13-31 SI ULS LOWER ELEMENTS -SLOW DISCHARGE 0,2 KG FERTILIZER BY 10M REGULATOR
SHRUBS AND GROUNDCOMER SI-14-10 PLUS LOWER ELEMENTS-SLOW DISCHARGE 0,2 KG FERTILIZER BY 10M2
TREES 8-6-8 PLUS LOWER ELEMENTS -SLOW DISCHARGE 0,2 KG FERTILIZER BY 10M REGULATOR
GRASS 16-4 PLUS LOWER ELEMENTS -SLOW DISCHARGE 0,3 KG FERTILIZER BY 100 M2 "THE COST OF THE LANDSCAPE FERTILIZER PREVIOUSLY DESCRIBED SHOULD BE INCLUDED IN THE PRICE OF THE PLANT. 19 PREPARATION AND MIXTURE OF THE PLANT SOIL.

A PRIVINGUINDUP IMMUFACTURED BY UNINSMITO CORP) OR SIMUAI RESTICIDE APPROVED ACCROBING TO THE PORCENTIAGE AND SECURICATIONS BY THE MANUFACTURER WITHIN THE LIMITS OF ALL THE AREAS THAT WILL BE PLANTED, PROTECT ALL PLANTS FROM OVERWATERING OR WATER WITHIN THE ROOT ZONE. THE CONTRACTOR MUST MAKE SURE TO ERRADICATE ALL WEEDS.

- . B. REFORE REPLACING THE SUPERIOR PLANT SOIL. THE SURFACE MUST BE RAKED TO REMOVE ALL ROCKS (25 MM III) IETER OR GREATER), DEBRIS, GARBAGE AND REMAINS FROM PLANTS THAT WERE REMOVE
- C. RAKE THE SUBSOIL TO A DEPTH OF 75 MM.
- D. THE CONTRACTOR MUST APPLY PRE-EMERGENT PESTICIDE APPROVED ACCORDING TO THE PORCENTAGES AND SPECIFICATIONS OF THE MANUFACTURES
- F. THE PLANT SOIL MIX FOR TREES SHRURS AND GROUNDCOVER SHOULD BE THOROUGHLY PREPARED CONSISTING OF ROYAL PALMS
  60% CIEAN SAND D.O.T.
  40% SUPERFICIAL LAYER OF SOIL/COMPOSED OF APPROVED SOLID WASTE

90% CLEAN SAND D.O.T

10% SUPERFICIAL LAYER OF SOIL/COMPOSED OF APPROVED SOLID WASTE

3. SHRUBS AND GROUNDCOVER

3. SRRUBS AND GROUNDCOVER.

70% CLEAN SAND D.O.T.

30% SUPERRICUAL LAYER OF SOIL ICOMPOSED OF APPROVED SCLID WASTE.

THE CONTRACTOR MUST PRESENT SAMPLES OF THE PLANT 501 L MIXT PREPARED IN THE LABORATORY TO THE LANDSCAPE ARCHITECT FOR APPROVAL.

- F THE MIX COMPOSED OF WASTE SHOULD BE FREE OF NEMATODES THAT COULD BE PERJUDICIAL TO PLANT GROWTH, MUST BE OF UNIFORM QUALITY AND SHOULD HAVE A PH VALUE BETWEEN S.3 AND 6.5 (AS DETERMINED ACCORDING TO ASTM E70) FLORIDA MOSS MUST BE STERILIZED TO BE FREE OF ALL VIABLE MUT GRASS AND OTHER UNDESIRABLE WEEDS.
- G. SUPERFICIAL LAYER OF FLANT SOIL SHOULD BE NATURAL, FERTILE. AND CAPABLE TO SUSTAIN THE VIGOROUS GROWTH OF PLANTS. IT MUST HAVE A LINKORIN COMPOSITION MUSED WITH SURSOIL. IT MUST BE REFEL OF ROCKS, LUMPS. LIVE PLANTS AND ROOTS. BRANCHES AND OTHER FOREION MATERIAL, EXTEND THE SUPERFICIAL LAYER OS MUNK TO A MINIMUM LIVETH OF TS MIN JACKSOS ALL AREAS AND 150 MIN BY HE THE PLANTING BEST FOR SHRUBS AND GROUNDCOVER. REMOVE ALL ROCKS AND OTHER OBJECTS WITH MORE THAN 25MM IN DIAMETER.
- OTH THE SUPERFICIAL LAYER OF PLANT SOIL TO IOOMM BELOW THE EDGES OF THE ADJACENT PAVEMENT.
- I. THE FINAL GRADING OF THE PREPARED SUPERFICIAL LAYER OF PLANT SOIL SHOULD BE A SMOOTH AND EVEN SURFACE TO MAKE SURE THAN THERE IS POSITIVE DRAINAGE AWAY FROM ANY STRUCTURES AND ELIMINATE ANY LOW AREAS THA CAN COLLECT WATER
- J. SMOOTH THE SUPERFICIAL LAYER OF PLANT SOIL MIX TO 150 MM BELOW THE FINAL LEVEL IN THE GRASS AREAS,
- K, THE SUPERFICIAL LAYER OF PLANT SOIL SHOULD NOT HAVE HIGH LEVELS OF ACID OR ALCALINE NOR CONTAIN ANY K. THE SUPERFICUL LAYER OF PLANT SOL SHOULD NOT HAVE HIGH LEVELS OF A CHALLAURE CONTOURNIAN AWAY.

  TODICS SUBSTANCES THAT COULD BE PLANDROUS TO PLAND ROWTH. THE PHILED'S HOULD BE ENTWEST HE PLANDROUS OF SOLD SET OF SOLD SE
- 20. THE PRACTICE OF STAKING SHOULD NOT ALLOW NAILS, SCREWS, WIRES, ETC. TO PENETRATE THE OUTER SURFACE OF THE TREES OR PALMS, THE TREES OR PALMS THAT ARE REJECTED DUE TO THIS PRACTICE SHOULD BE REPLACED IN THE
- 21. THE CONTRACTOR MUST LAY FERTILIZER MIXED WITH MALALEUCA MUILCH FREE OF ANY WEEDS THROUGHOUT ALL PLANTING AREAS AT A NINIMUM DEPTH OF 75 MM.
- THE CONTRACTOR IS RESPONSIBLE OF COMPLETELY MAINTAINING THE PLANTING AREAS (INCLUDING WATERING, SPRAYING, FERTILIZING, MOWING, ETC.) UNTIL THE WORK HAS BEEN ACCEPTED COMPLETELY UNTIL THE END OF THE PERIOD.
- 23. ESTABLISHED BY THE ENGINEER AND LANDSCAPE ARCHITECT FOR THE PROJECT.
- 24. THE CONTRACTOR MUST GUARANTEE ALL THE PLANTS FOR A 90 DAY SETTLING PERIOD AFTER THE COMPLETION DATE.
- 25. THE CONTRACTOR MUST REQUEST INSPECTION OF THE PROJECT IN WRITING, IF ALL WORK IS SATISFACTORY AND COMPLETE THE CONTRACTOR MUST REQUEST INSPECTION OF THE PROJECT IN WHITIMS, IF ALL WORK IS SKIPPACIOTY AND COMPLETE
  ACCORDING TO THE CONDITIONS OF THE CONTRACT DOCUMENTS, THEN THE COMPACE AND THE LANDSCAPE ARCHITECT MUST
  DECLARE THE PROJECT COMPLETE. THIS DECLARATION WILL CONSTITUTE AS THE BEGINNING OF THE GUARANTEE PERIOD.
- 26. DURING THE REMOVAL OF THE STAKES OR STRAPS FOR THE TREES AND PALMS AFTER THE INSTALLATION PERIOD WILL BE
- 27. ALL PLANTS MUST BE OF FLORIDA QUALITY NO. FOR BITTER IN THE MOMENT OF INSTALLATION AND SHOULD BE AMMITAINED IN THE SME CONDITION UNITL. THE PROJECT HAS BEEN ACCEPTED. IF THE PLANTS FALL BELOW QUALITY DURING THE MANTENINES PERIOD THEY WILL BE REJECTED AND MIST BE REPLACED.

BEACH









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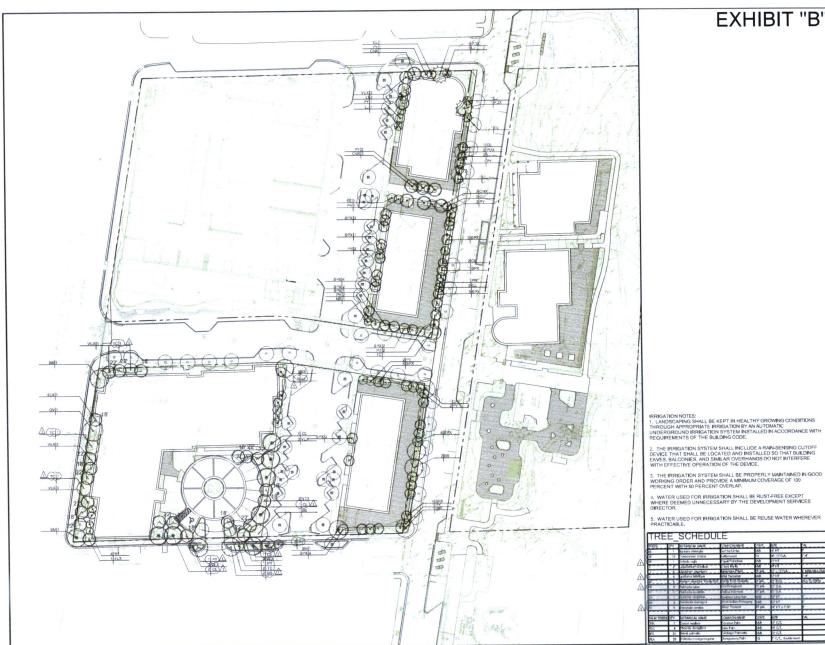
MASTER SITE PLAN

Scale and North Arrow

REZONING LANDSCAPE DETAILS

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## EXHIBIT "B"







## Consultants

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Sheet Title:
MASTER SITE PLAN REZONING

TREE PLAN



30′ 60′		
1" = 30'-0"	NO	RTH

Date:	18 A	PR 2017	Designed By:	
Project	No:	113037	Drawn By:	

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## EXHIBIT "B" IRRIGATION NOTES: 1. LANDSCAPING SHALL BE KEPT IN HEALTHY GROWING CONDITIONS THROUGH APPOPRIATE IRRIGATION BY AN AUTOMATIC. UNDERGROUND IRRIGATION SYSTEM INSTALLED IN ACCORDANCE WITH REQUIREMENT SO IT HE BUILDING CODE. 2. THE IRRIGATION SYSTEM SHALL INCLUDE A RAIN-SENSING CUTOFF DEVICE THAT SHALL BE LOCATED AND INSTALLED SO THAT BUILDING EAVES, BALCOMIES, AND SIMILAR OVERHANGS DO NOT INTERFERE WITH EFFECTIVE OPERATION OF THE DEVICE. 3. THE IRRIGATION SYSTEM SHALL BE PROPERLY MAINTAINED IN GOOD WORKING ORDER AND PROVIDE A MINIMUM COVERAGE OF 100 PERCENT WITH 50 PERCENT OVERLAP. 4. WATER USED FOR IRRIGATION SHALL BE RUST-FREE EXCEPT WHERE DEEMED UNNECESSARY BY THE DEVELOPMENT SERVICES DIRECTOR. 5. WATER USED FOR IRRIGATION SHALL BE REUSE WATER WHEREVER PRACTICABLE. SHRUB\_SCHEDULE Chrysobalanus Icaco Performitir Ped Tip Coccelum Corps coolinus Icaco Performitir Horizontal Coccelum





Chents:

New Urban Communities

CASTER

developers

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Sheet Title:
MASTER SITE PLAN
REZONING
SHRUB PLAN



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